



Project No. 27339


PROPOSED NEW K-9 (600 STUDENTS) CORE SCHOOL Design Development Report

November 12, 2007

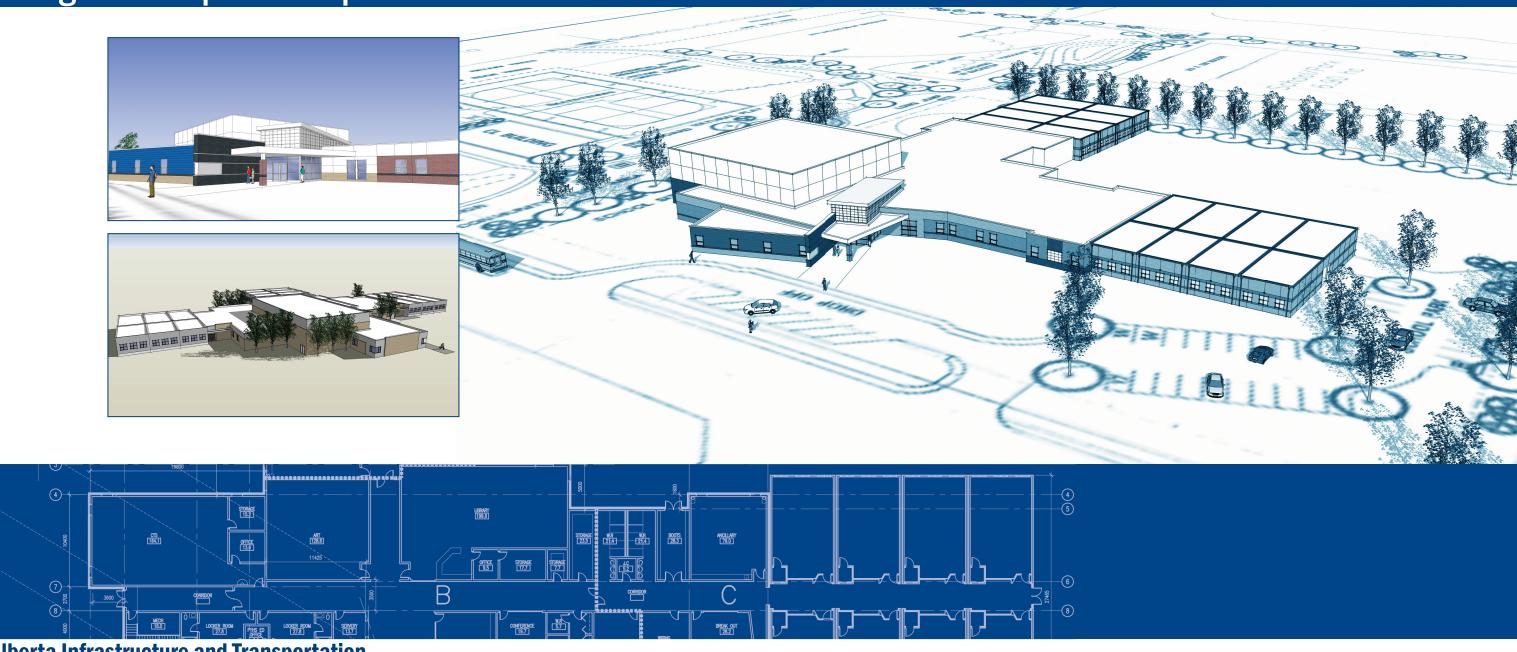

Alberta Infrastructure and Transportation

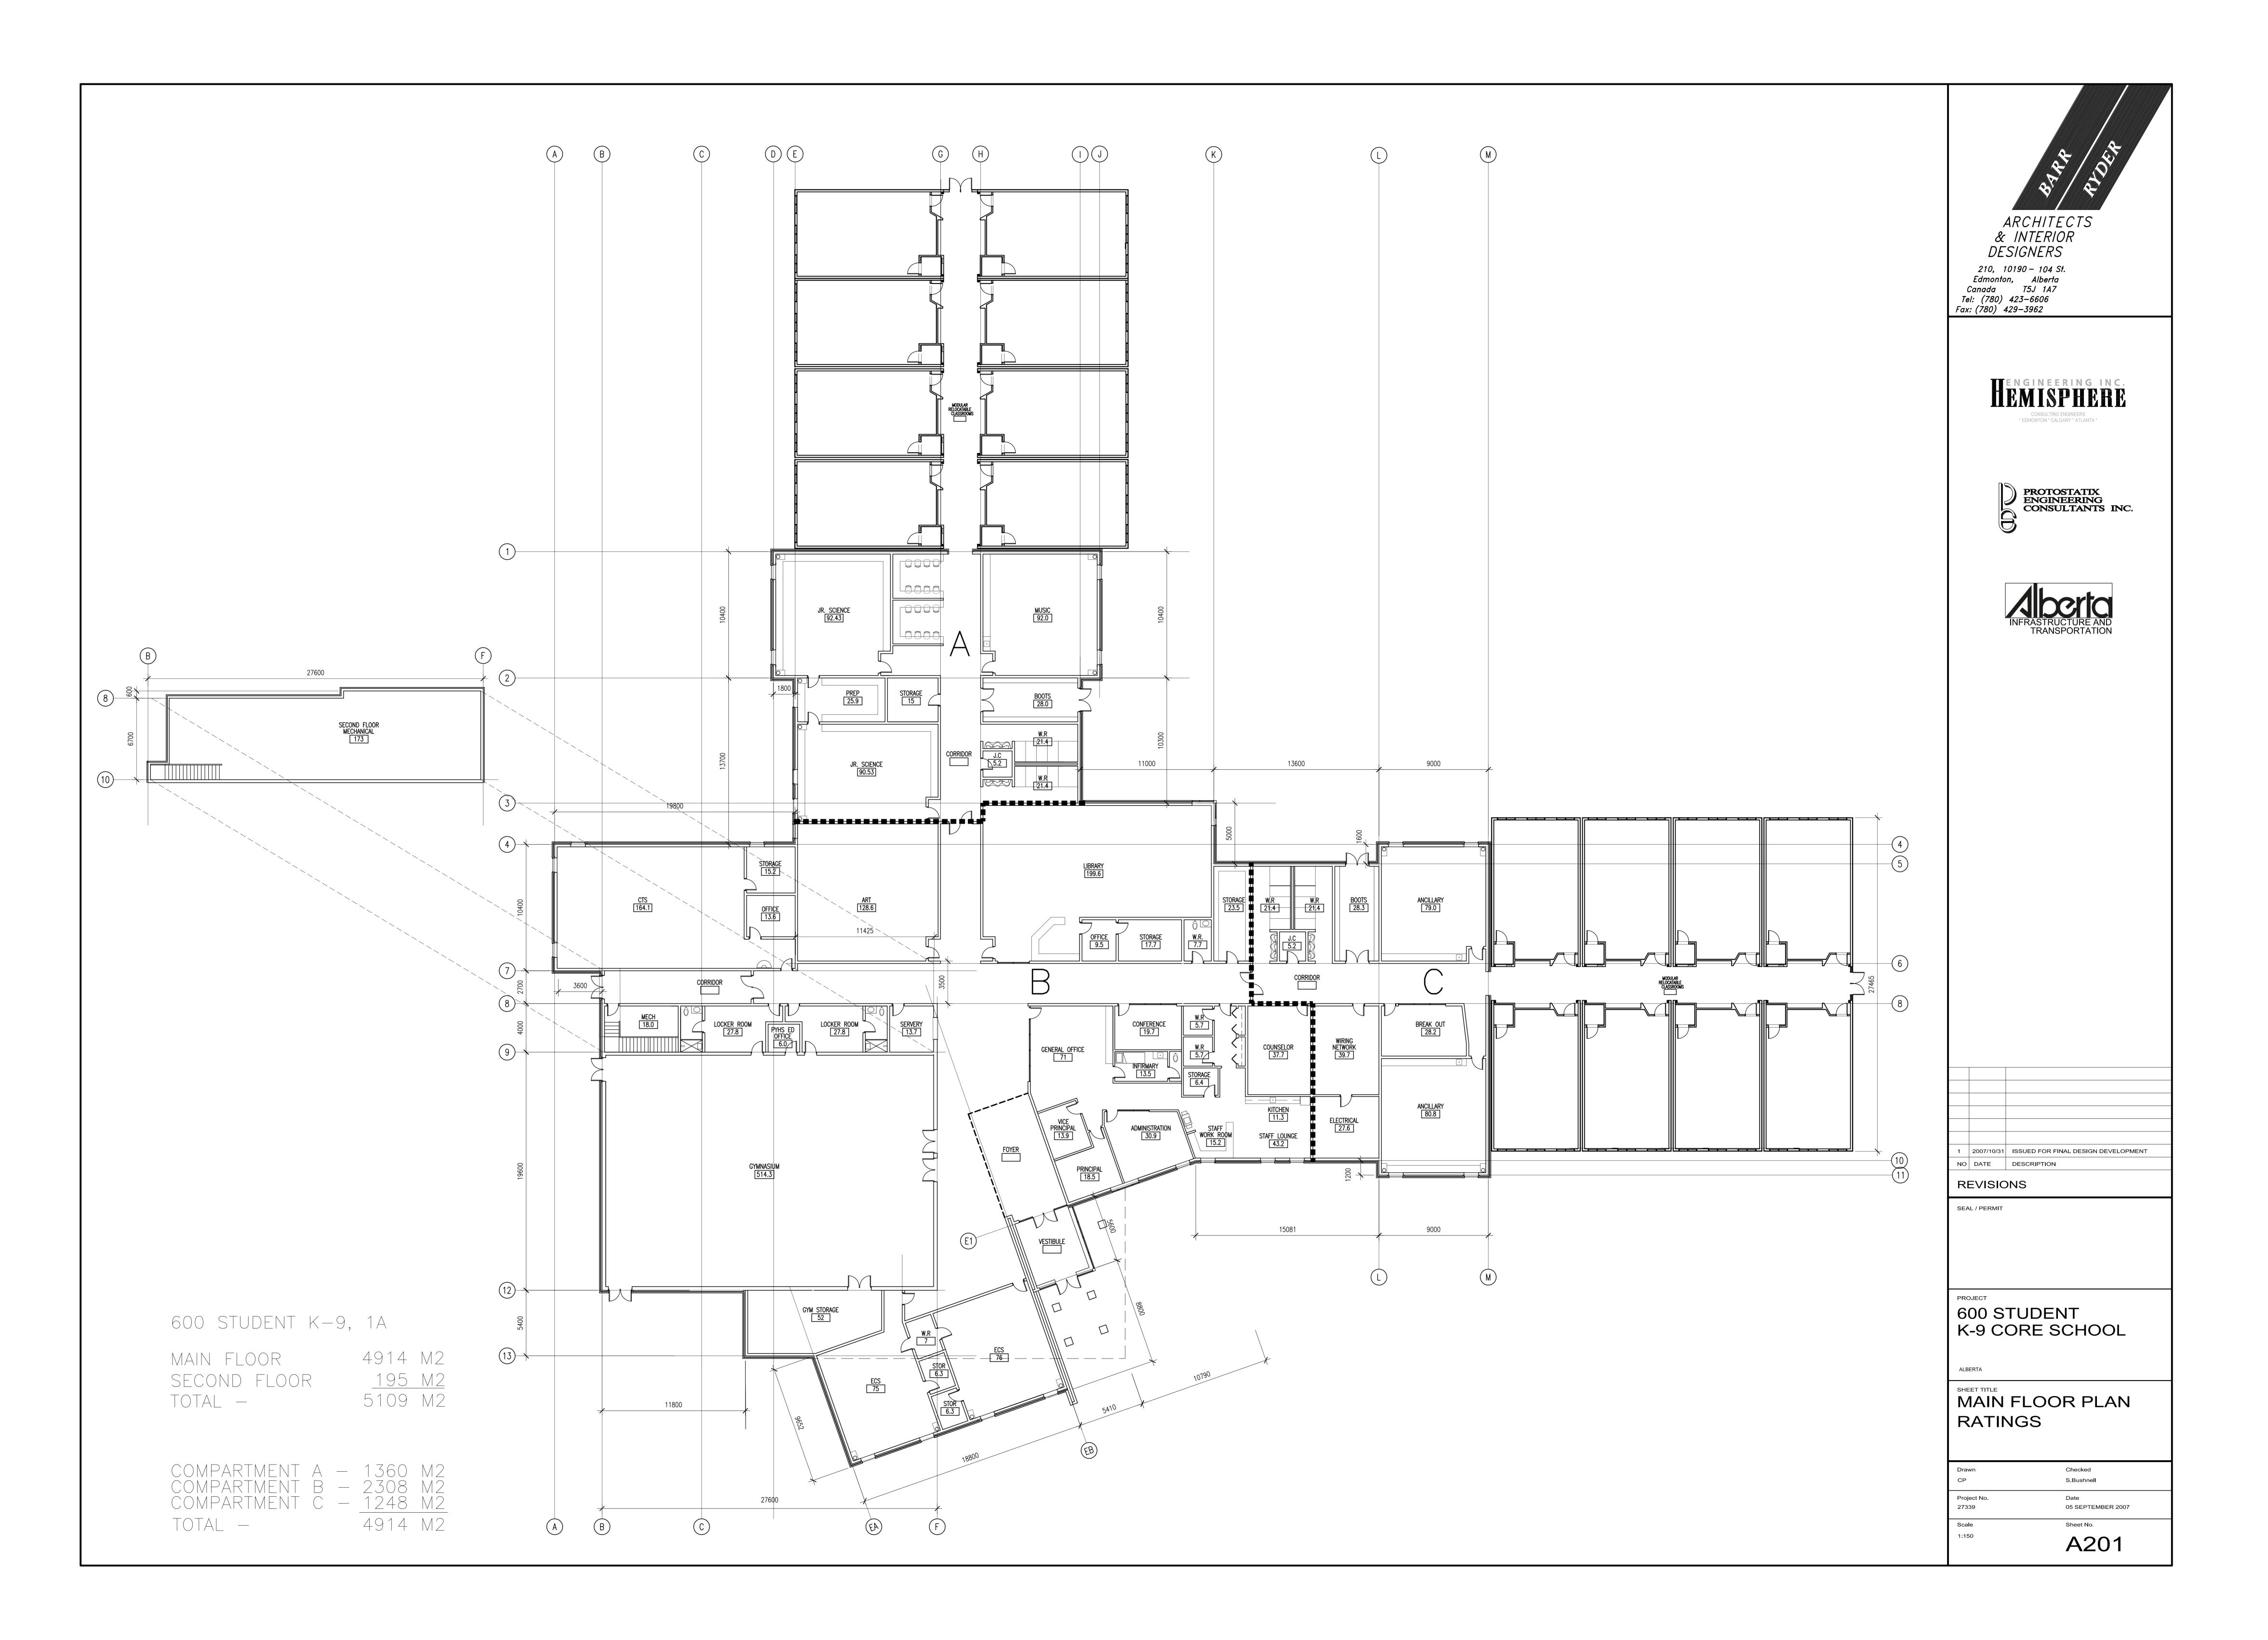

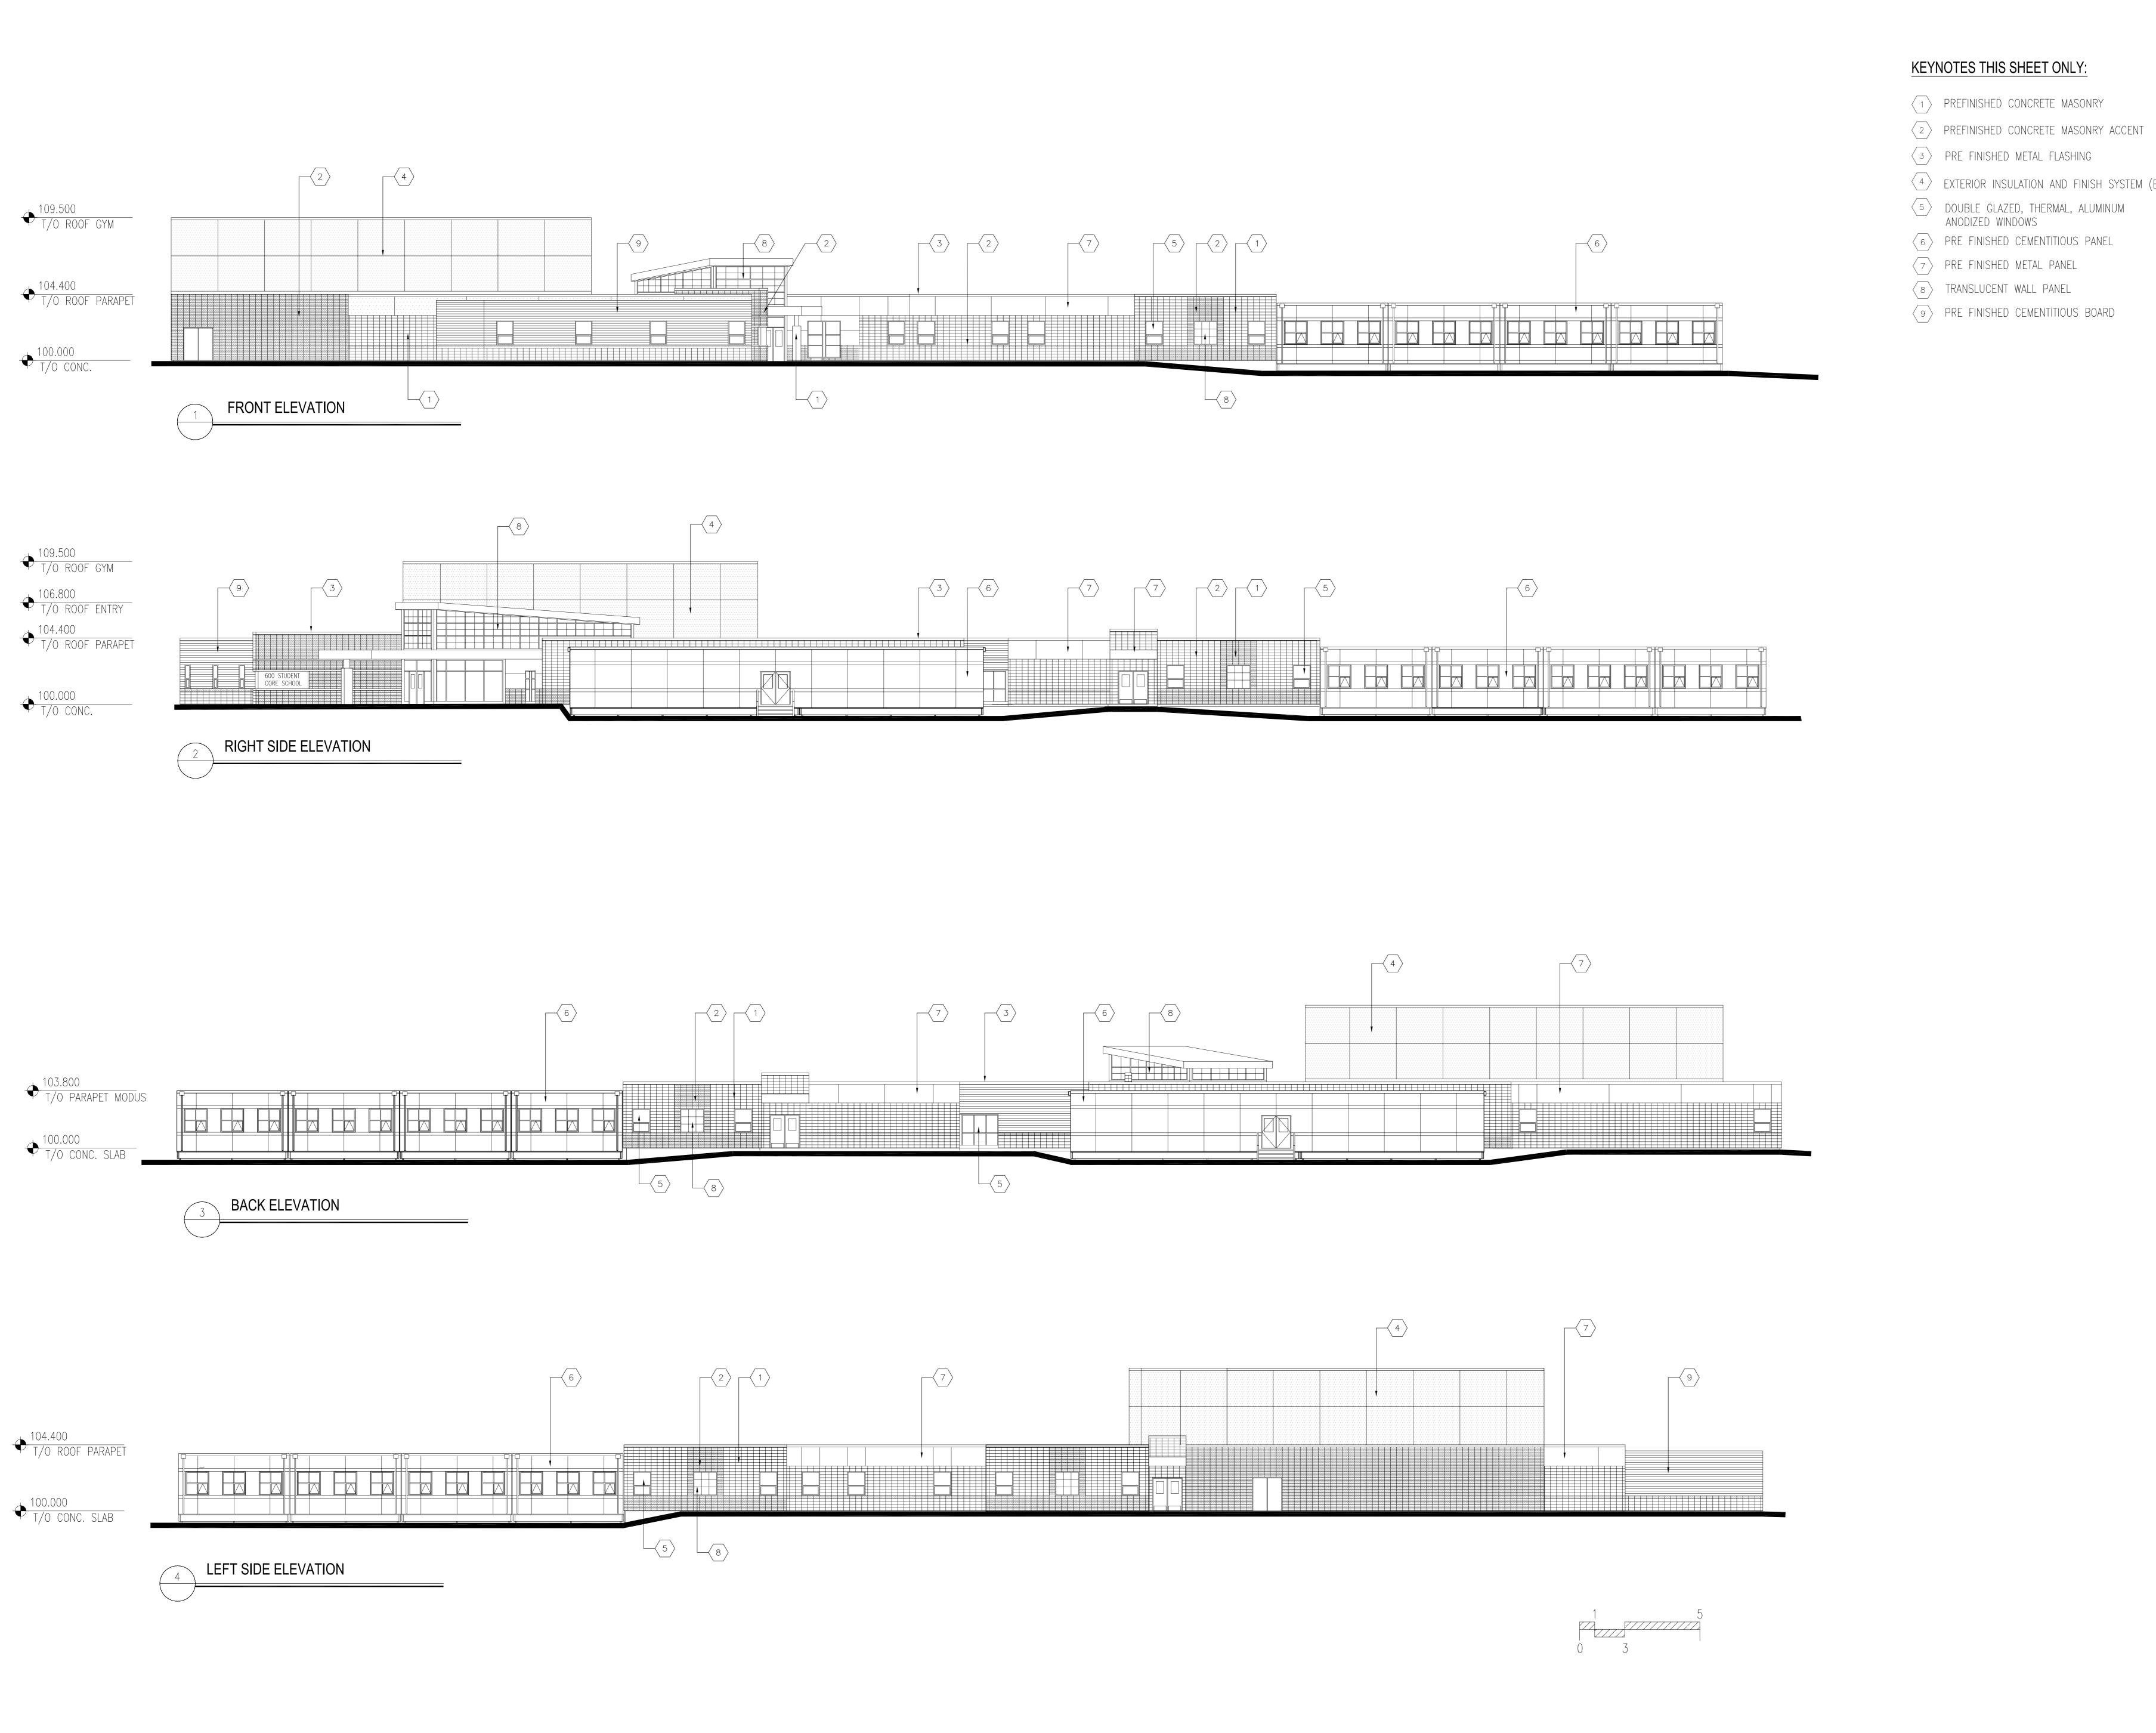

- 4 EXTERIOR INSULATION AND FINISH SYSTEM (EIFS)


ARCHITECTS & INTERIOR DESIGNERS 210, 10190 - 104 St.

Edmonton, Alberta

Canada T5J 1A7

Tel: (780) 423-6606

Fax: (780) 429-3962

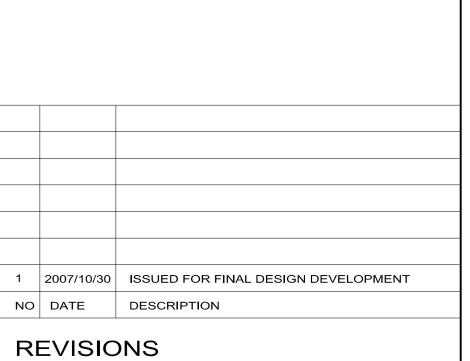


600 STUDENT K-9 CORE SCHOOL


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BUILDING ELEVATIONS

Drawn	Checked
СР	S.Bushnell
Project No.	Date
27339	05 SEPTEMBER 2007
Scale	Sheet No.
1:150	A301
	ASUI

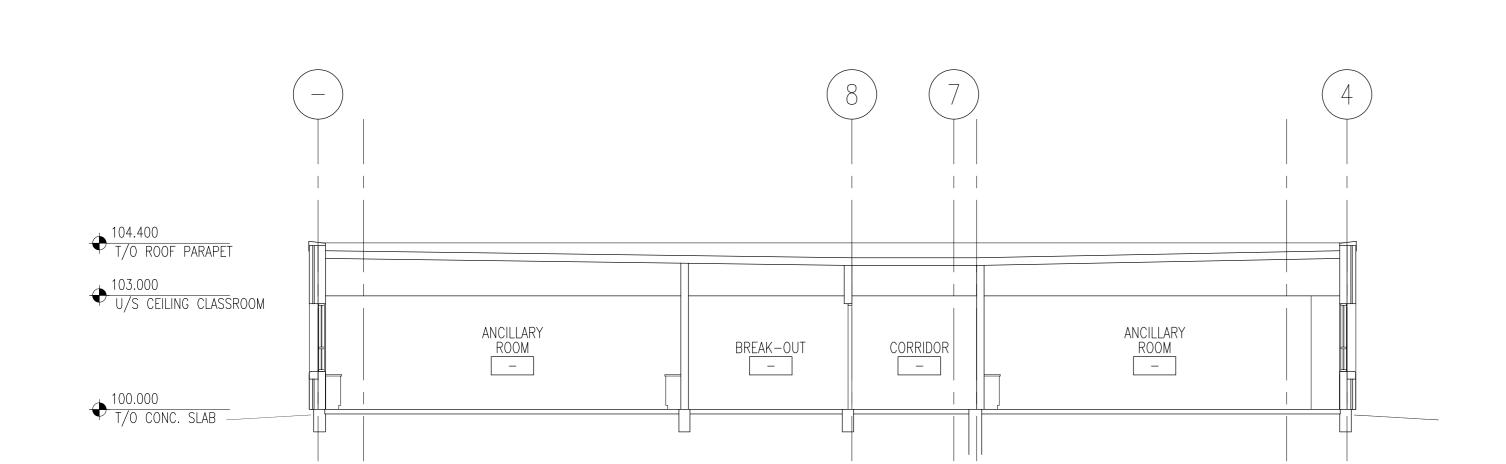

SECTION THRU ANCILLARY AND CORRIDOR / 1:100

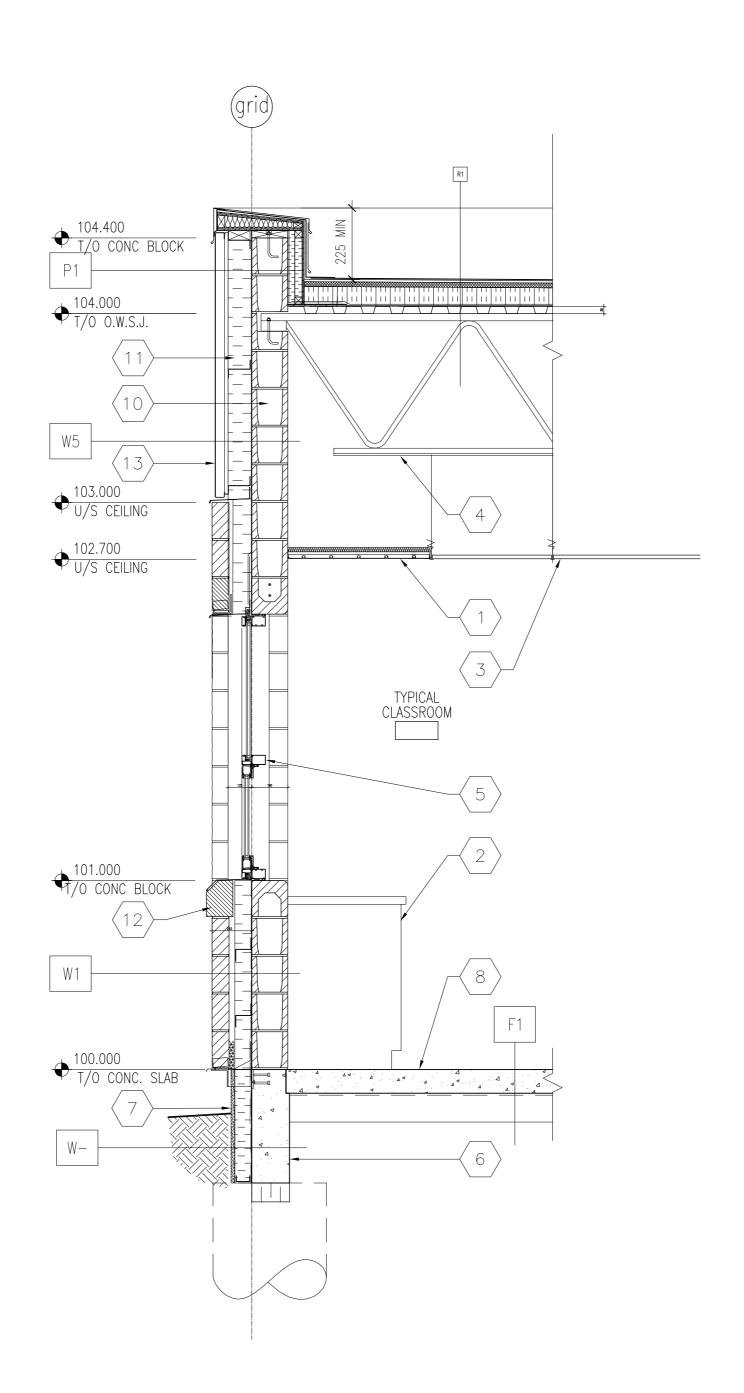

KEYNOTES THIS SHEET ONLY:

SUSPENDED RADIANT HEAT PANEL

CABINET

SUSPENDED ACOUSTIC TILE CEILING

ROOF STRUCTURE SEE STRUCTURAL DRAWINGS DOUBLE GLAZED THERMALLY BROKEN CLEAR ANOD. ALUM.

CURTAINWALL FRAME WINDOW W/OPERABLE AWNING UNIT 6 CONCRETE GRADE BEAM ON CAISSONS

16mm CEMENT BOARD ON 50mm Z-BARS, 50mm RIGID INSULATION, AIR/VAPOUR BARRIER TO FACE OF CRADE DEALS

AIR/VAPOUR BARRIER TO FACE OF GRADE BEAM FLOOR STRUCTURE SEE STRUCTURAL DRAWINGS

9 90mm CONCRETE BLOCK VENEER

190mm CONCRETE BLOCK

125 mm RIGID INSULATION

(12) 140 mm CONCRETE CHAMFER BLOCK SILL

50mm STIFFENED METAL PANEL ON 19mm GALV. STL BATTENS ON Z BAR FRAMING

ROOF TYPES:

SBS ROOF MEMBRANE
25mm FIBRE BOARD
POSITIVE SLOPED RIGID INSULATION (WHERE INDICATED SEE ROOF PLAN) 150mm MIN. RIGID INSULATION ON VAPOUR BARRIER MEMBRANE 13mm GYPSUM BOARD SHEATHING 38mm STEEL ROOF DECK ON STEEL STRUCTURE SLOPED TO DRAIN

WALL TYPES:

90mm ARCHITECTURAL BLOCK VENEER
30mm AIR SPACE
90mm RIGID INSULATION AIR/VAPOUR BARRIER MEMBRANE

190mm CONCRETE BLOCK

90mm ARCHITECTURAL BLOCK VENEER
30mm AIR SPACE
90mm RIGID INSULATION AIR/VAPOUR BARRIER MEMBRANE 190mm CONCRETE BLOCK

EIFS RAINSCREEN SYSTEM
ACRYLIC STUCCO FINISH ON 100mm RIGID INSULATION c/w MOISTURE DRAINAGE CHANNELS AIR/VAPOUR BARRIER MEMBRANE 190mm CONCRETE BLOCK

W5 PRE-FINISHED STIFFENED 50mm ALUMINUM PANELS ON 19 mm SUBRAMING ON GALV. Z BAR FRAMING, 100mm POLYISCOCYANURATE INSULATION PEEL AND STICK AIR-VAPOUR AIR/VAPOUR BARRIER MEMBRANE 190mm CONCRETE BLOCK

PARAPET TYPES:

PT PREFINISHED METAL COPING FLASHING INCLUDING COUNTERFLASHING.
CARRY SBS ROOF MEMBRANE FROM ROOF TO TOP OF WOOD COPING. 190 CONCRETE BLOCK AIR/ VAPOUR BARRIER 50mm STIFFENED METAL PANEL ON 19 mm GALV. STEEL BATTENS AND Z GIRT FRAMING 100mm RIGID INSULATION c/w MOISTURE DRAINAGE CHANNÉLS AIR/VAPOUR BARRIER MEMBRANE 190 CONCRETE BLOCK

P2 PREFINISHED METAL COPING FLASHING INCLUDING COUNTERFLASHING. CARRY SBS ROOF MEMBRANE FROM ROOF TO TOP OF WOOD COPING.
WOOD COPING TO CONSIST OF 13mm EXT. GRADE PLYWOOD ON PRESSURE TREATED WOOD BLOCKING ON 16mm EXTERIOR GRADE PLYWOOD FILL VOID WITH INSULATION. FASTENED TO EXTERIOR 13mm GYPSUM SHEATHING TO TOP TRACK OF METAL STUD. 38mm X 89mm PRESSURE TREATED WOOD BLOCKING FASTENED TO SHEATHING 90mm ARCHITECTURAL BLOCK 30mm AIR SPACE AIR/VAPOUR BARRIER MEMBRANE 13mm EXT. GYPSUM BOARD SHEATHING 152mm STEEL STUDS @ 400mm O.C. R20 BATT INSULATION 16mm ABUSE RESISTANT GYPSUM BOARD 38mm X 38mm PRESSURE TREATED WOOD STUD @ 400 O.C.

FILL VOID W/ RIGID INSULATION ON 13mm EXTERIOR GRADE PLYWOOD TPO ROOF MEMBRANE

HEMISPHERE * EDMONTON * CALGARY * ATLANTA *

ARCHITECTS & INTERIOR

DESIGNERS

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Fax: (780) 429-3962





1 2007/10/31 ISSUED FOR FINAL DESIGN DEVELOPMENT NO DATE DESCRIPTION

REVISIONS

SEAL / PERMIT


600 STUDENT K-9 CORE SCHOOL

BUILDING SECTION

Drawn	Checked
СР	SB
Project No.	Date
27339	Aug 15 2007
Scale	Sheet No.
AS SHOWN	A401



TYPICAL CLASSROOM WING WINDOW WALL SECTION

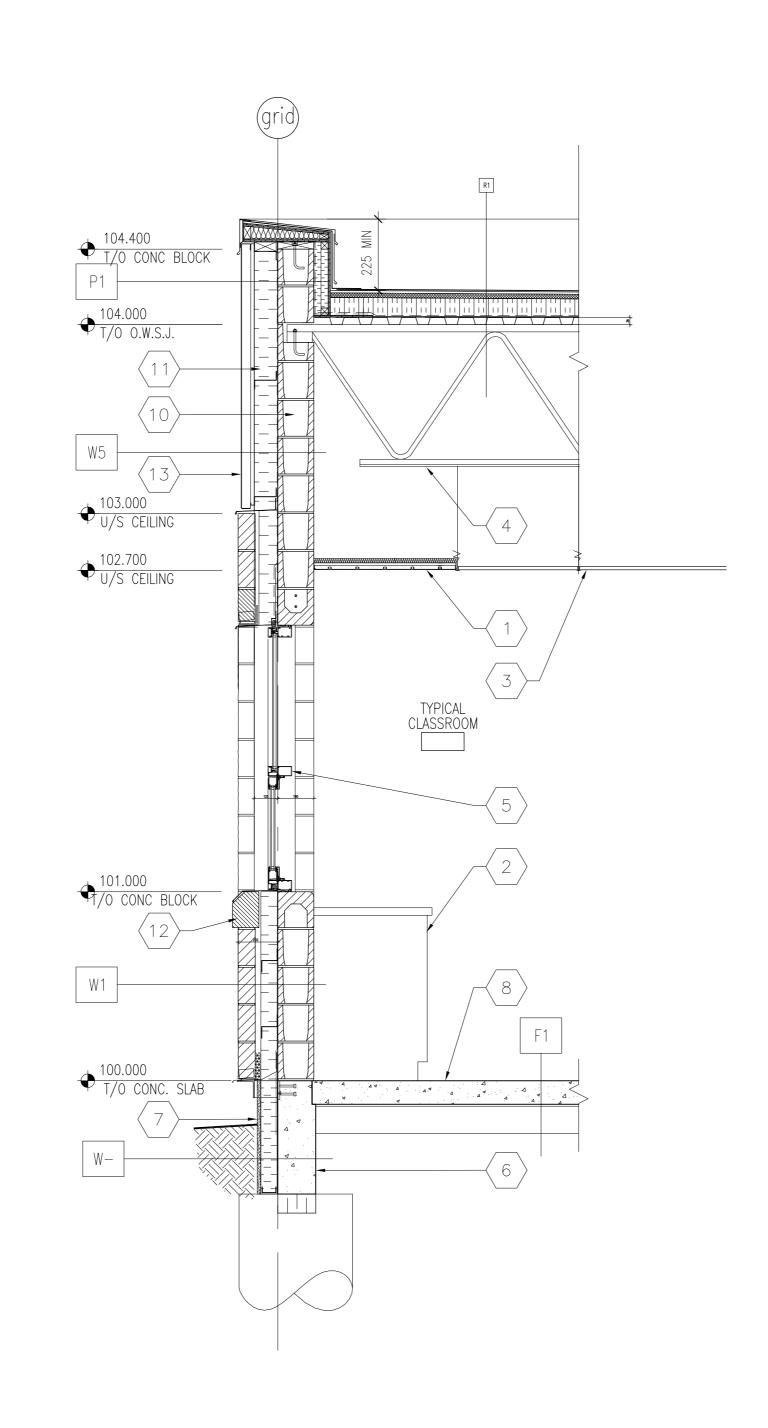



KEYNOTES THIS SHEET ONLY:

- (1) SUSPENDED RADIANT HEAT PANEL
- 2 CABINET
- 3 > SUSPENDED ACOUSTIC TILE CEILING ROOF STRUCTURE SEE STRUCTURAL DRAWINGS
- DOUBLE GLAZED THERMALLY BROKEN CLEAR ANOD. ALUM. CURTAINWALL FRAME WINDOW W/OPERABLE AWNING UNIT
- 6 CONCRETE GRADE BEAM ON CAISSONS
- 16mm CEMENT BOARD ON 50mm Z-BARS, 50mm RIGID INSULATION, AIR/VAPOUR BARRIER TO FACE OF GRADE BEAM
- 8 > FLOOR STRUCTURE SEE STRUCTURAL DRAWINGS
- 90mm CONCRETE BLOCK VENEER
- 190mm CONCRETE BLOCK
- > 125 mm RIGID INSULATION
- 12 140 mm CONCRETE CHAMFER BLOCK SILL
- 50mm STIFFENED METAL PANEL ON 19mm GALV. STL BATTENS
 ON 7 RAR FRAMING ON Z BAR FRAMING

ROOF TYPES:

SBS ROOF MEMBRANE 25mm FIBRE BOARD POSITIVE SLOPED RIGID INSULATION (WHERE INDICATED SEE ROOF PLAN) 150mm MIN. RIGID INSULATION ON VAPOUR BARRIER MEMBRANE

13mm GYPSUM BOARD SHEATHING 38mm STEEL ROOF DECK ON STEEL STRUCTURE SLOPED TO DRAIN

WALL TYPES:

w1 90mm ARCHITECTURAL BLOCK VENEER 30mm AIR SPACE 90mm RIGID INSULATION AIR/VAPOUR BARRIER MEMBRANE

190mm CONCRETE BLOCK

w2 90mm ARCHITECTURAL BLOCK VENEER 30mm AIR SPACE

90mm RIGID INSULATION AIR/VAPOUR BARRIER MEMBRANE 190mm CONCRETE BLOCK

W4 EIFS RAINSCREEN SYSTEM ACRYLIC STUCCO FINISH ON 100mm RIGID INSULATION c/w MOISTURE DRAINAGE CHANNELS AIR/VAPOUR BARRIER MEMBRANE 190mm CONCRETE BLOCK

PRE-FINISHED STIFFENED 50mm ALUMINUM PANELS ON 19 mm SUBRAMING ON GALV. Z BAR FRAMING, 100mm POLYISCOCYANURATE INSULATION PEEL AND STICK AIR-VAPOUR AIR/VAPOUR BARRIER MEMBRANE

190mm CONCRETE BLOCK


PARAPET TYPES:

P1 PREFINISHED METAL COPING FLASHING INCLUDING COUNTERFLASHING. CARRY SBS ROOF MEMBRANE FROM ROOF TO TOP OF WOOD COPING. 190 CONCRETE BLOCK AIR/ VAPOUR BARRIER 50mm STIFFENED METAL PANEL ON 19 mm GALV. STEEL BATTENS AND Z GIRT FRAMING 100mm RIGID INSULATION c/w MOISTURE DRAINAGE CHANNELS AIR/VAPOUR BARRIER MEMBRANE 190 CONCRETE BLOCK

PREFINISHED METAL COPING FLASHING INCLUDING COUNTERFLASHING. CARRY SBS ROOF MEMBRANE FROM ROOF TO TOP OF WOOD COPING. WOOD COPING TO CONSIST OF 13mm EXT. GRADE PLYWOOD ON PRESSURE TREATED WOOD BLOCKING ON 16mm EXTERIOR GRADE PLYWOOD FILL VOID WITH INSULATION. FASTENED TO EXTERIOR 13mm GYPSUM SHEATHING TO TOP TRACK OF METAL STUD. 38mm X 89mm PRESSURE TREATED WOOD BLOCKING FASTENED TO SHEATHING 90mm ARCHITECTURAL BLOCK 30mm AIR SPACE AIR/VAPOUR BARRIER MEMBRANE 13mm EXT. GYPSUM BOARD SHEATHING 152mm STEEL STUDS @ 400mm O.C.

> 16mm ABUSE RESISTANT GYPSUM BOARD 38mm X 38mm PRESSURE TREATED WOOD STUD @ 400 O.C. FILL VOID W/ RIGID INSULATION ON 13mm EXTERIOR GRADE PLYWOOD TPO ROOF MEMBRANE


R20 BATT INSULATION

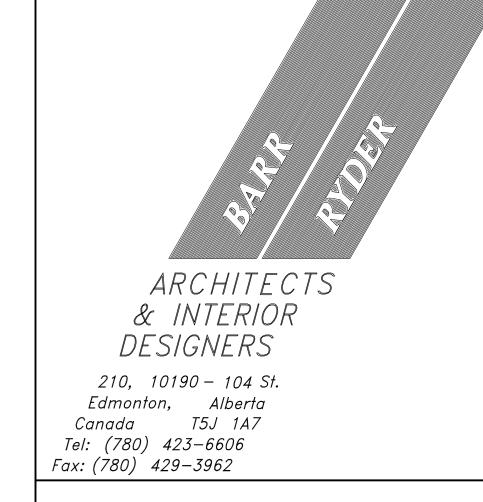

HEMISPHERE CONSULTING ENGINEERS * EDMONTON * CALGARY * ATLANTA *





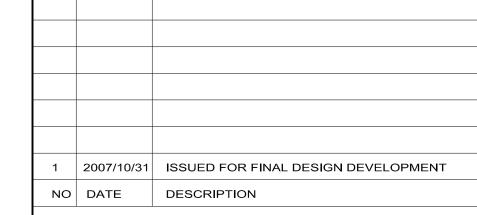

REVISIONS

SEAL / PERMIT


600 STUDENT K-9 CORE SCHOOL

Scale

WALL SECTION


Project No. 27335 Date Aug 31 2007

> Sheet No. A403

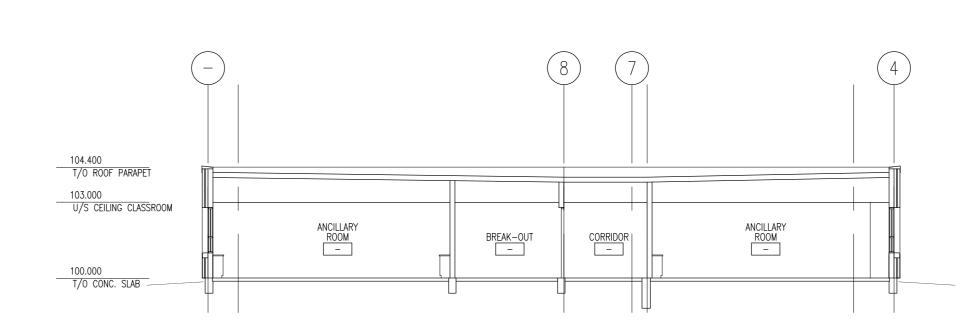



SECTION THRU ANCILLARY AND CORRIDOR

1:150

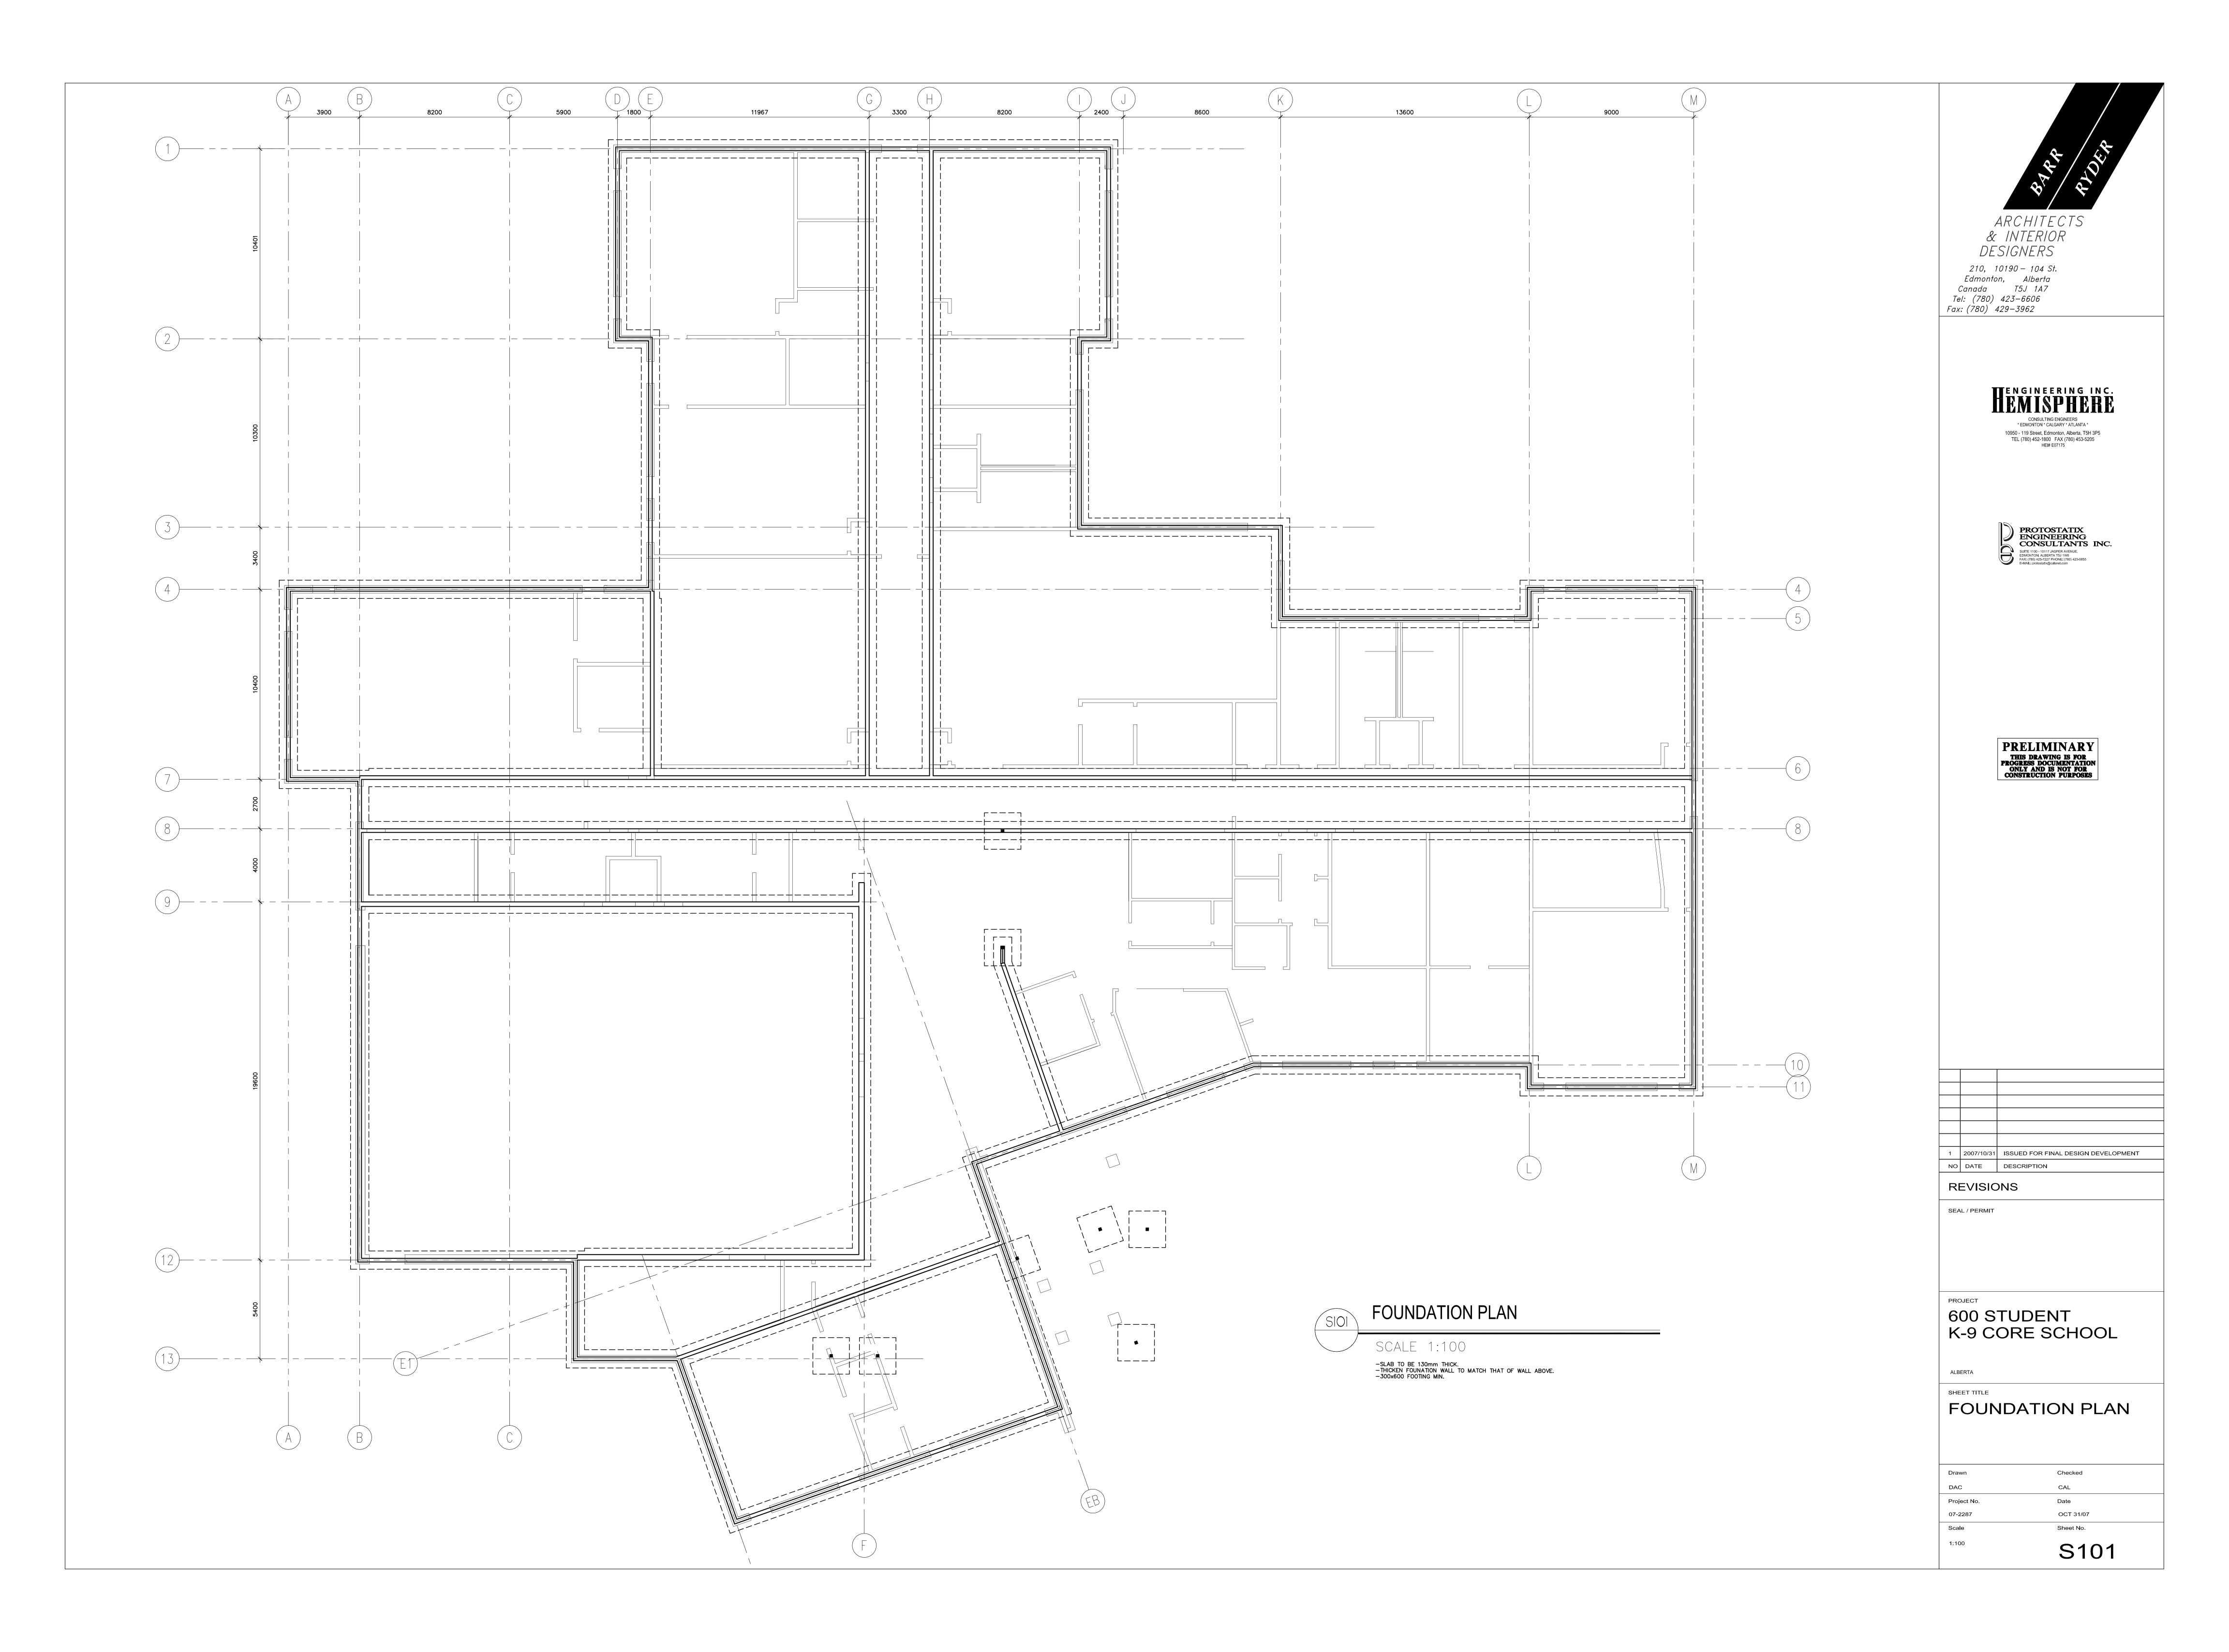



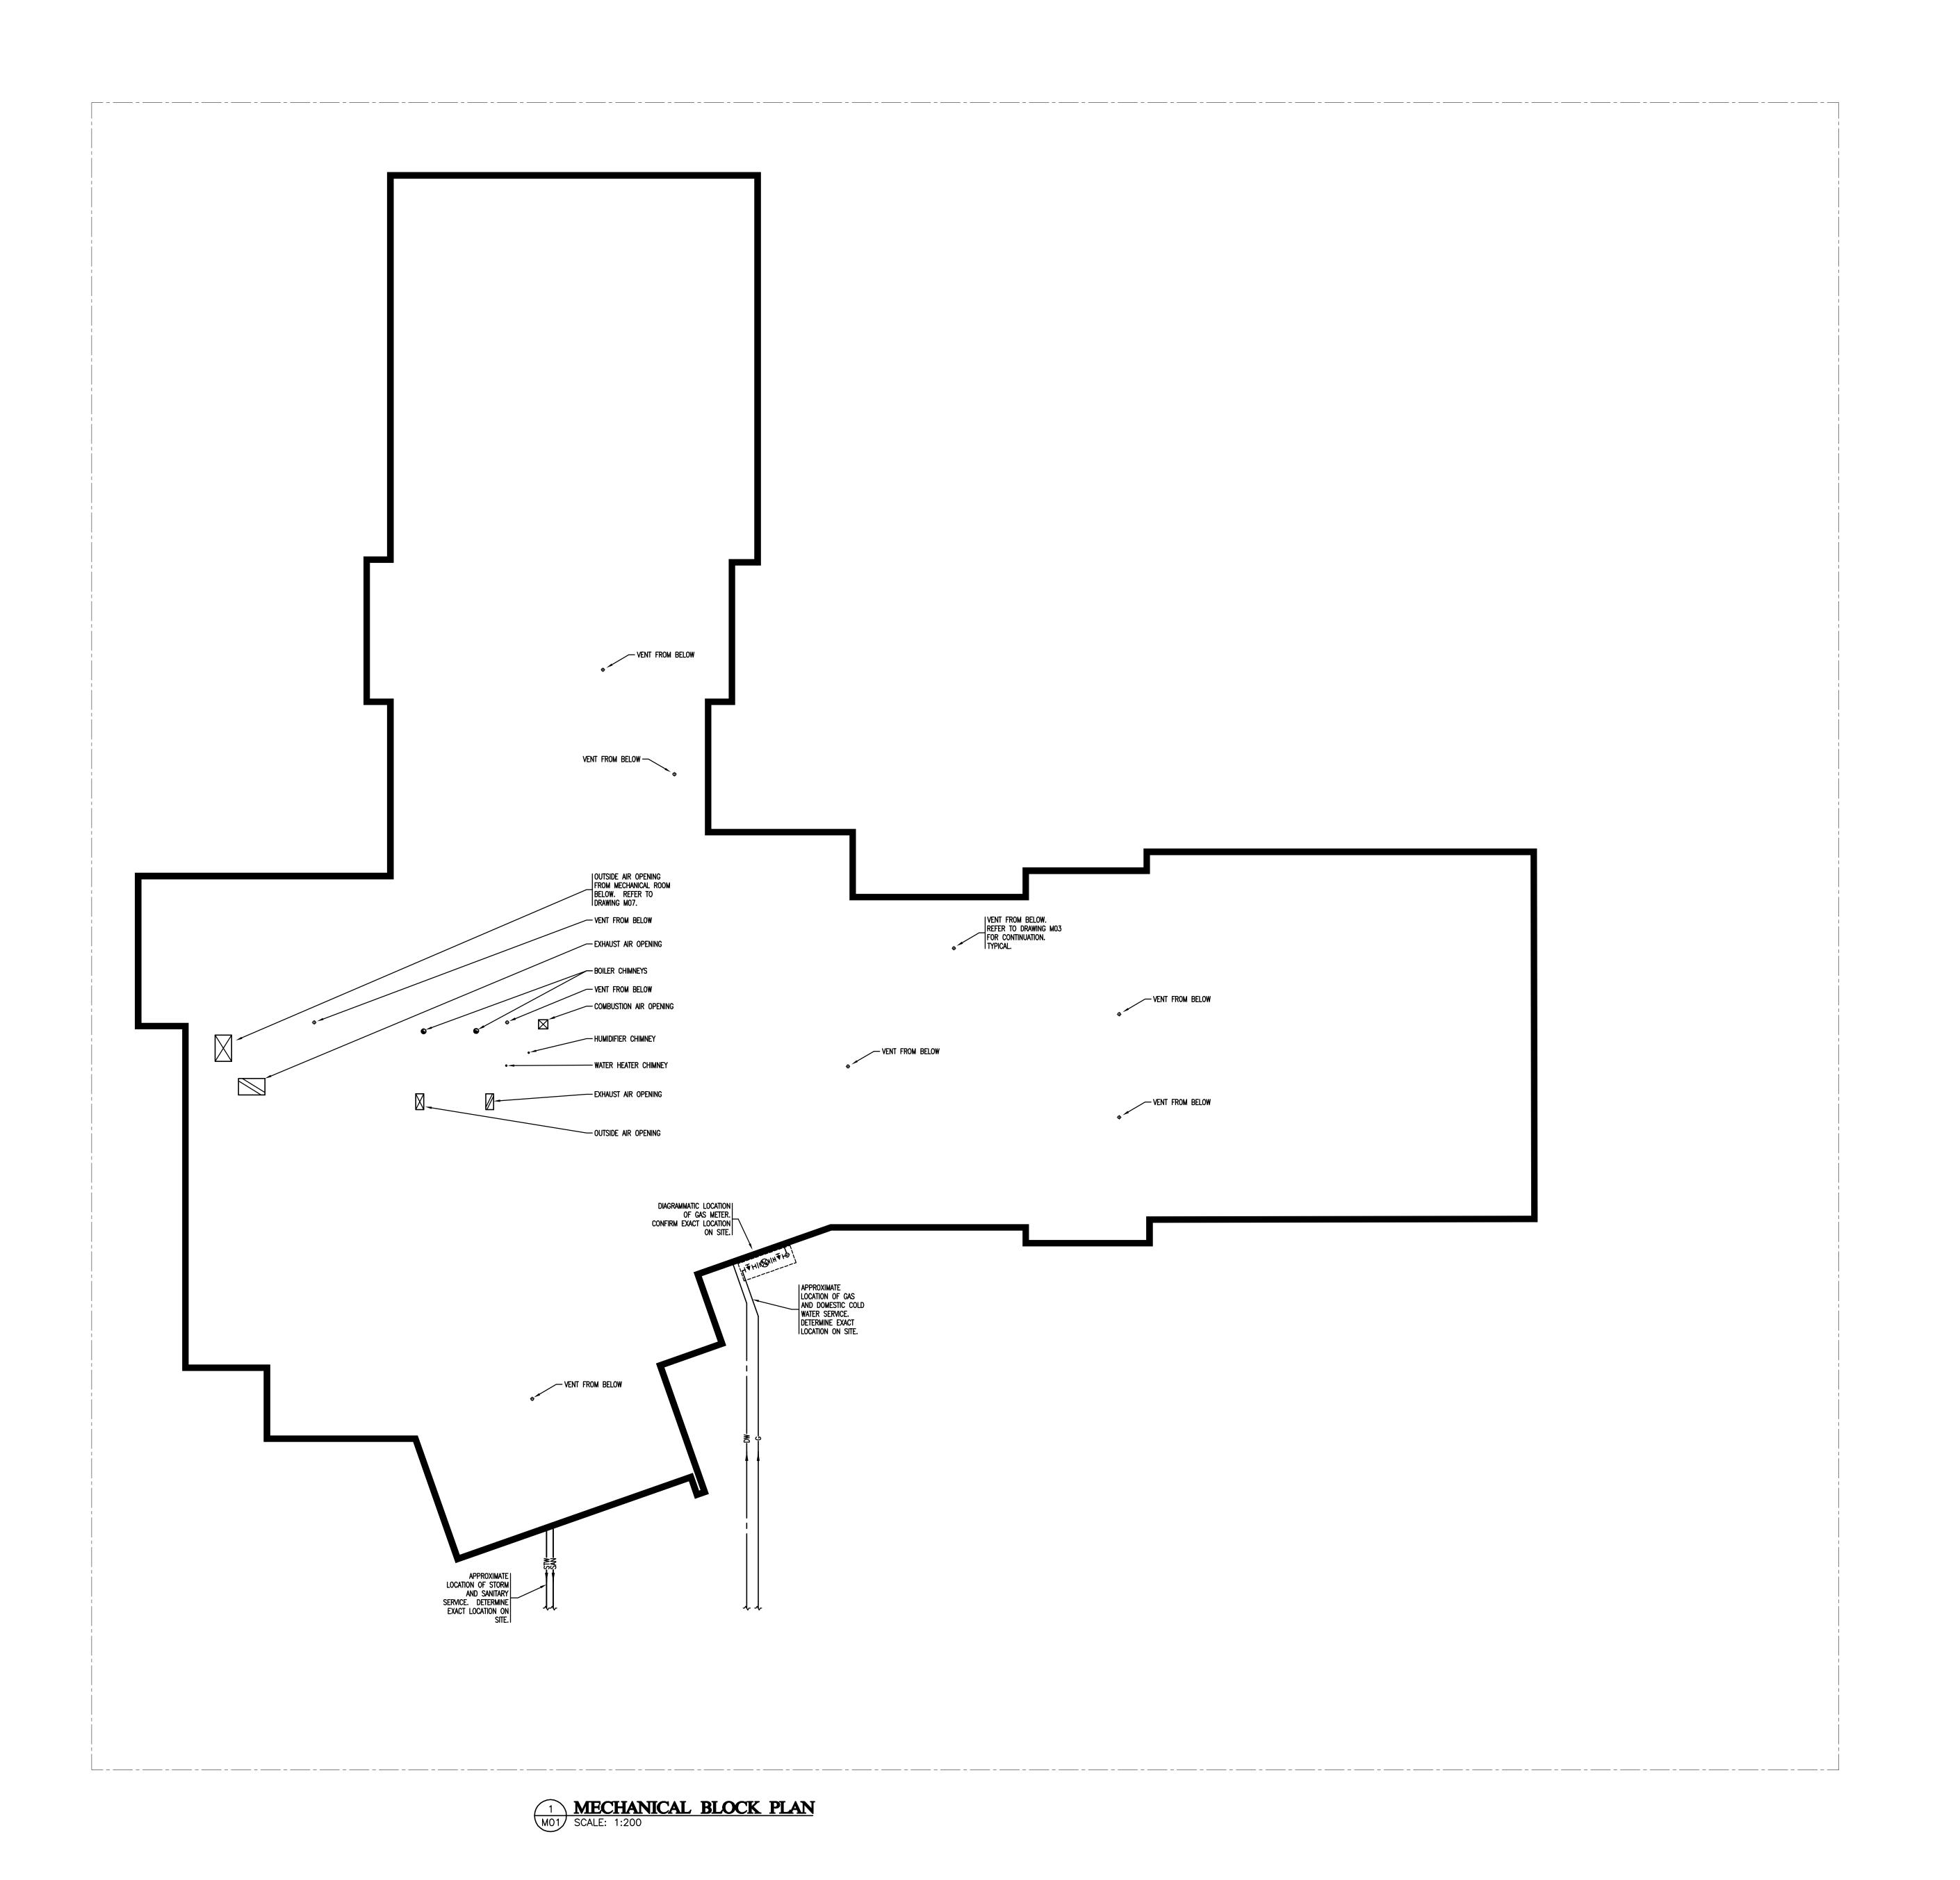

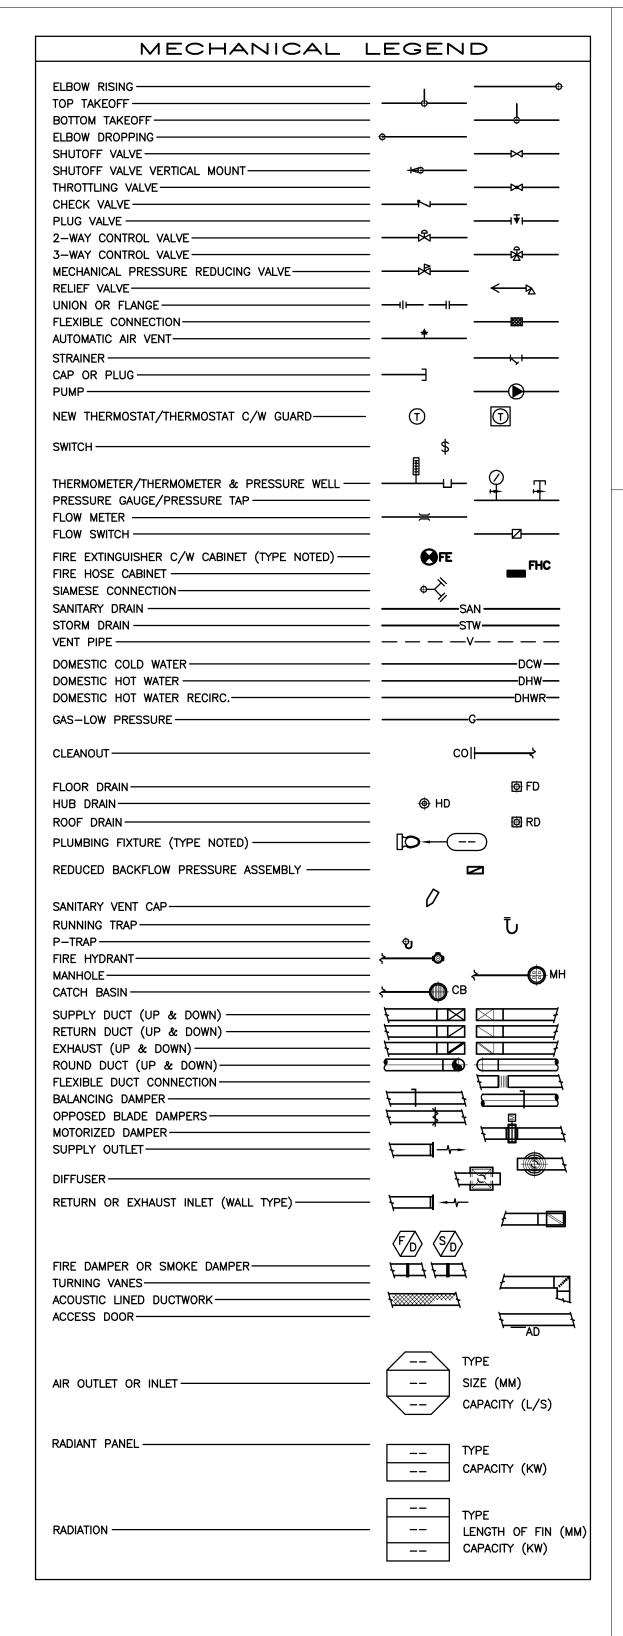




CONSULTING ENGINEERS
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10950 - 119 Street, Edmonton, Alberta, T5H 3P5
TEL (780) 452-1800 FAX (780) 453-5205
HEI# E07174





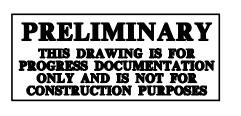

1 2007/10/31 ISSUED FOR FINAL DESIGN DEVELOPMENT
NO DATE DESCRIPTION

REVISIONS


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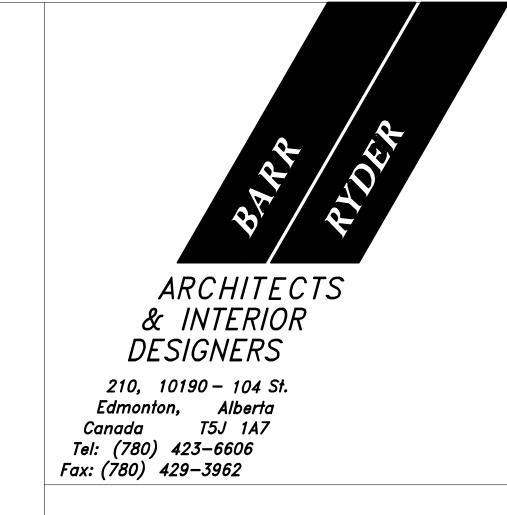
ALBERTA

MECHANICAL BLOCK PLAN

Drawn WMH/MJR	Checked DJC
Project No. E07174	Date September 18, 2007
Scale	Sheet No.
1:200	M01






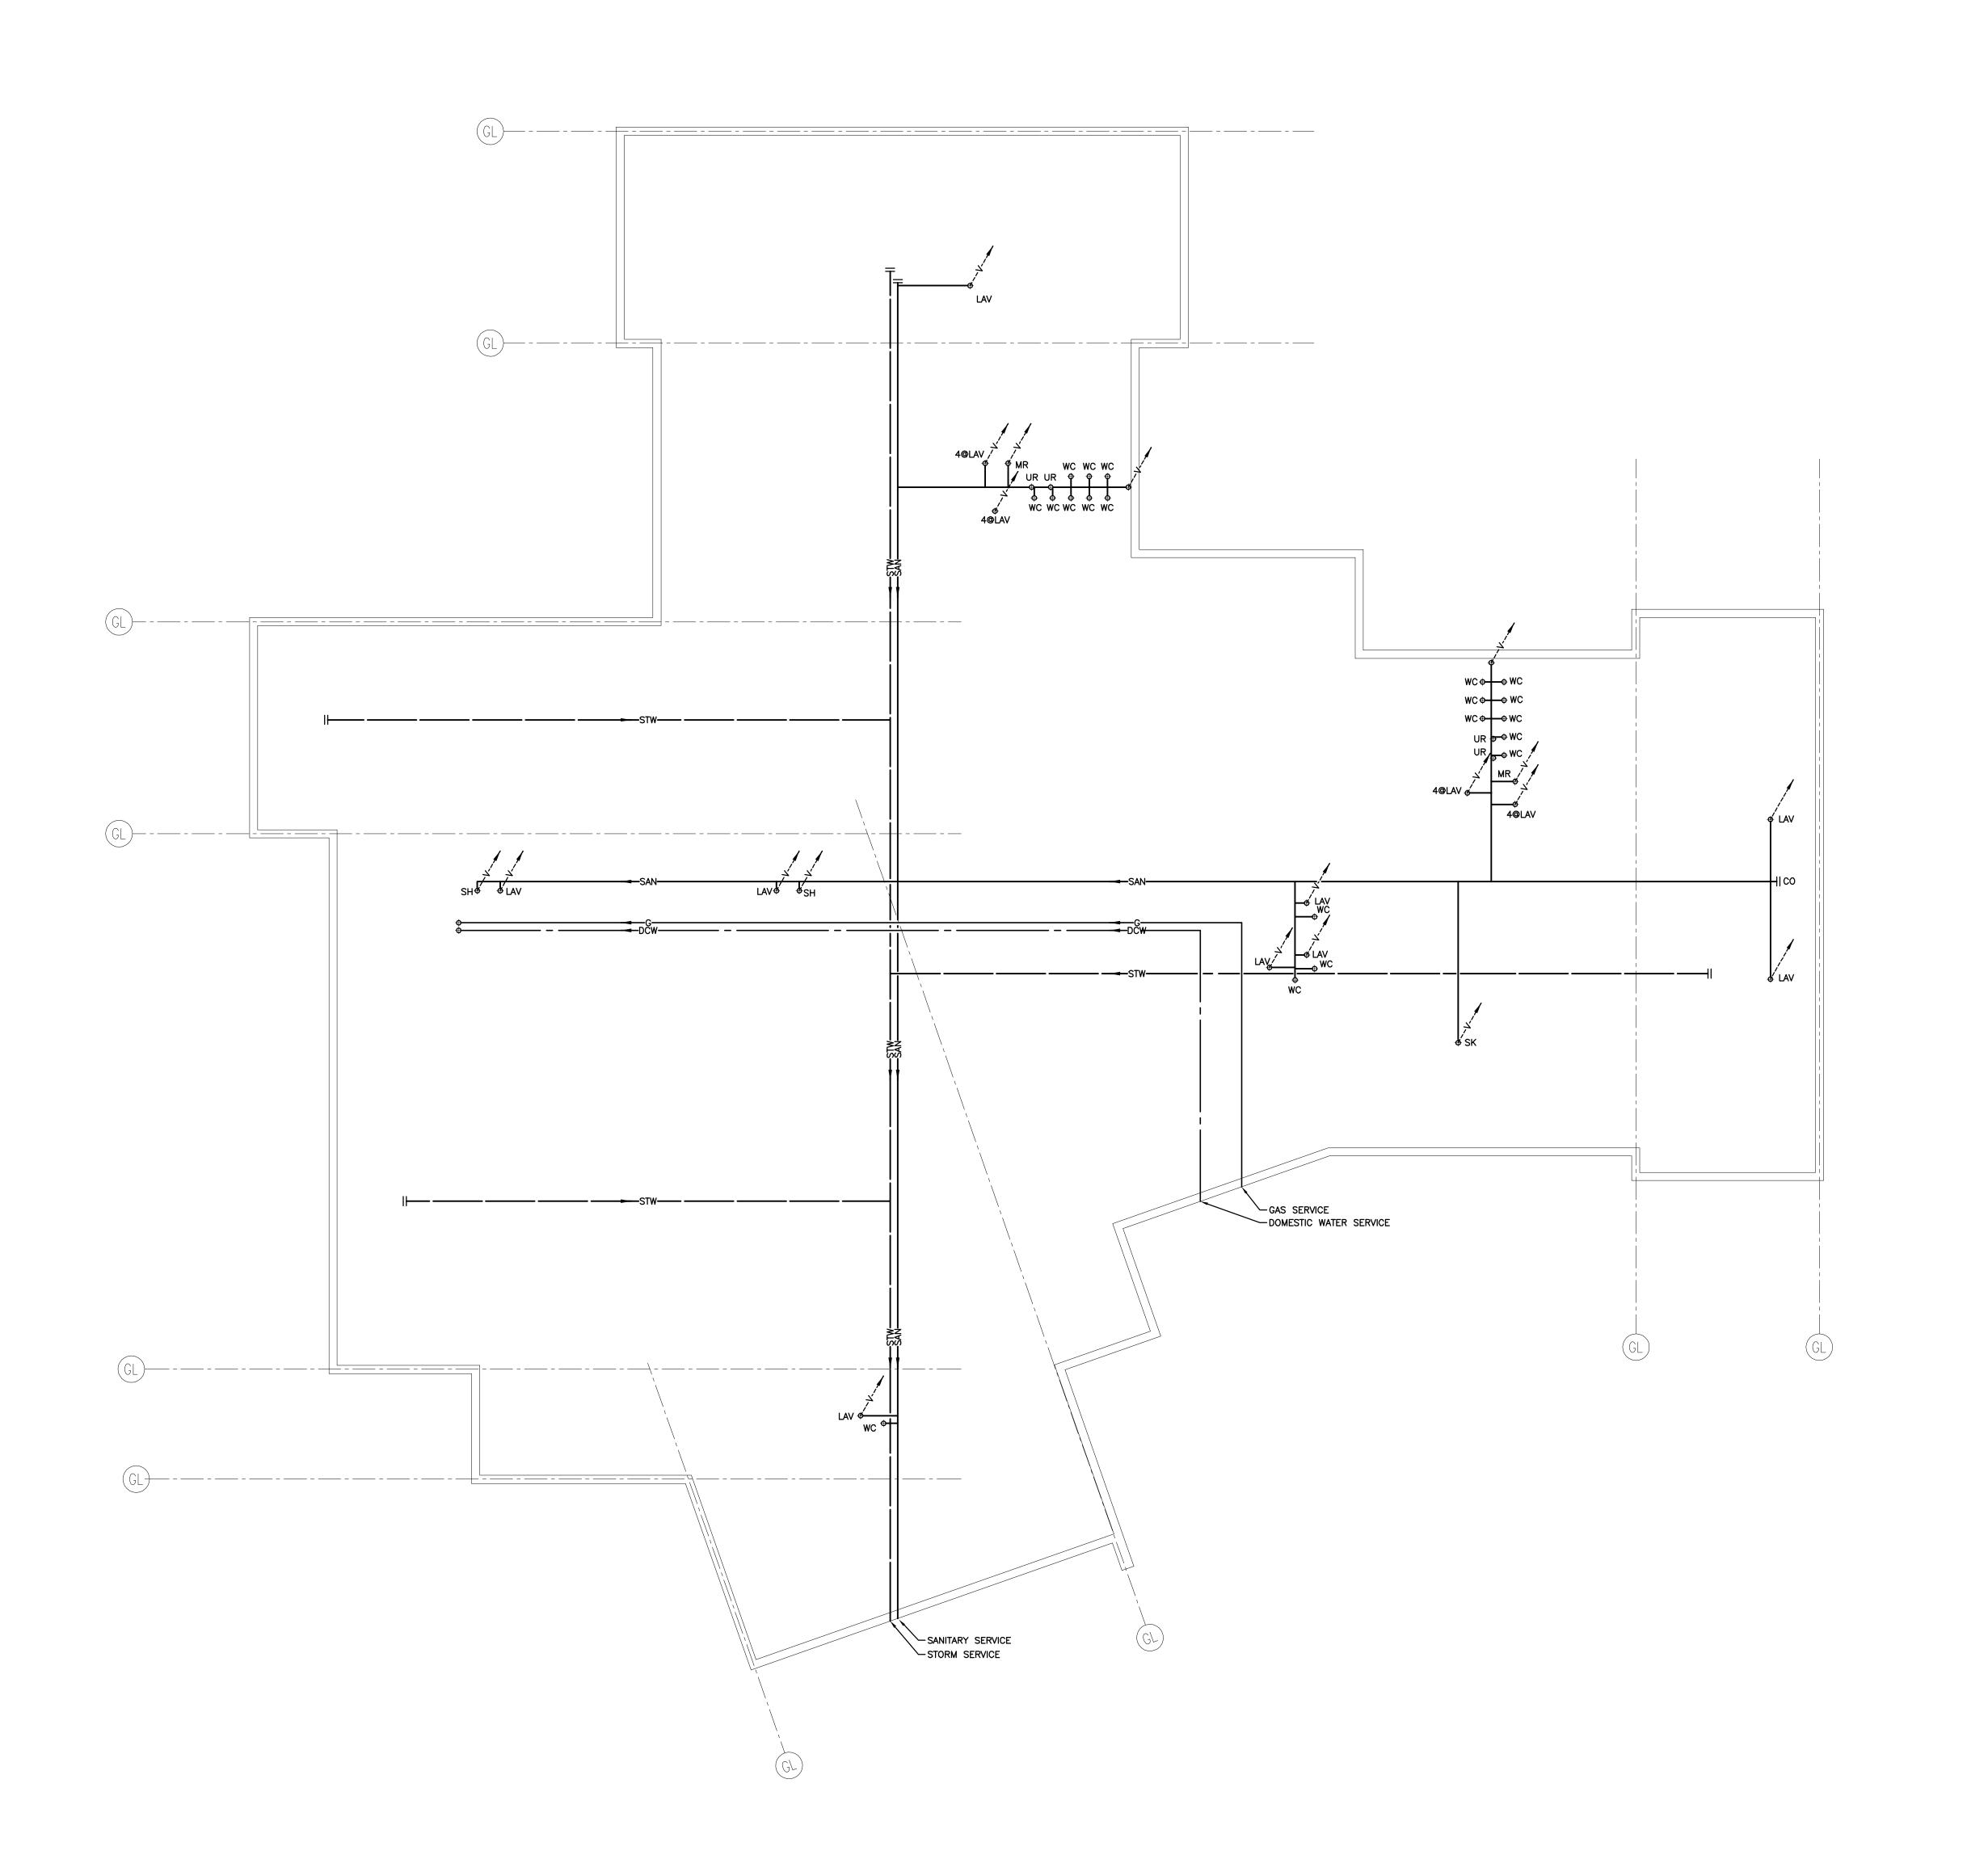







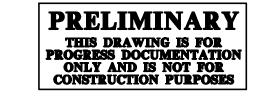

GENERAL NOTES:

ALL SANITARY MAINS 100¢ UNLESS OTHERWISE NOTED. SANITARY BRANCHES TO LAVATORIES, URINALS AND SINKS 50¢. SANITARY BRANCHES TO WATER CLOSETS AND FLOOR DRAINS 100¢. ALL VENTS FROM FOUNDATION 50¢.

1	2007/10/31	ISSUED FOR FINAL DESIGN DEVELOPMENT
NO	DATE	DESCRIPTION

REVISIONS


600 STUDENT K-9 CORE SCHOOL


SHEET TITLE FOUNDATION PLAN

WMH/MJR	Checked DJC
Project No.	Date
E07174	September 18, 2007
Scale	Sheet No.

1:150

M02

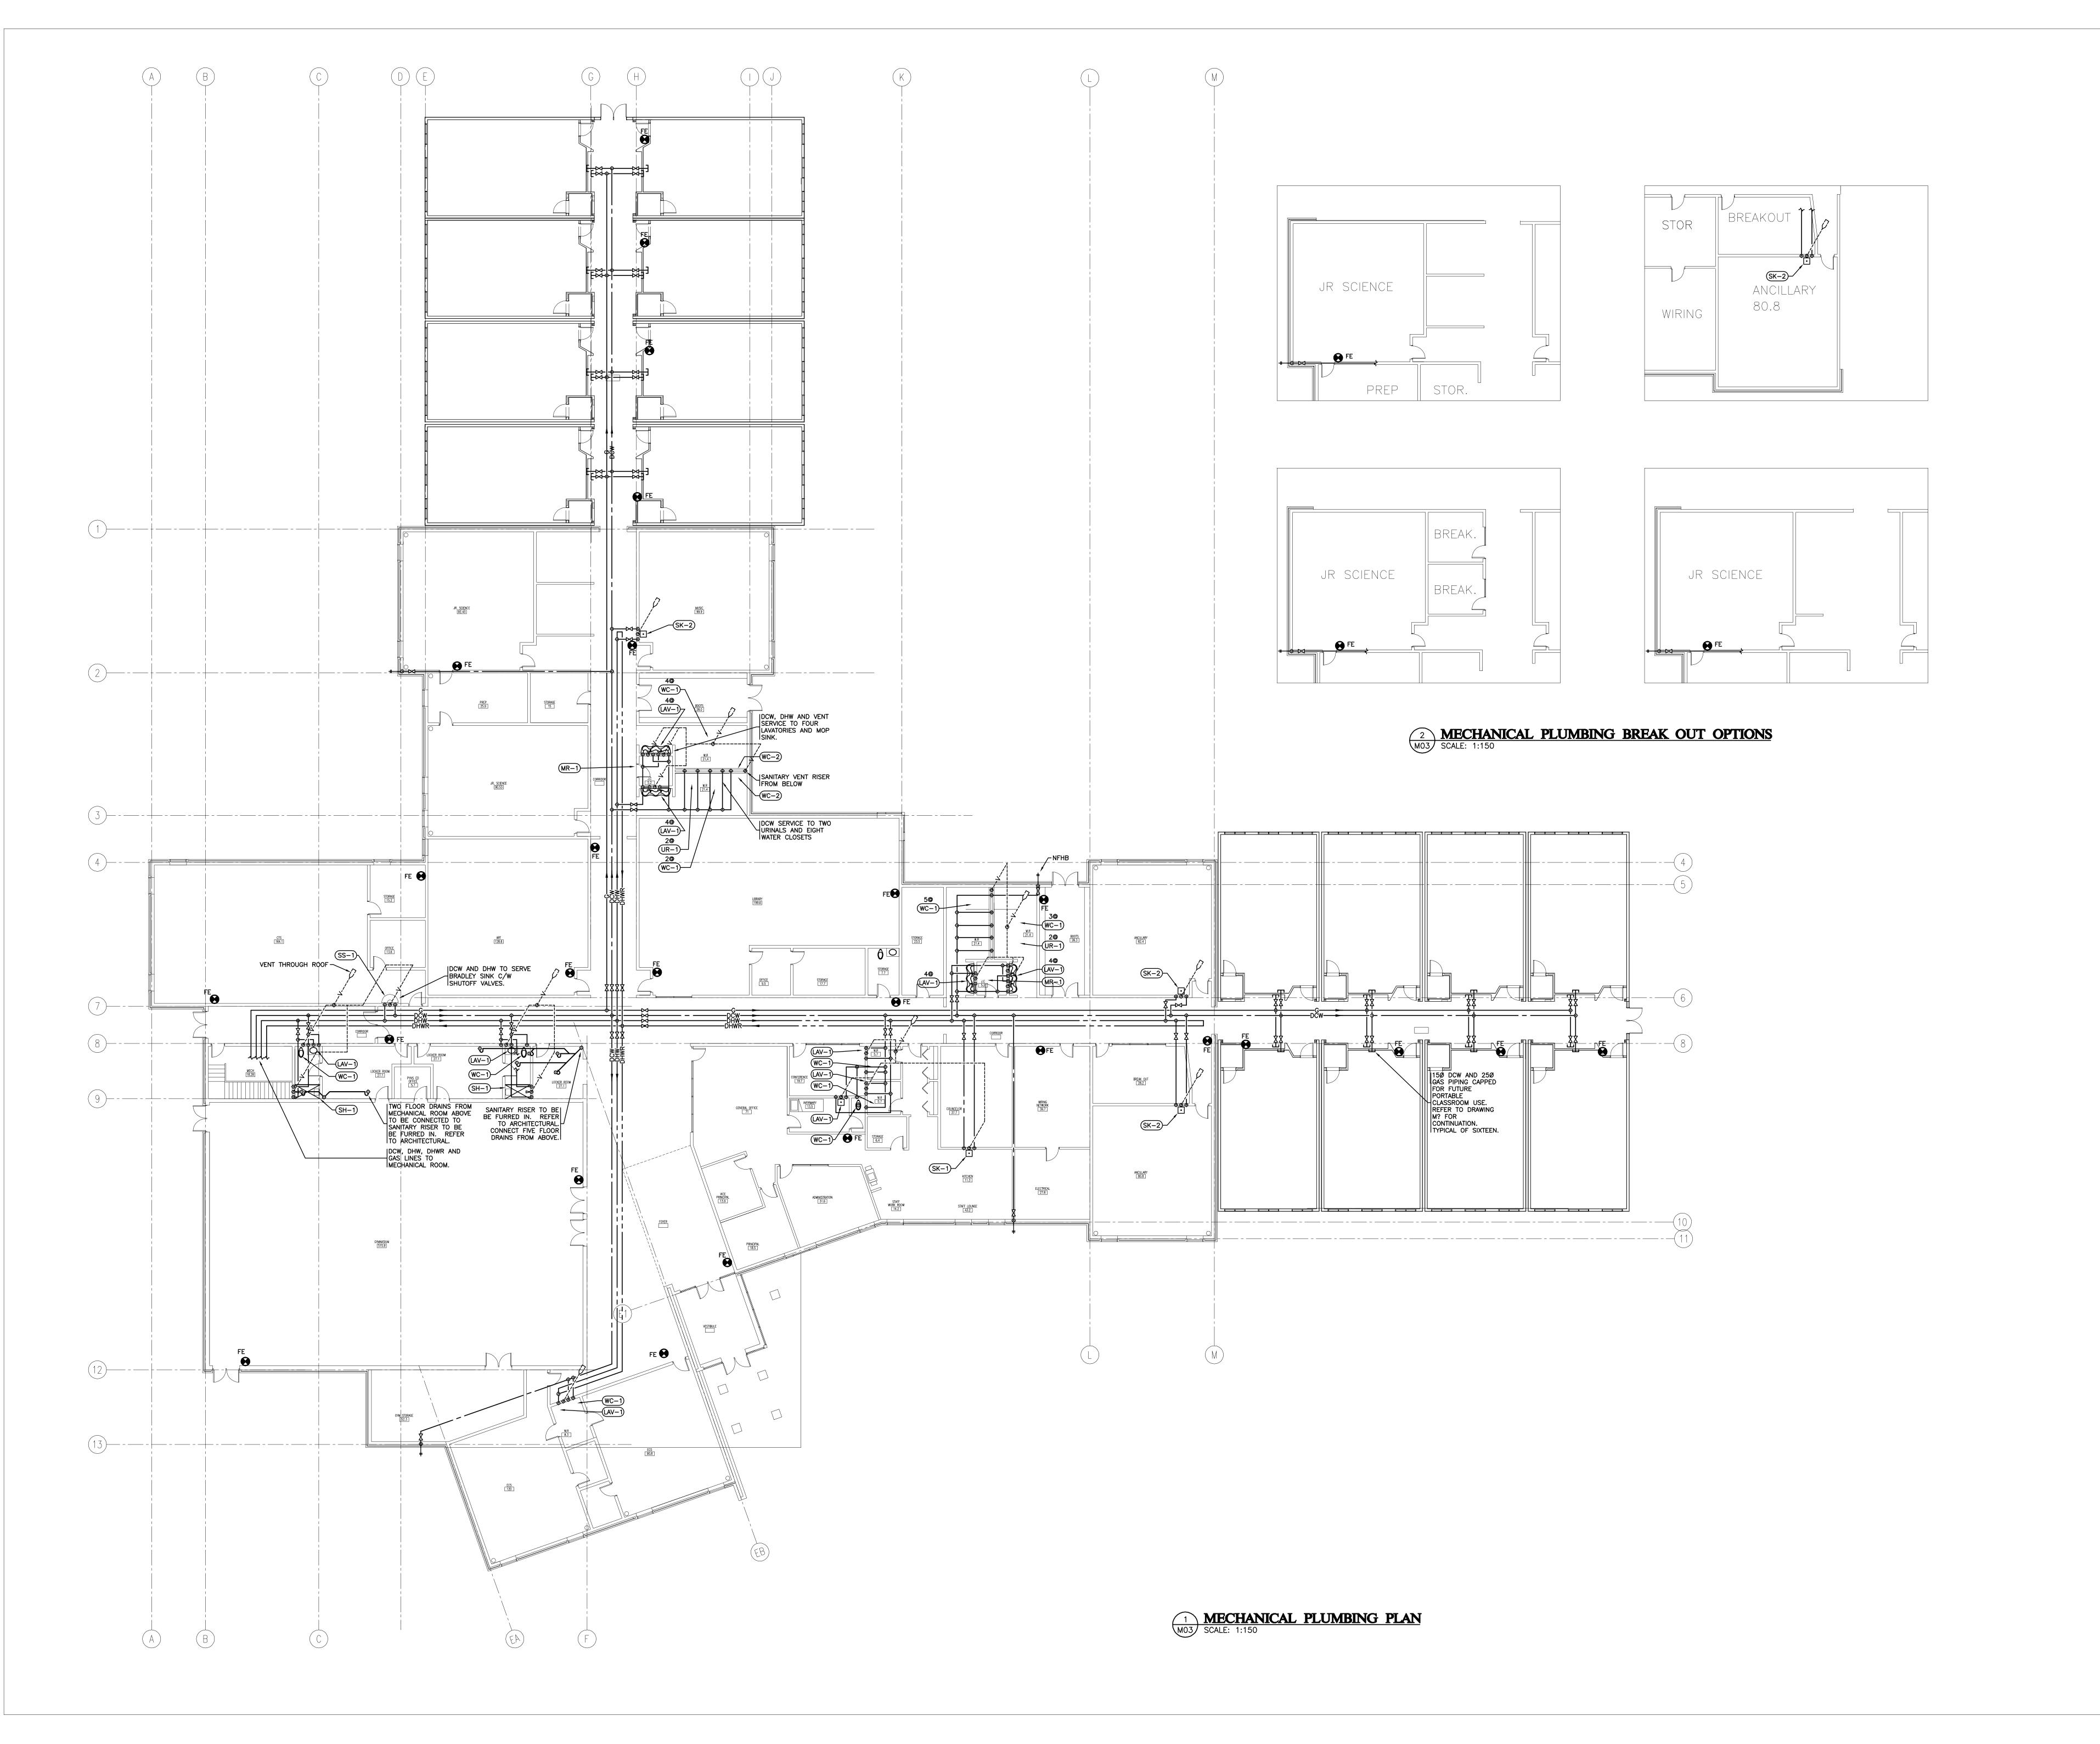


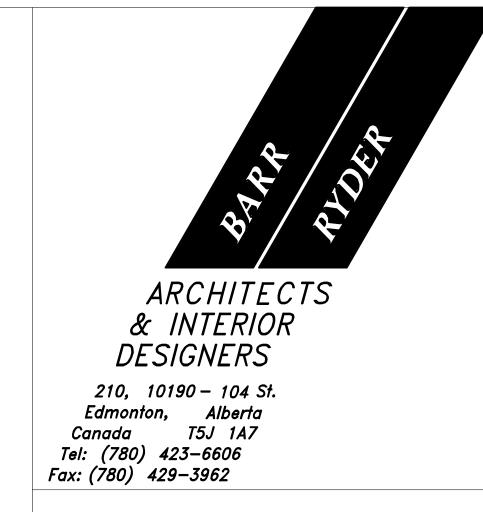







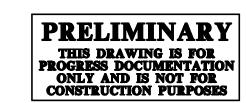

1	2007/10/31	ISSUED FOR FINAL DESIGN DEVELOPMENT

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SEAL / PERM


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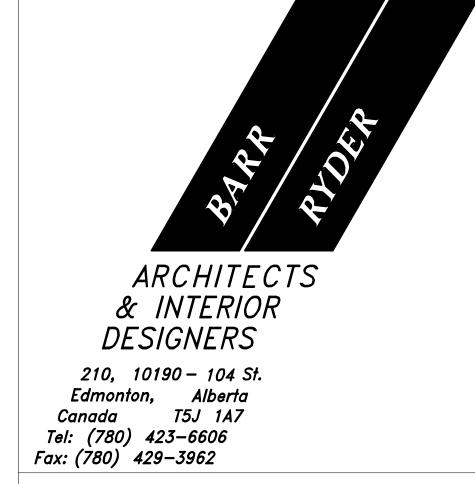
ALBERTA

SHEET TITLE

PLUMBING PLAN

Drawn WMH/MJR	Checked DJC
Project No.	Date
E07174	September 18, 2007
Scale	Sheet No.
1:150	M03




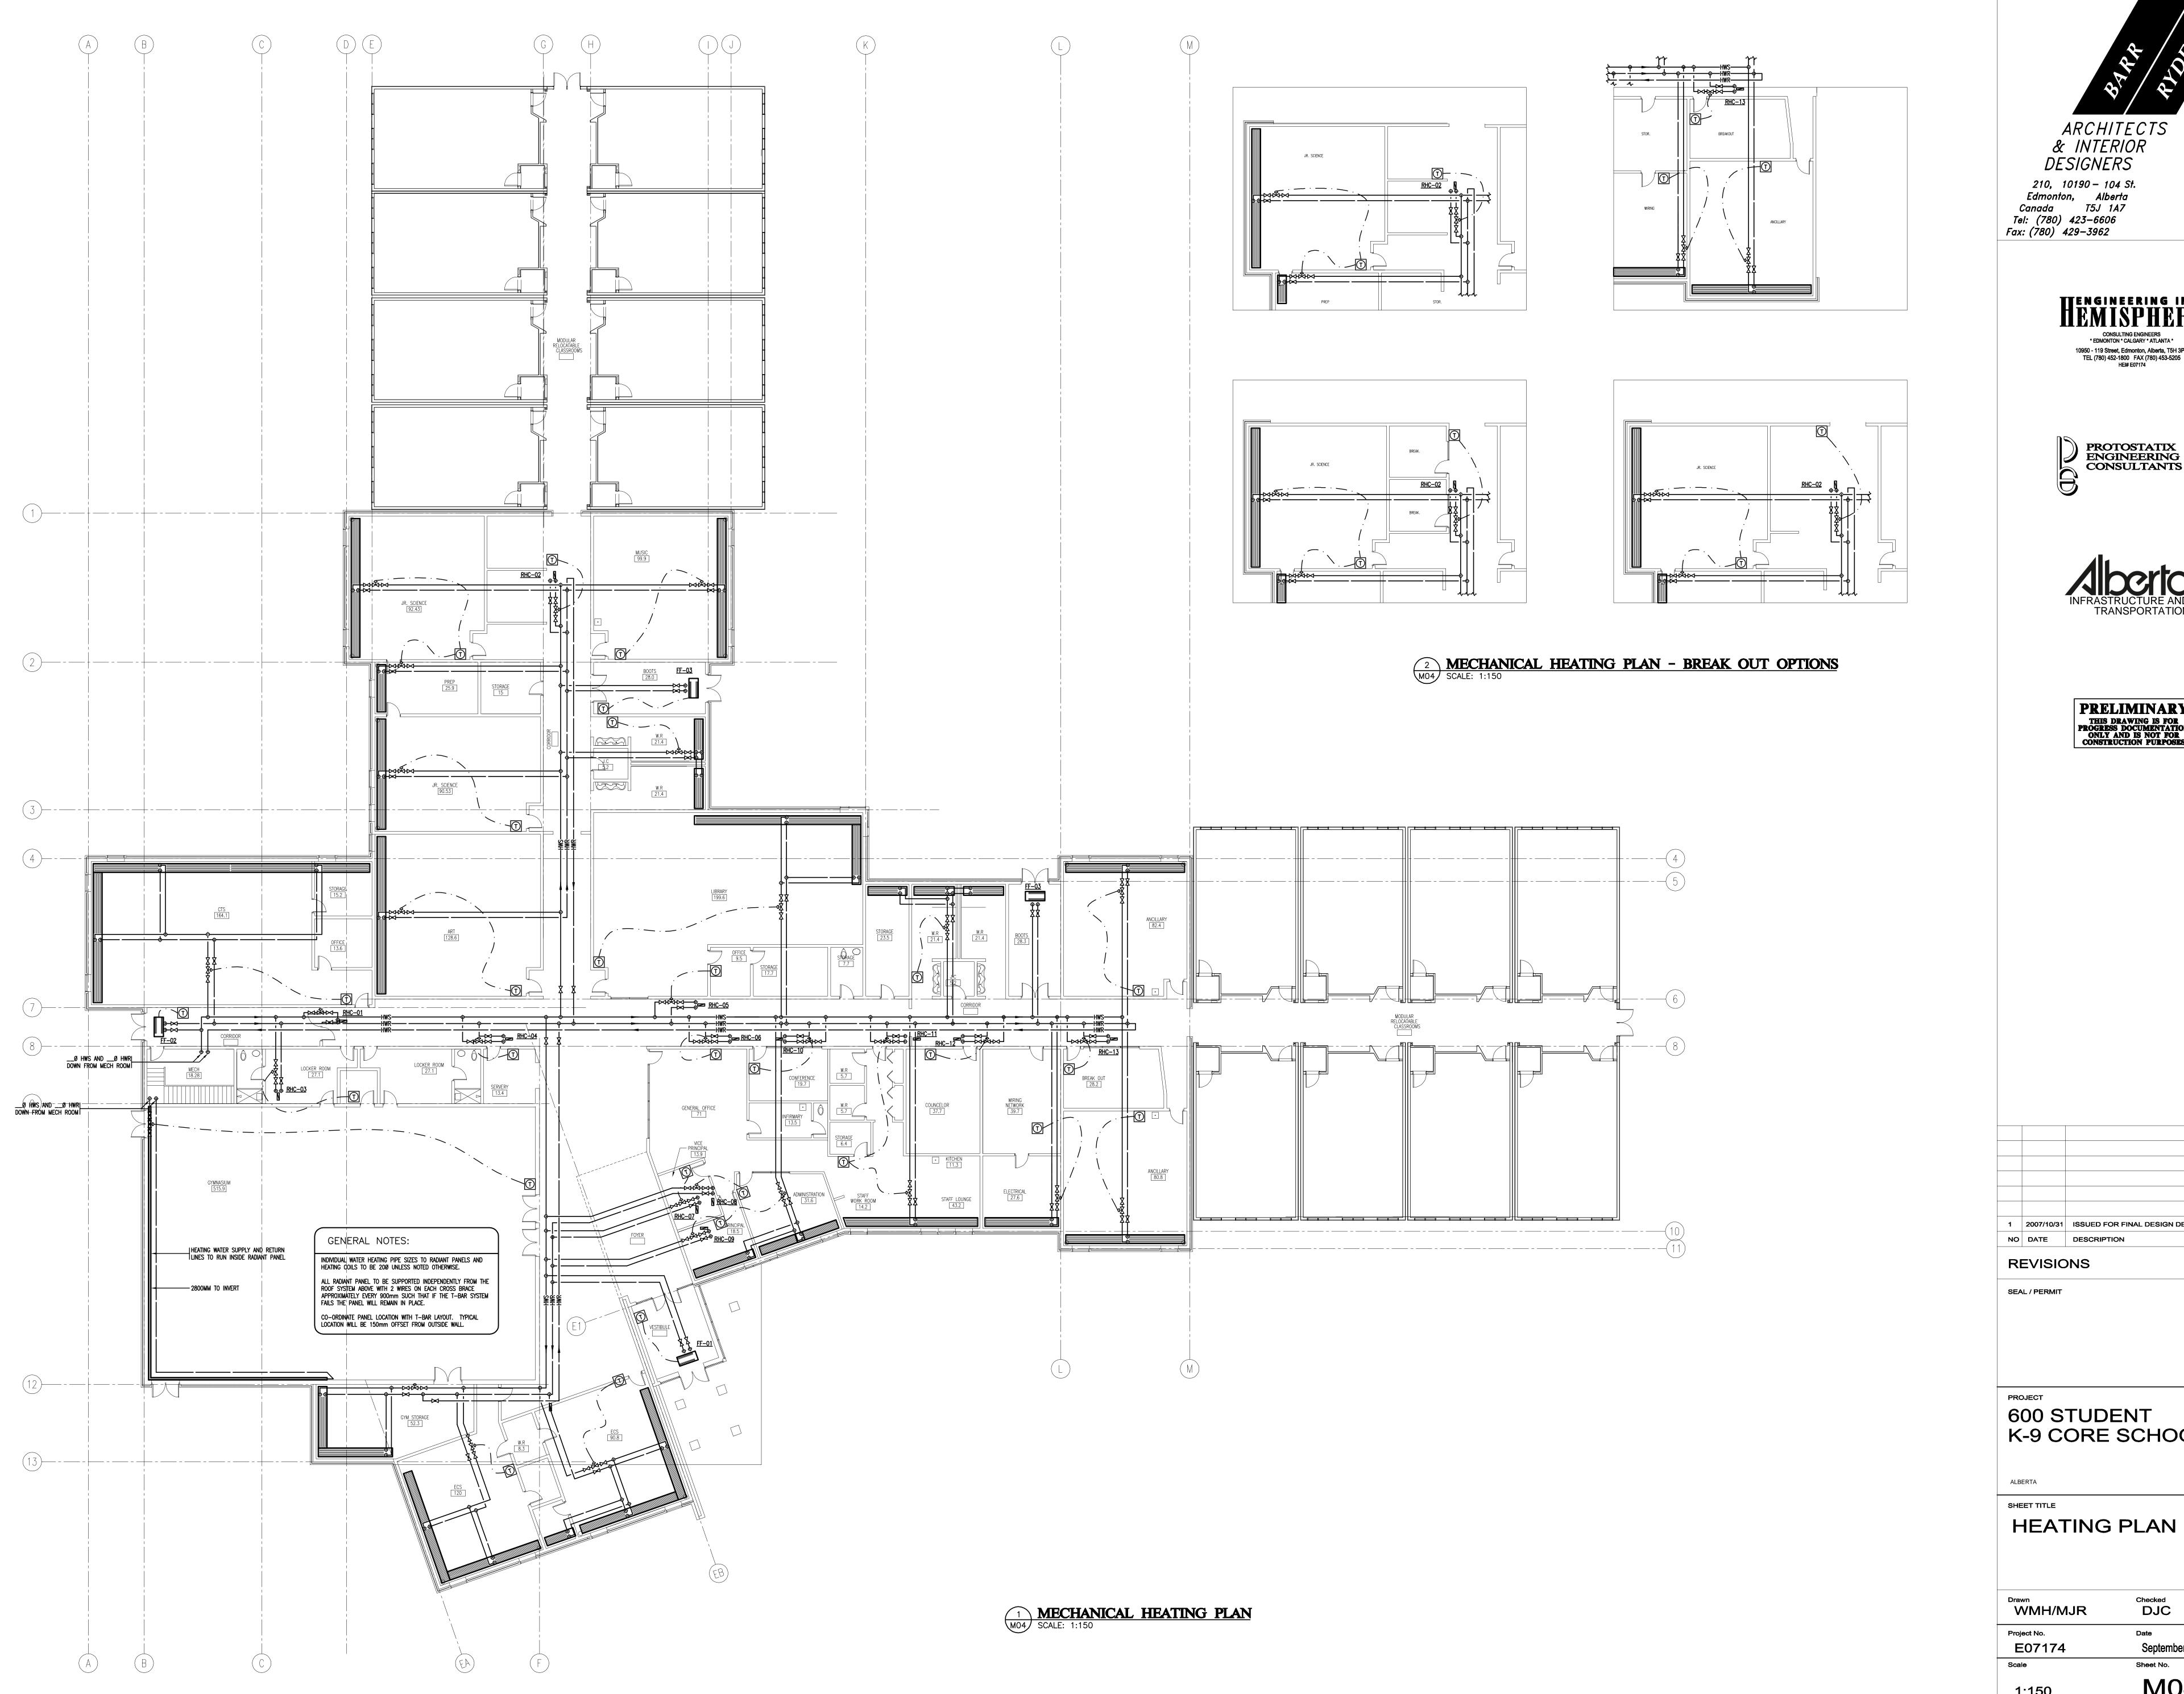








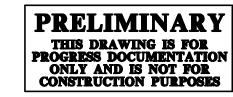


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NO	DATE	DESCRIPTION

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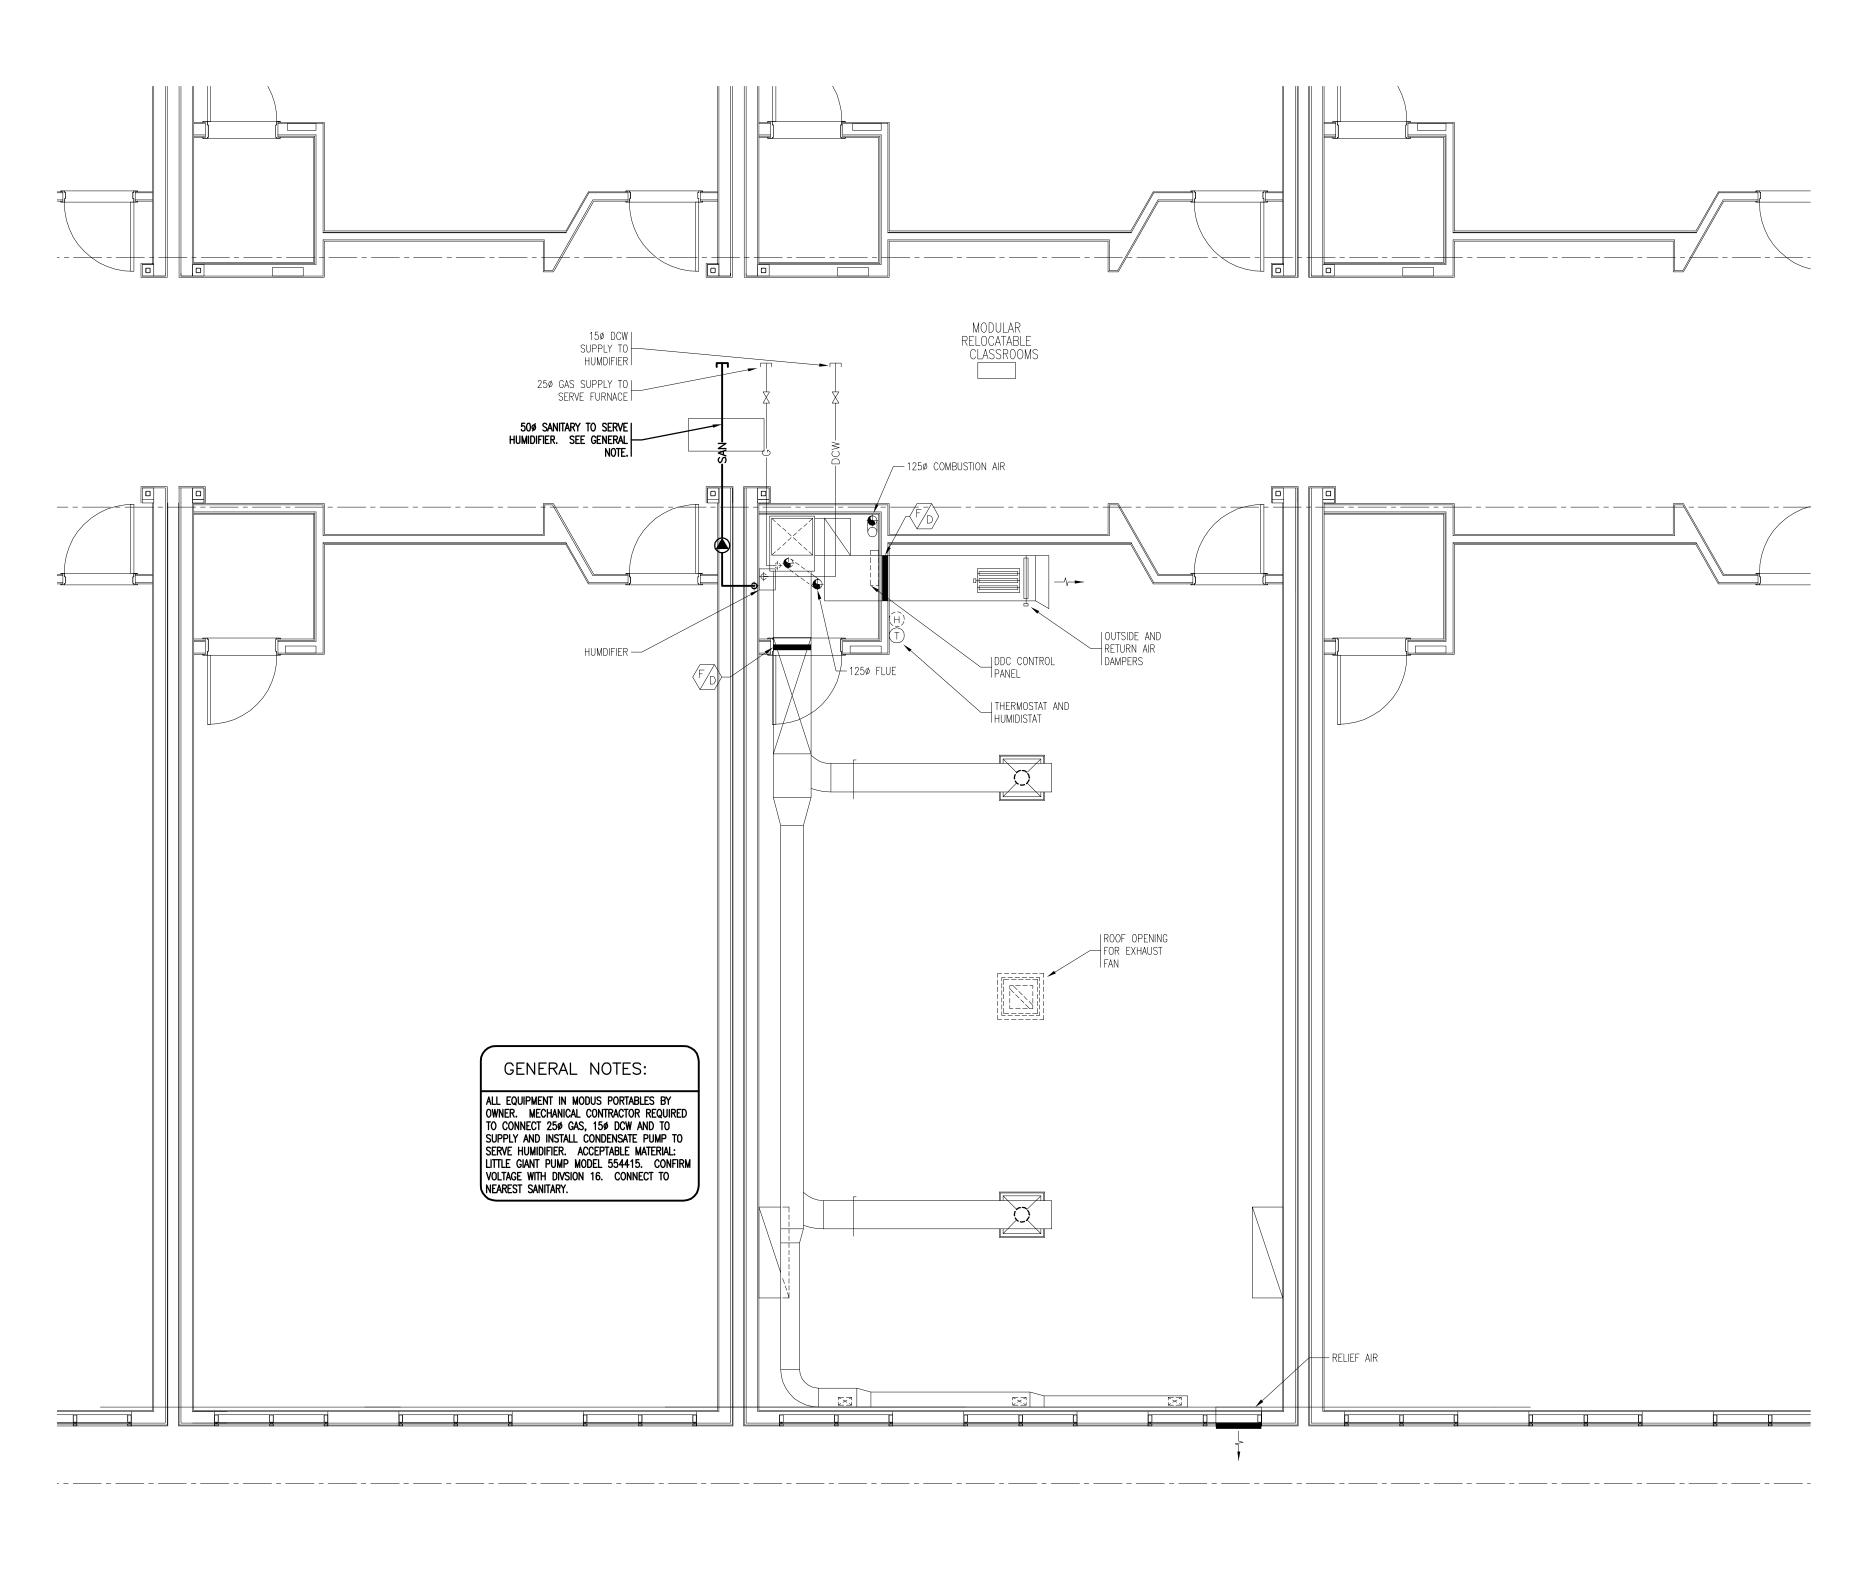
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Project No.	Date
E07174	September 18, 2007
Scale	Sheet No.
1:150	M04



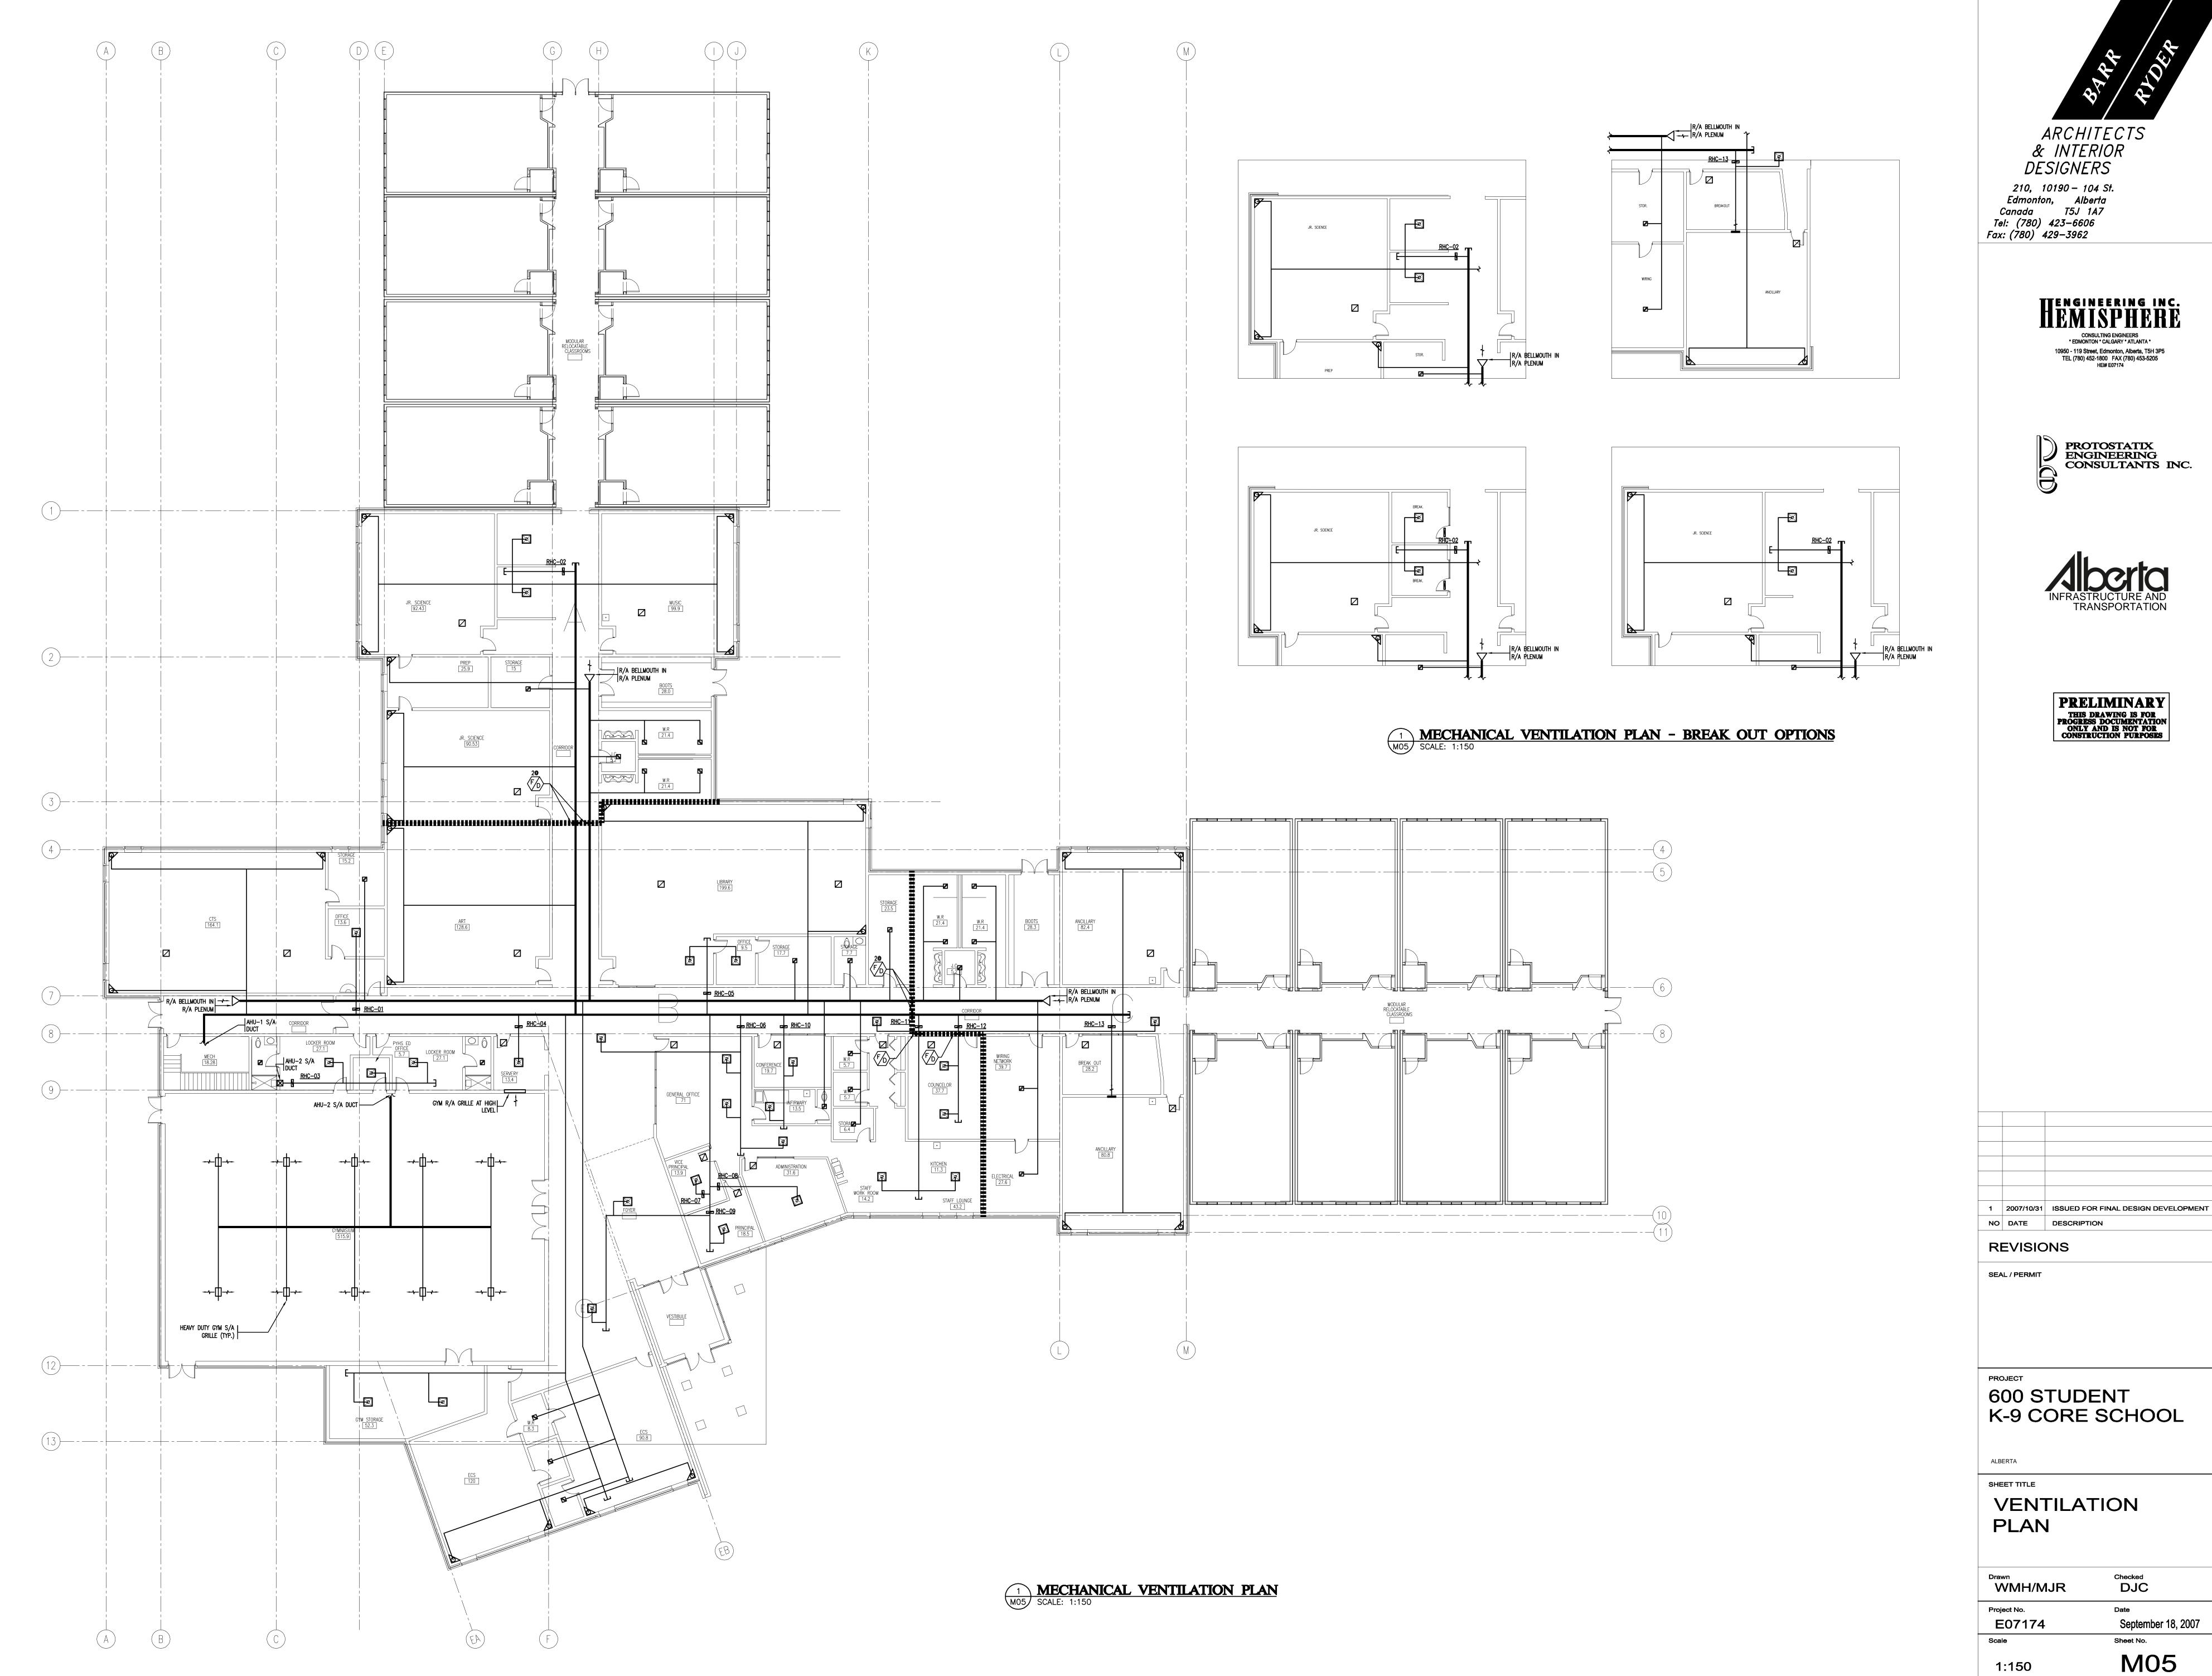

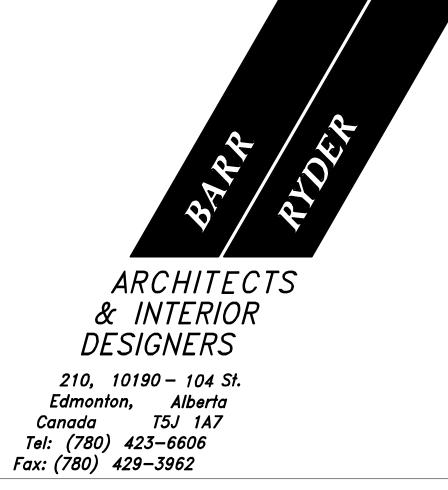
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NO	DATE	DESCRIPTION

Drawn	Checked
WMH/MJR	DJC
Project No.	Date
E07174	September 18, 2007
Scale	Sheet No.




1 TYPICAL PORTABLE CLASSROOM PLAN (BY OTHERS)

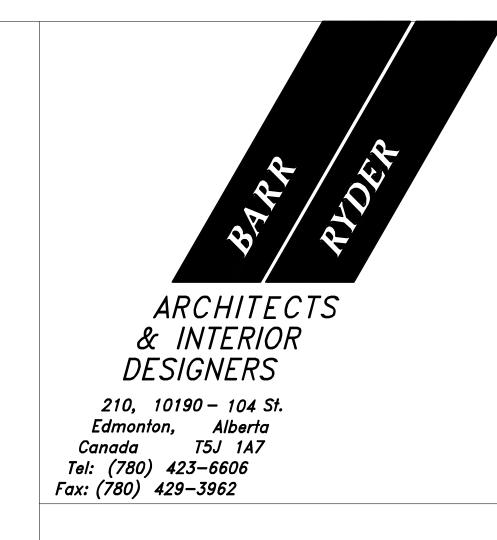







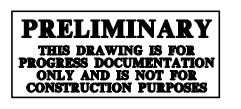

1	2007/10/31	ISSUED FOR FINAL DESIGN DEVELOPMENT
NO	DATE	DESCRIPTION

REVISIONS


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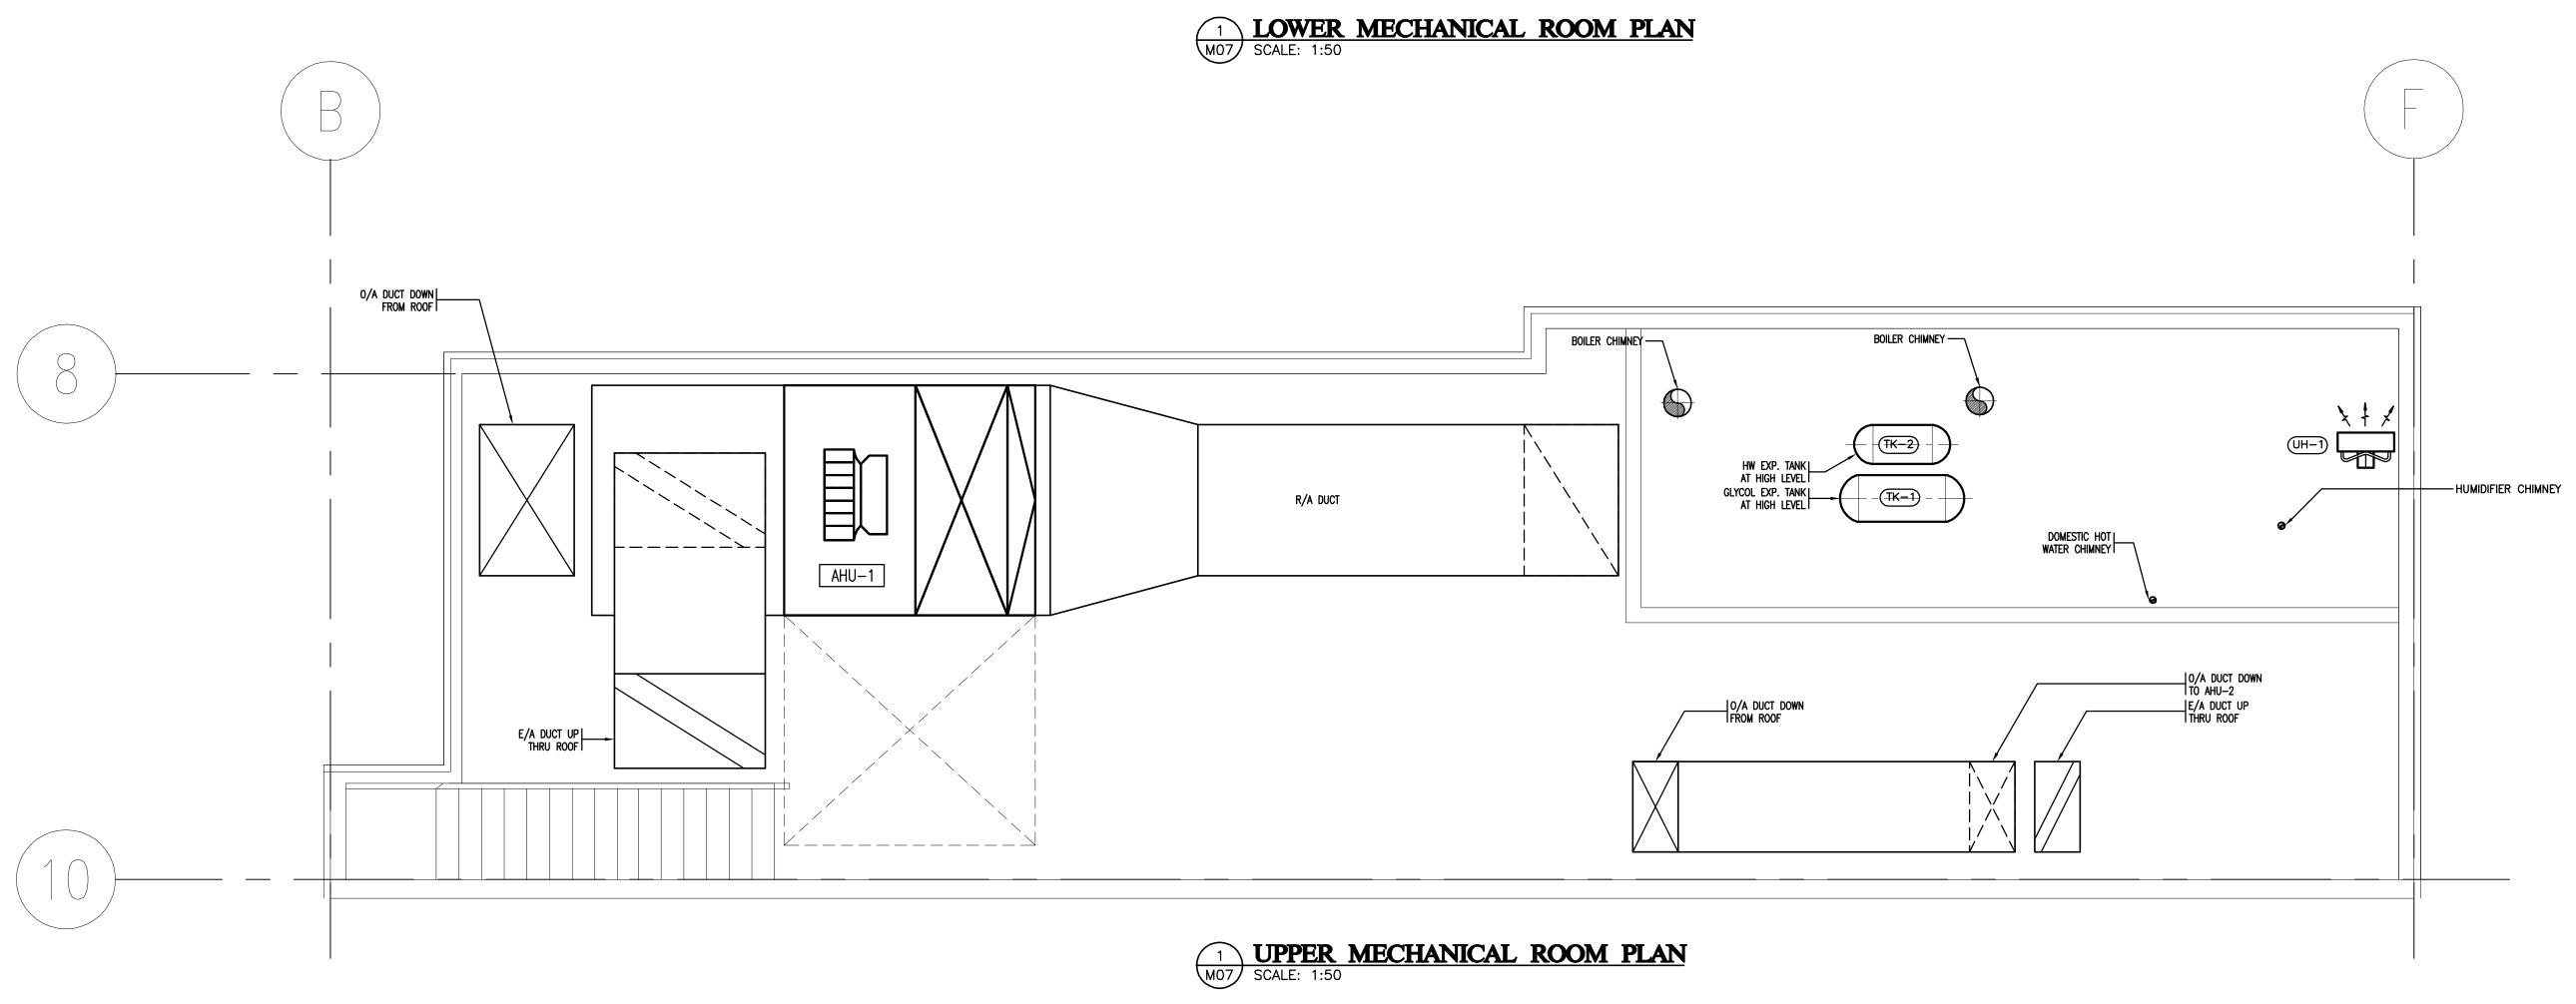
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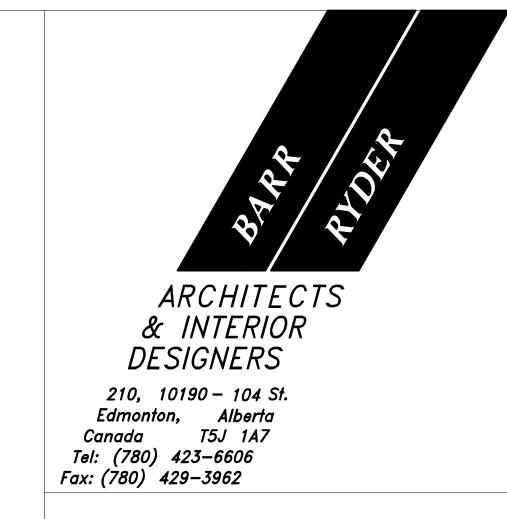
ALBE

TYPICAL
PORTABLE
CLASSROOM PLAN

Drawn WMH	I/MJR	Checked DJC	
Project N E071		Date September 18, 2007	
Scale		Sheet No.	
1:50		M06	





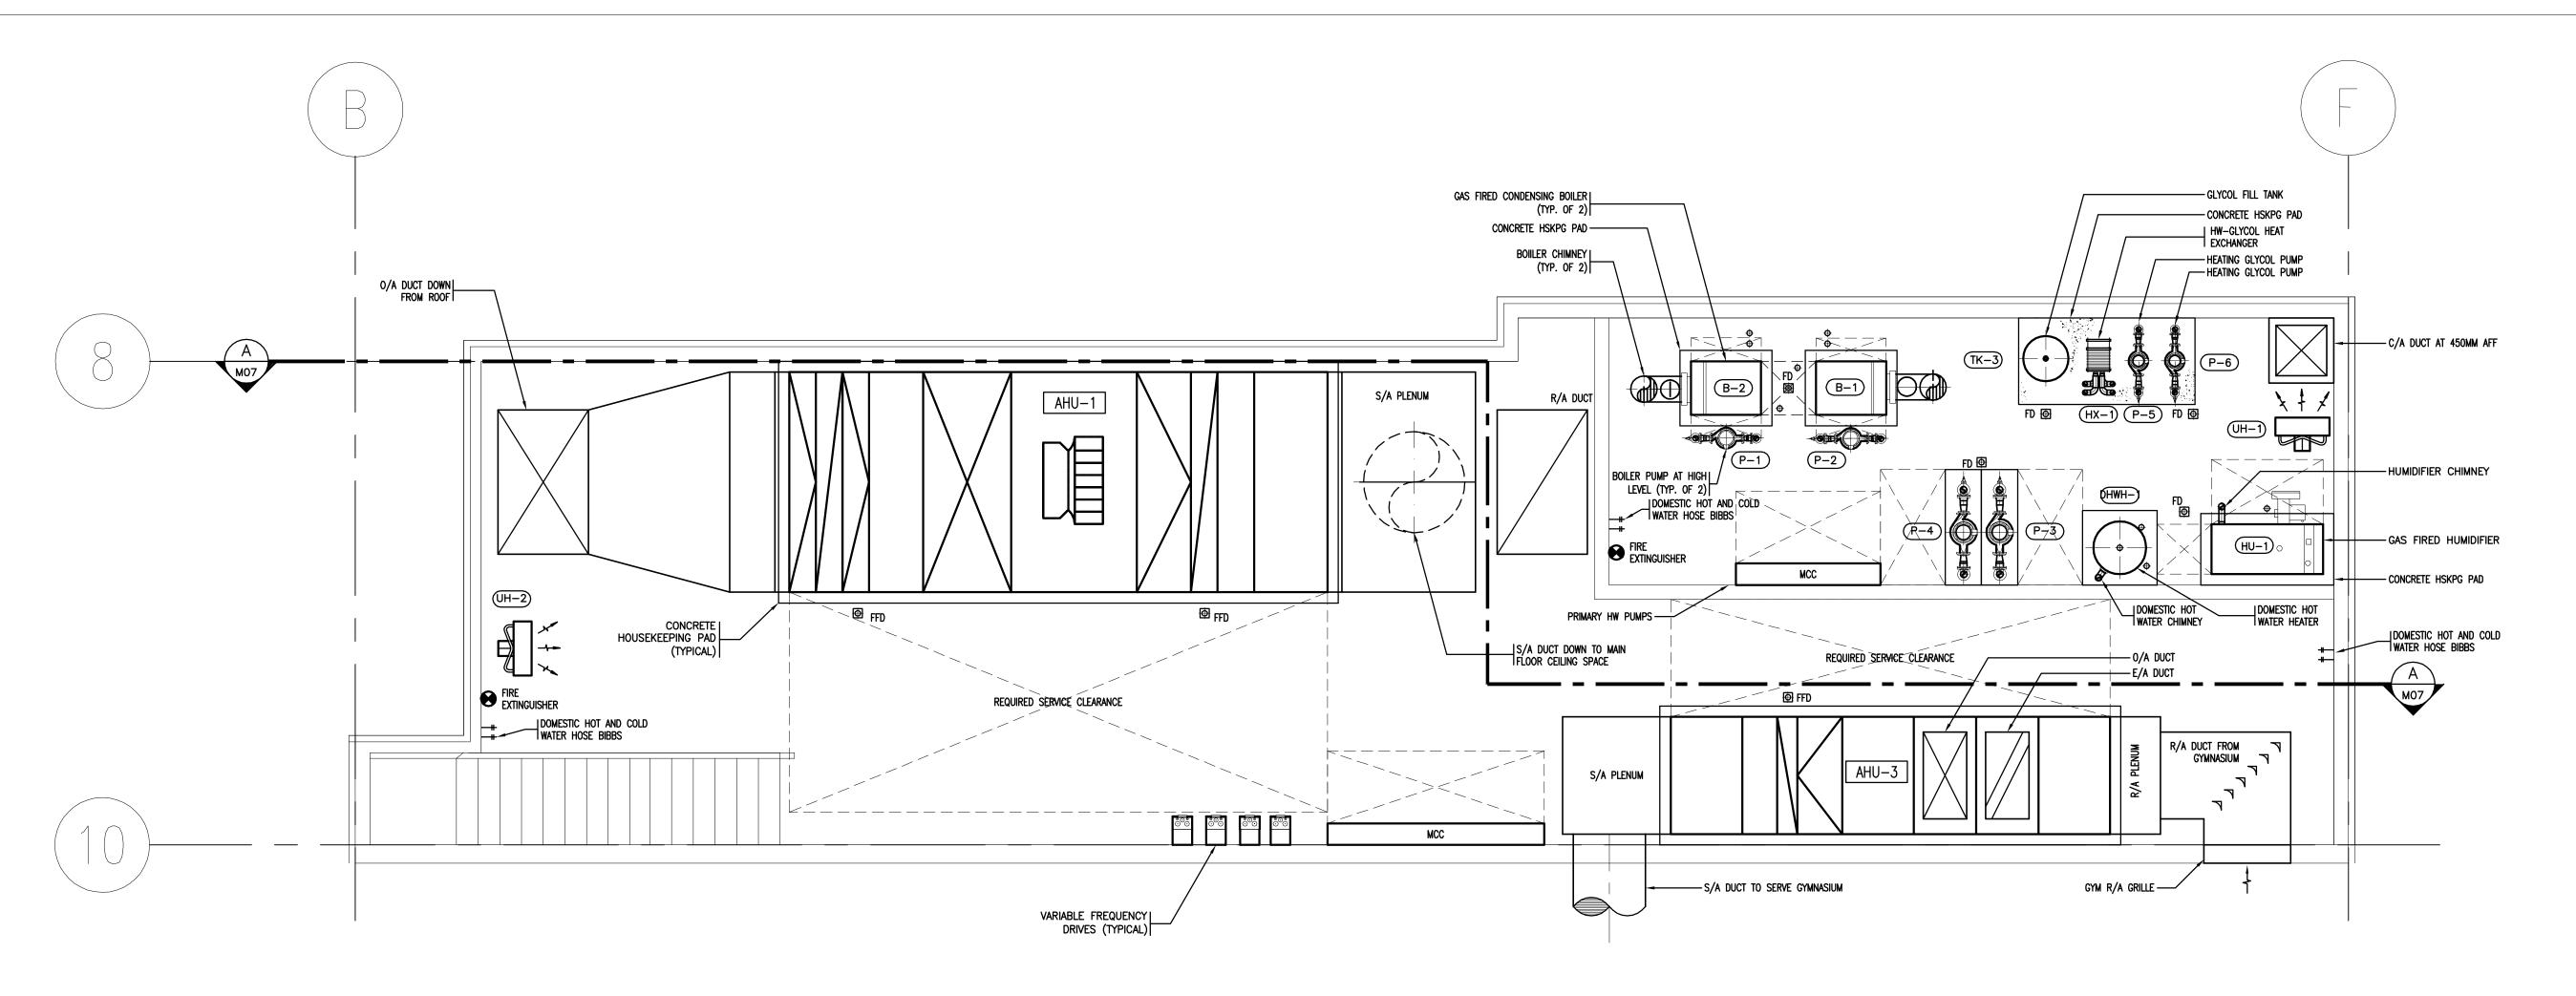









1	2007/10/31	ISSUED FOR FINAL DESIGN DEVELOPMENT
NO	DATE	DESCRIPTION

REVISIONS

SEAL / PERM


600 STUDENT K-9 CORE SCHOOL

ALBERTA


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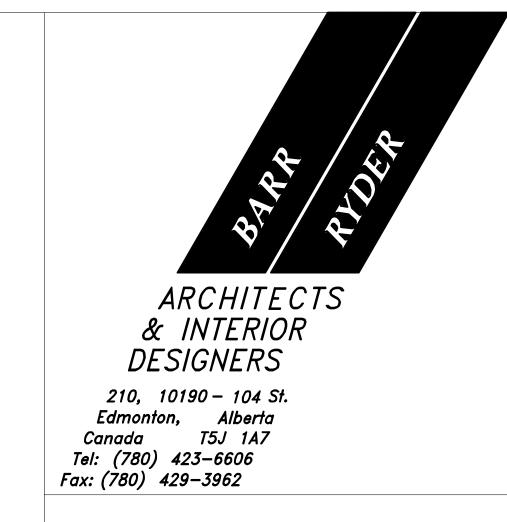
MECHANICAL ROOM PLANS AND SCHEMATICS

MJR		DJC
Project No.		Date
E07	174	September 18, 2007
Scale		Sheet No.
ASN	NOTED	M07

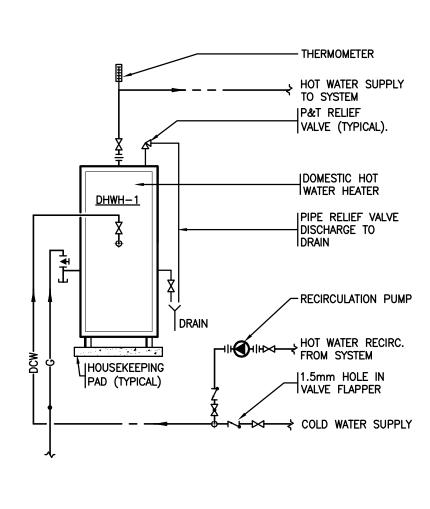

DOMESTIC WATER HEATER PIPING SCHEMATIC MOB SCALE: N.T.S.




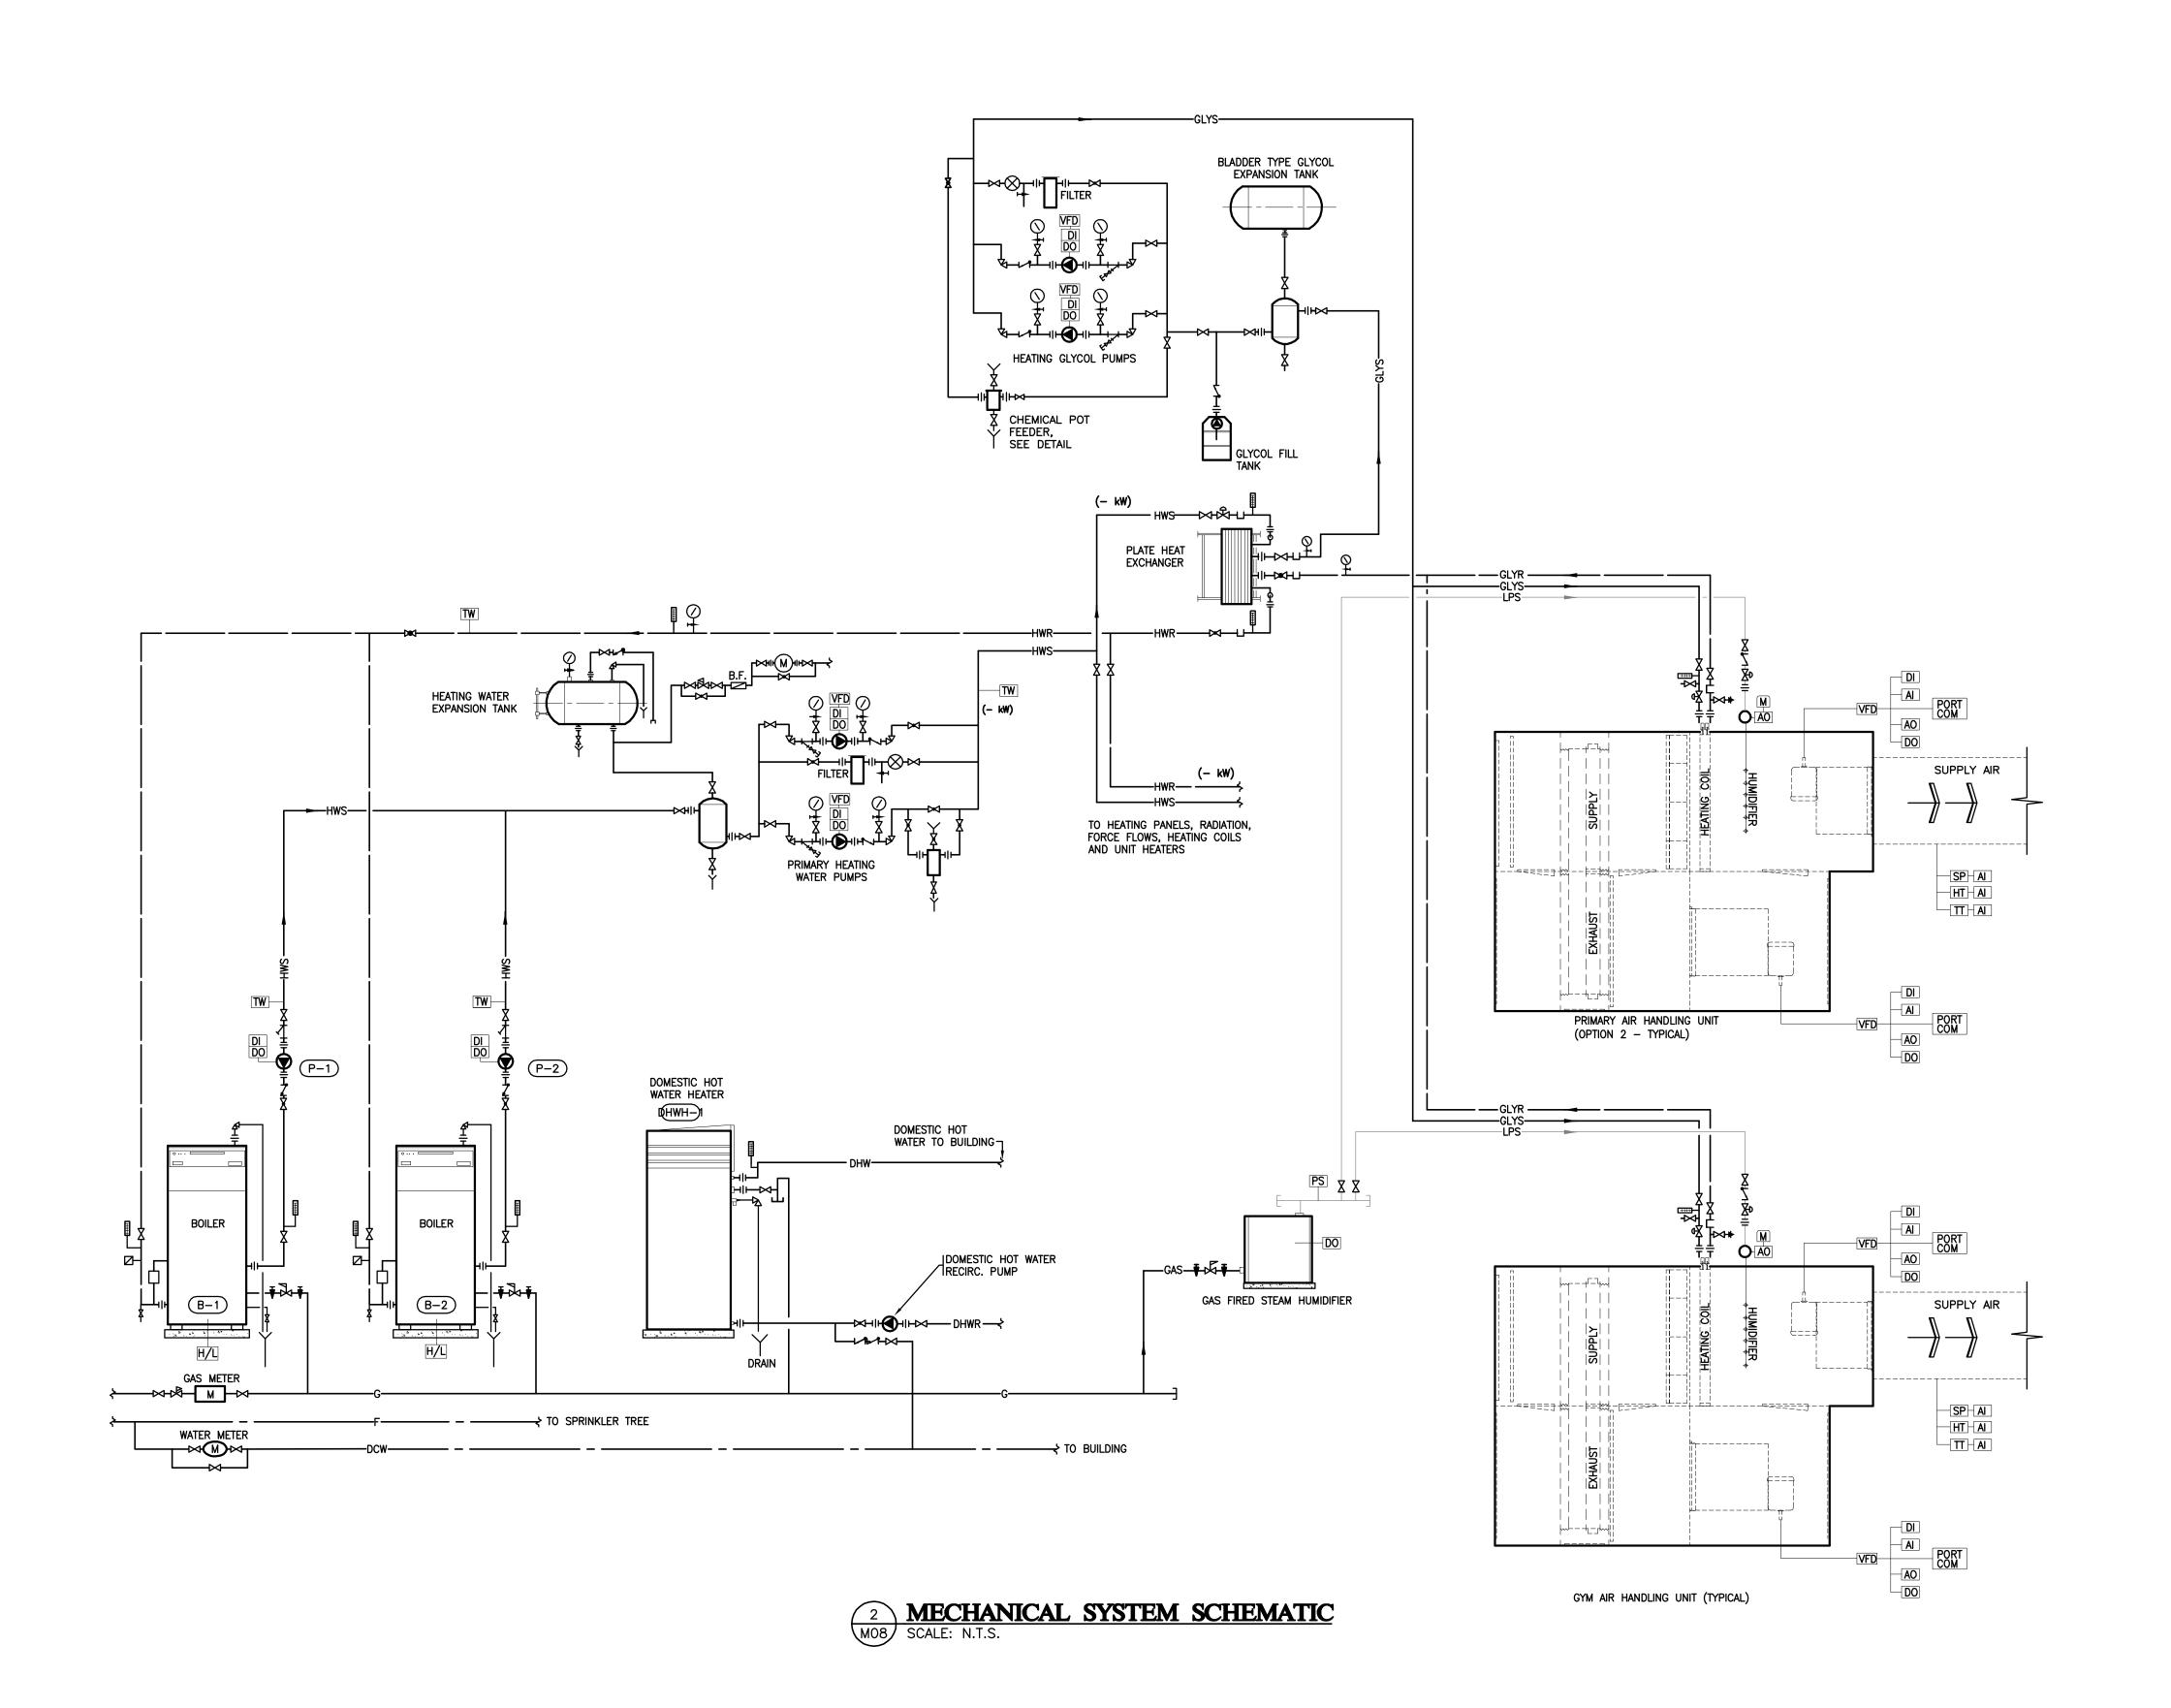







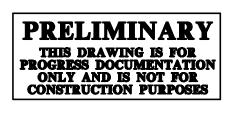

1	2007/10/31	ISSUED FOR FINAL DESIGN DEVELOPMENT
NO	DATE	DESCRIPTION

REVISIONS

SEAL / PER


600 STUDENT K-9 CORE SCHOOL

ALBE


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SCHEMATICS


WMH/MJR	Checked DJC
Project No.	Date
E07174	September 18, 2007
Scale	Sheet No.
AS NOTED	M08

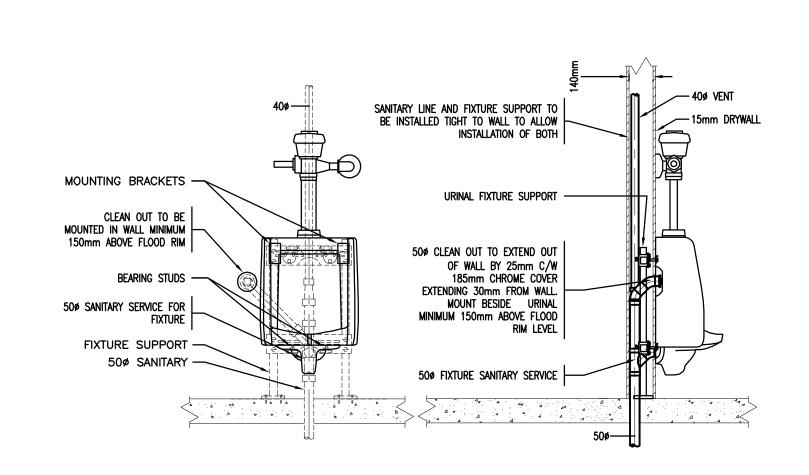


1 WALL MOUNTED URINAL DETAIL MO9 NTS

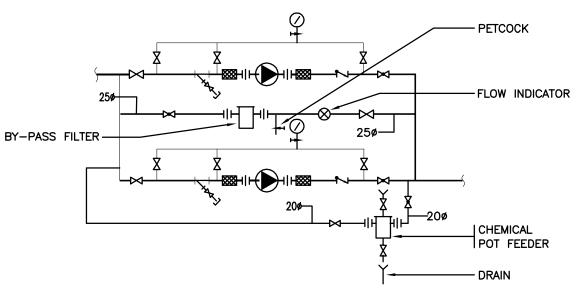

CHEMICAL POT FEEDER & BYPASS FILTER ASSEMBLY NTS

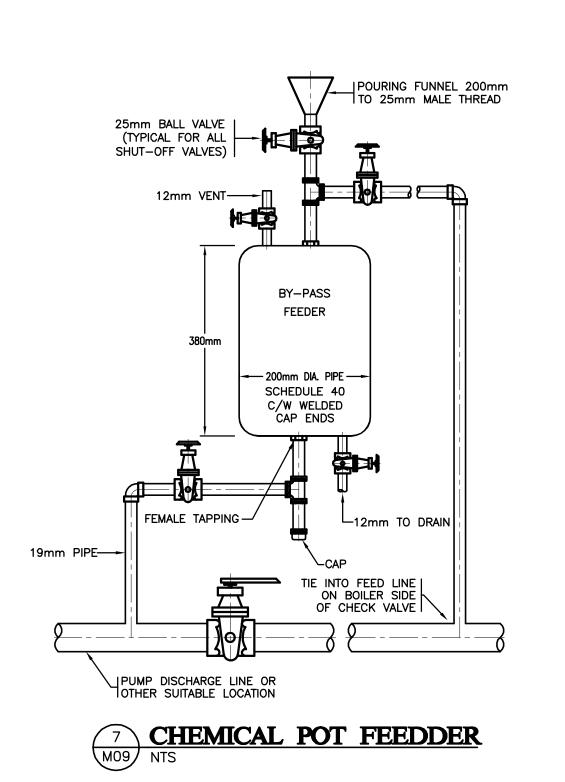

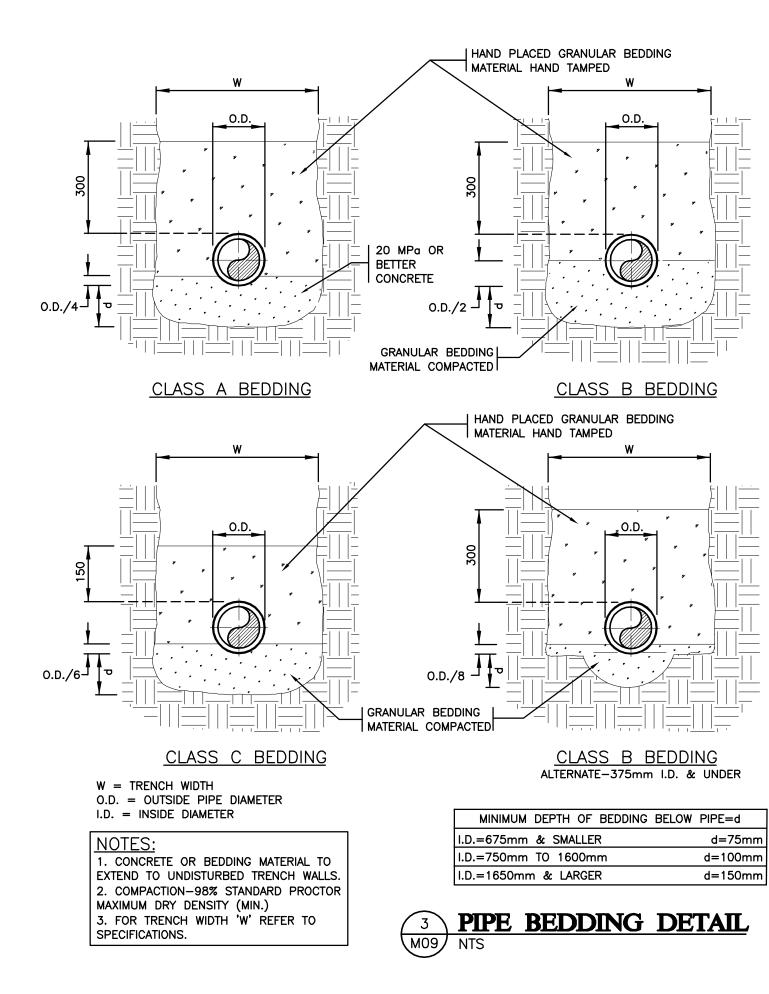


6mm GALVANIZED
SPACER PLATE
(TYPICAL OF 2)


AIR SPACE (MIN. 50mm)


INSULATION


8 SERVICE ENTRY DETAIL
NTS

__CLOSE CULVERTS OFF WITH

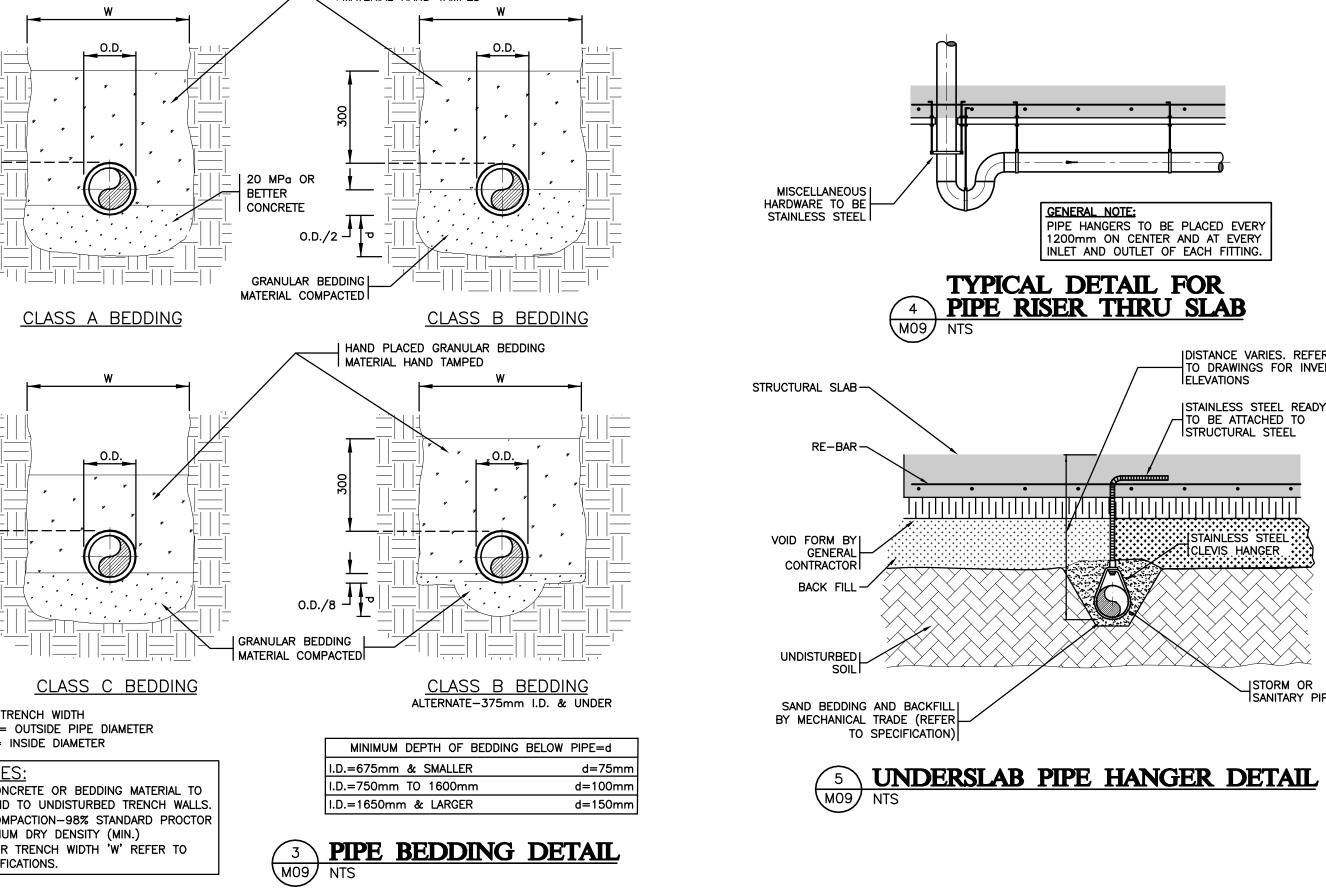

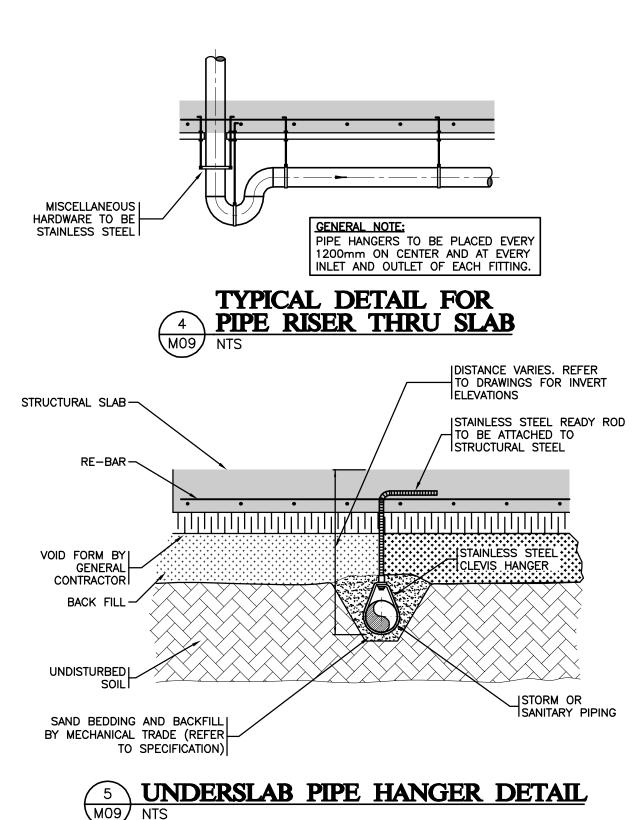


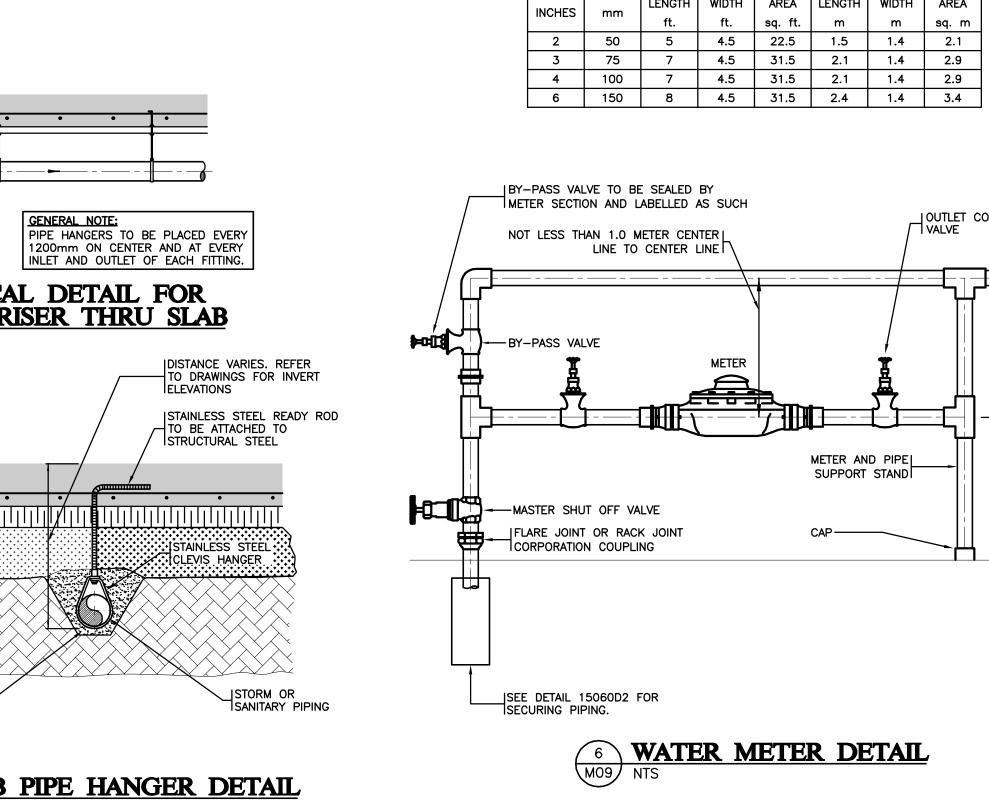

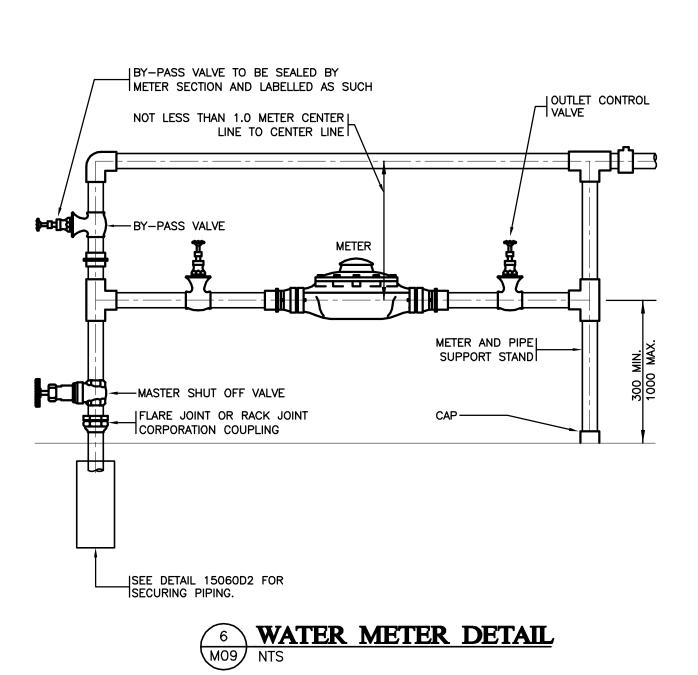

MAXIMUM FLOOR AREA REQUIRED


LENGTH WIDTH AREA LENGTH WIDTH AREA

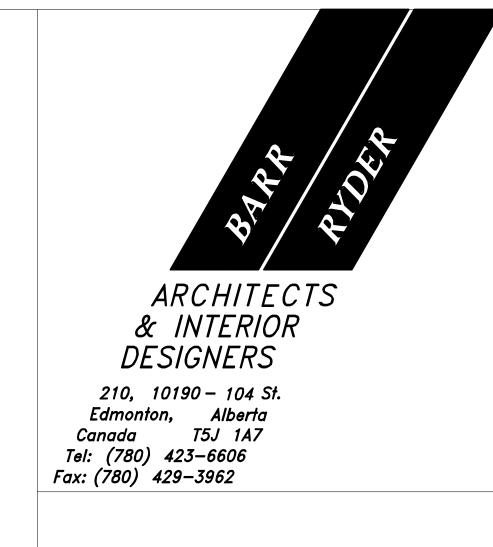







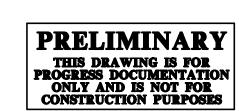

	2007/10/31	ISSUED FOR FINAL DESIGN DEVELOPMENT
0	DATE	DESCRIPTION

REVISIONS


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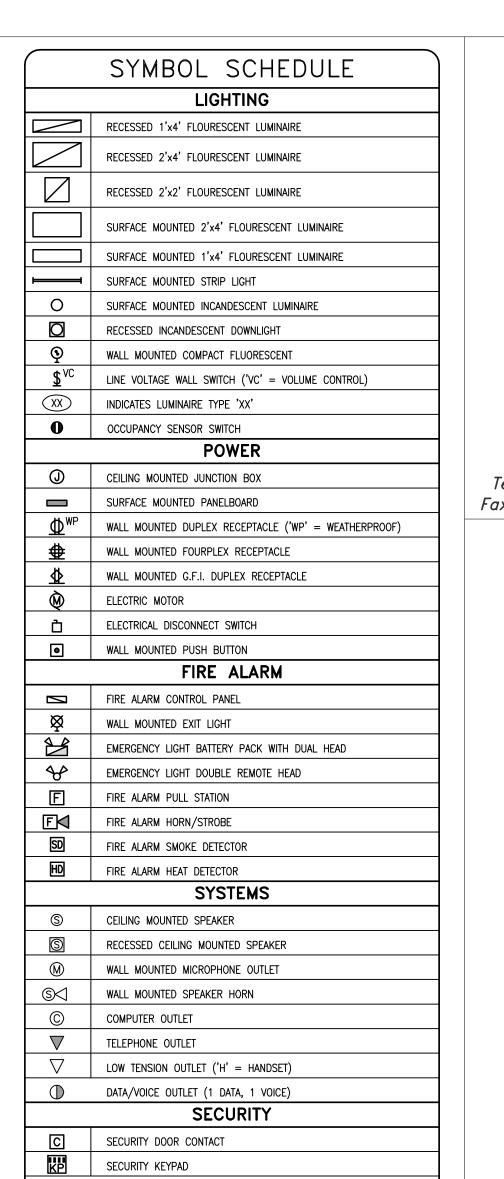
PROJECT 600 STUDENT K-9 CORE SCHOOL


SHEET TITLE **DETAILS**

Checked DJC

Project No.	Date
E07174	September 18, 2007
Scale	Sheet No.
AS NOTED	M09



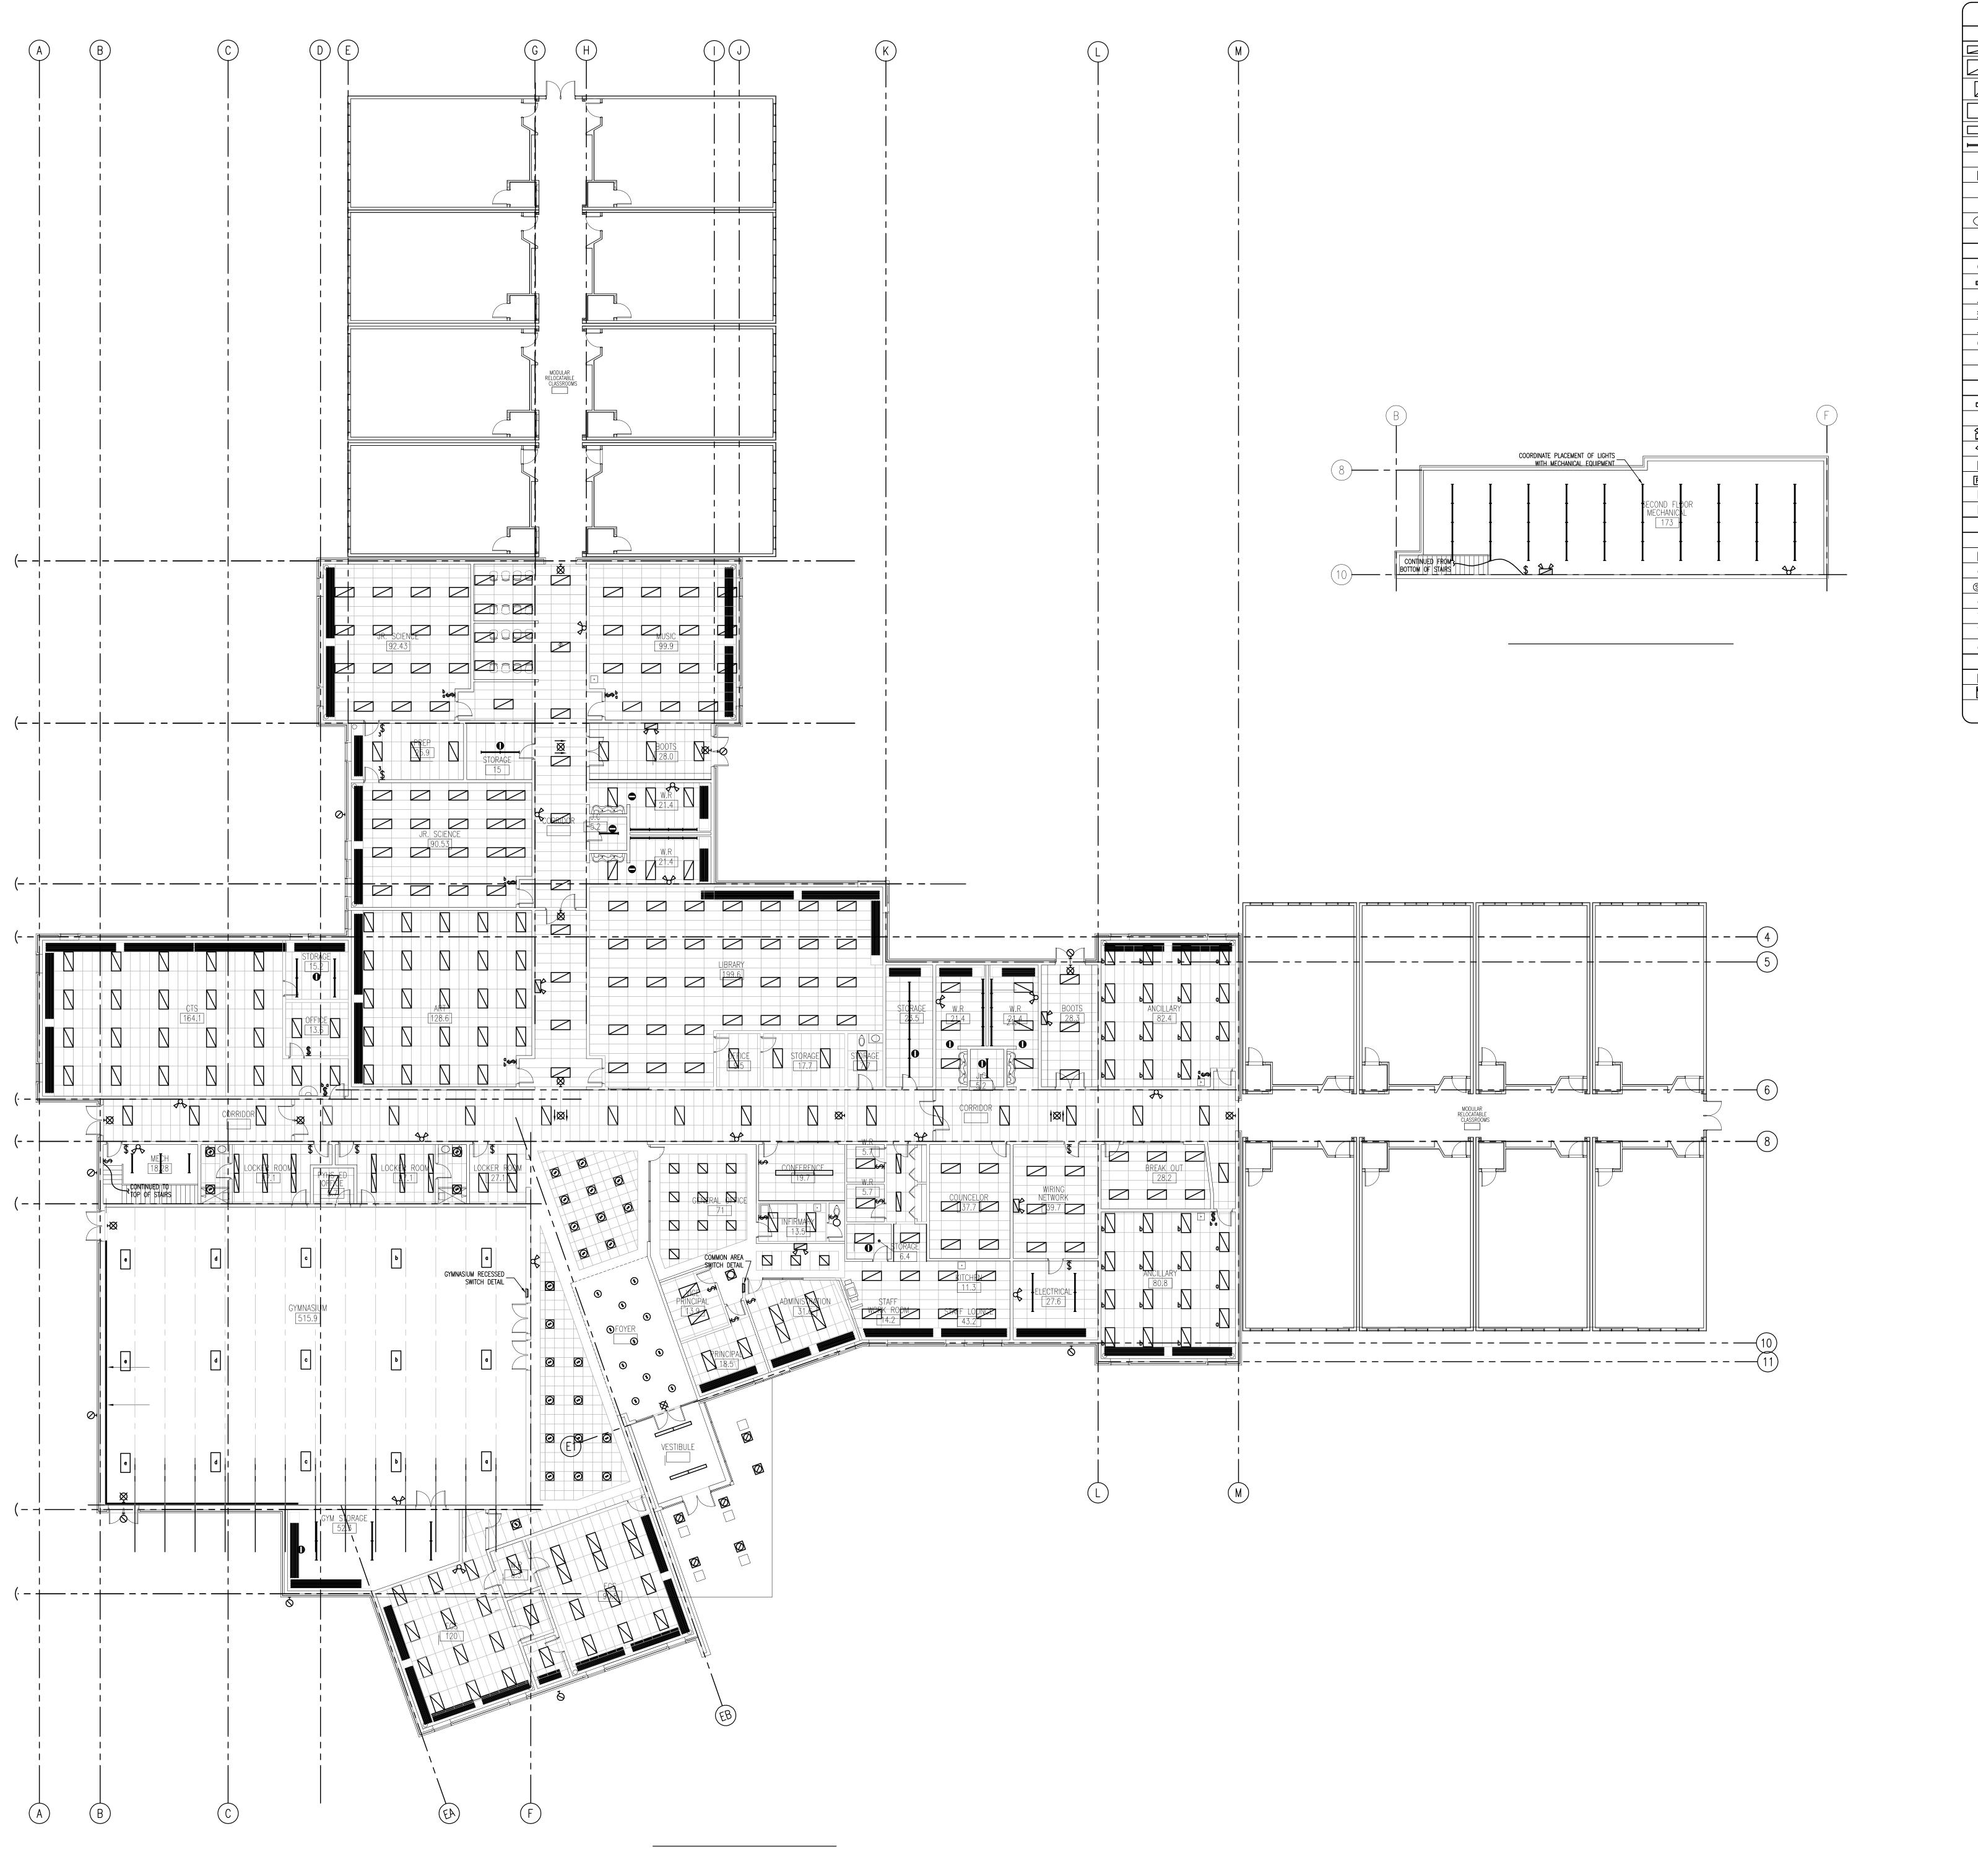

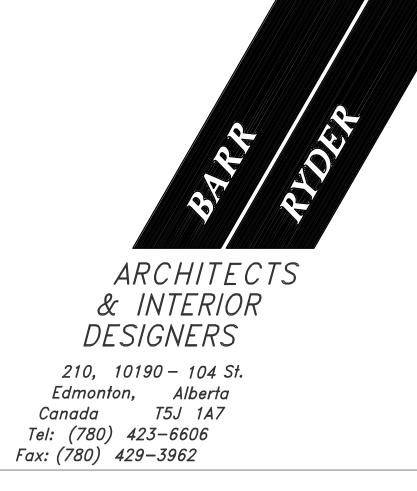

HENGINEERING INC.

CONSULTING ENGINEERS

CONSULTING ENGINEERS
* EDMONTON * CALGARY * ATLANTA *

10950 - 119 Street, Edmonton, Alberta, T5H 3P5
TEL (780) 452-1800 FAX (780) 453-5205
HEI# E07174







1	2007/10/31	ISSUED FOR FINAL DESIGN DEVELOPMENT
NO	DATE	DESCRIPTION

REVISIONS

SEAL / PERM


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600 STUDENT K-9 CORE SCHOOL

ALBERTA

LIGHTING PLAN

Drawn	Checked
DPB	BPR
Project No.	Date
27335	SEPTEMBER 21, 2007
Scale	Sheet No.
1:150	E1

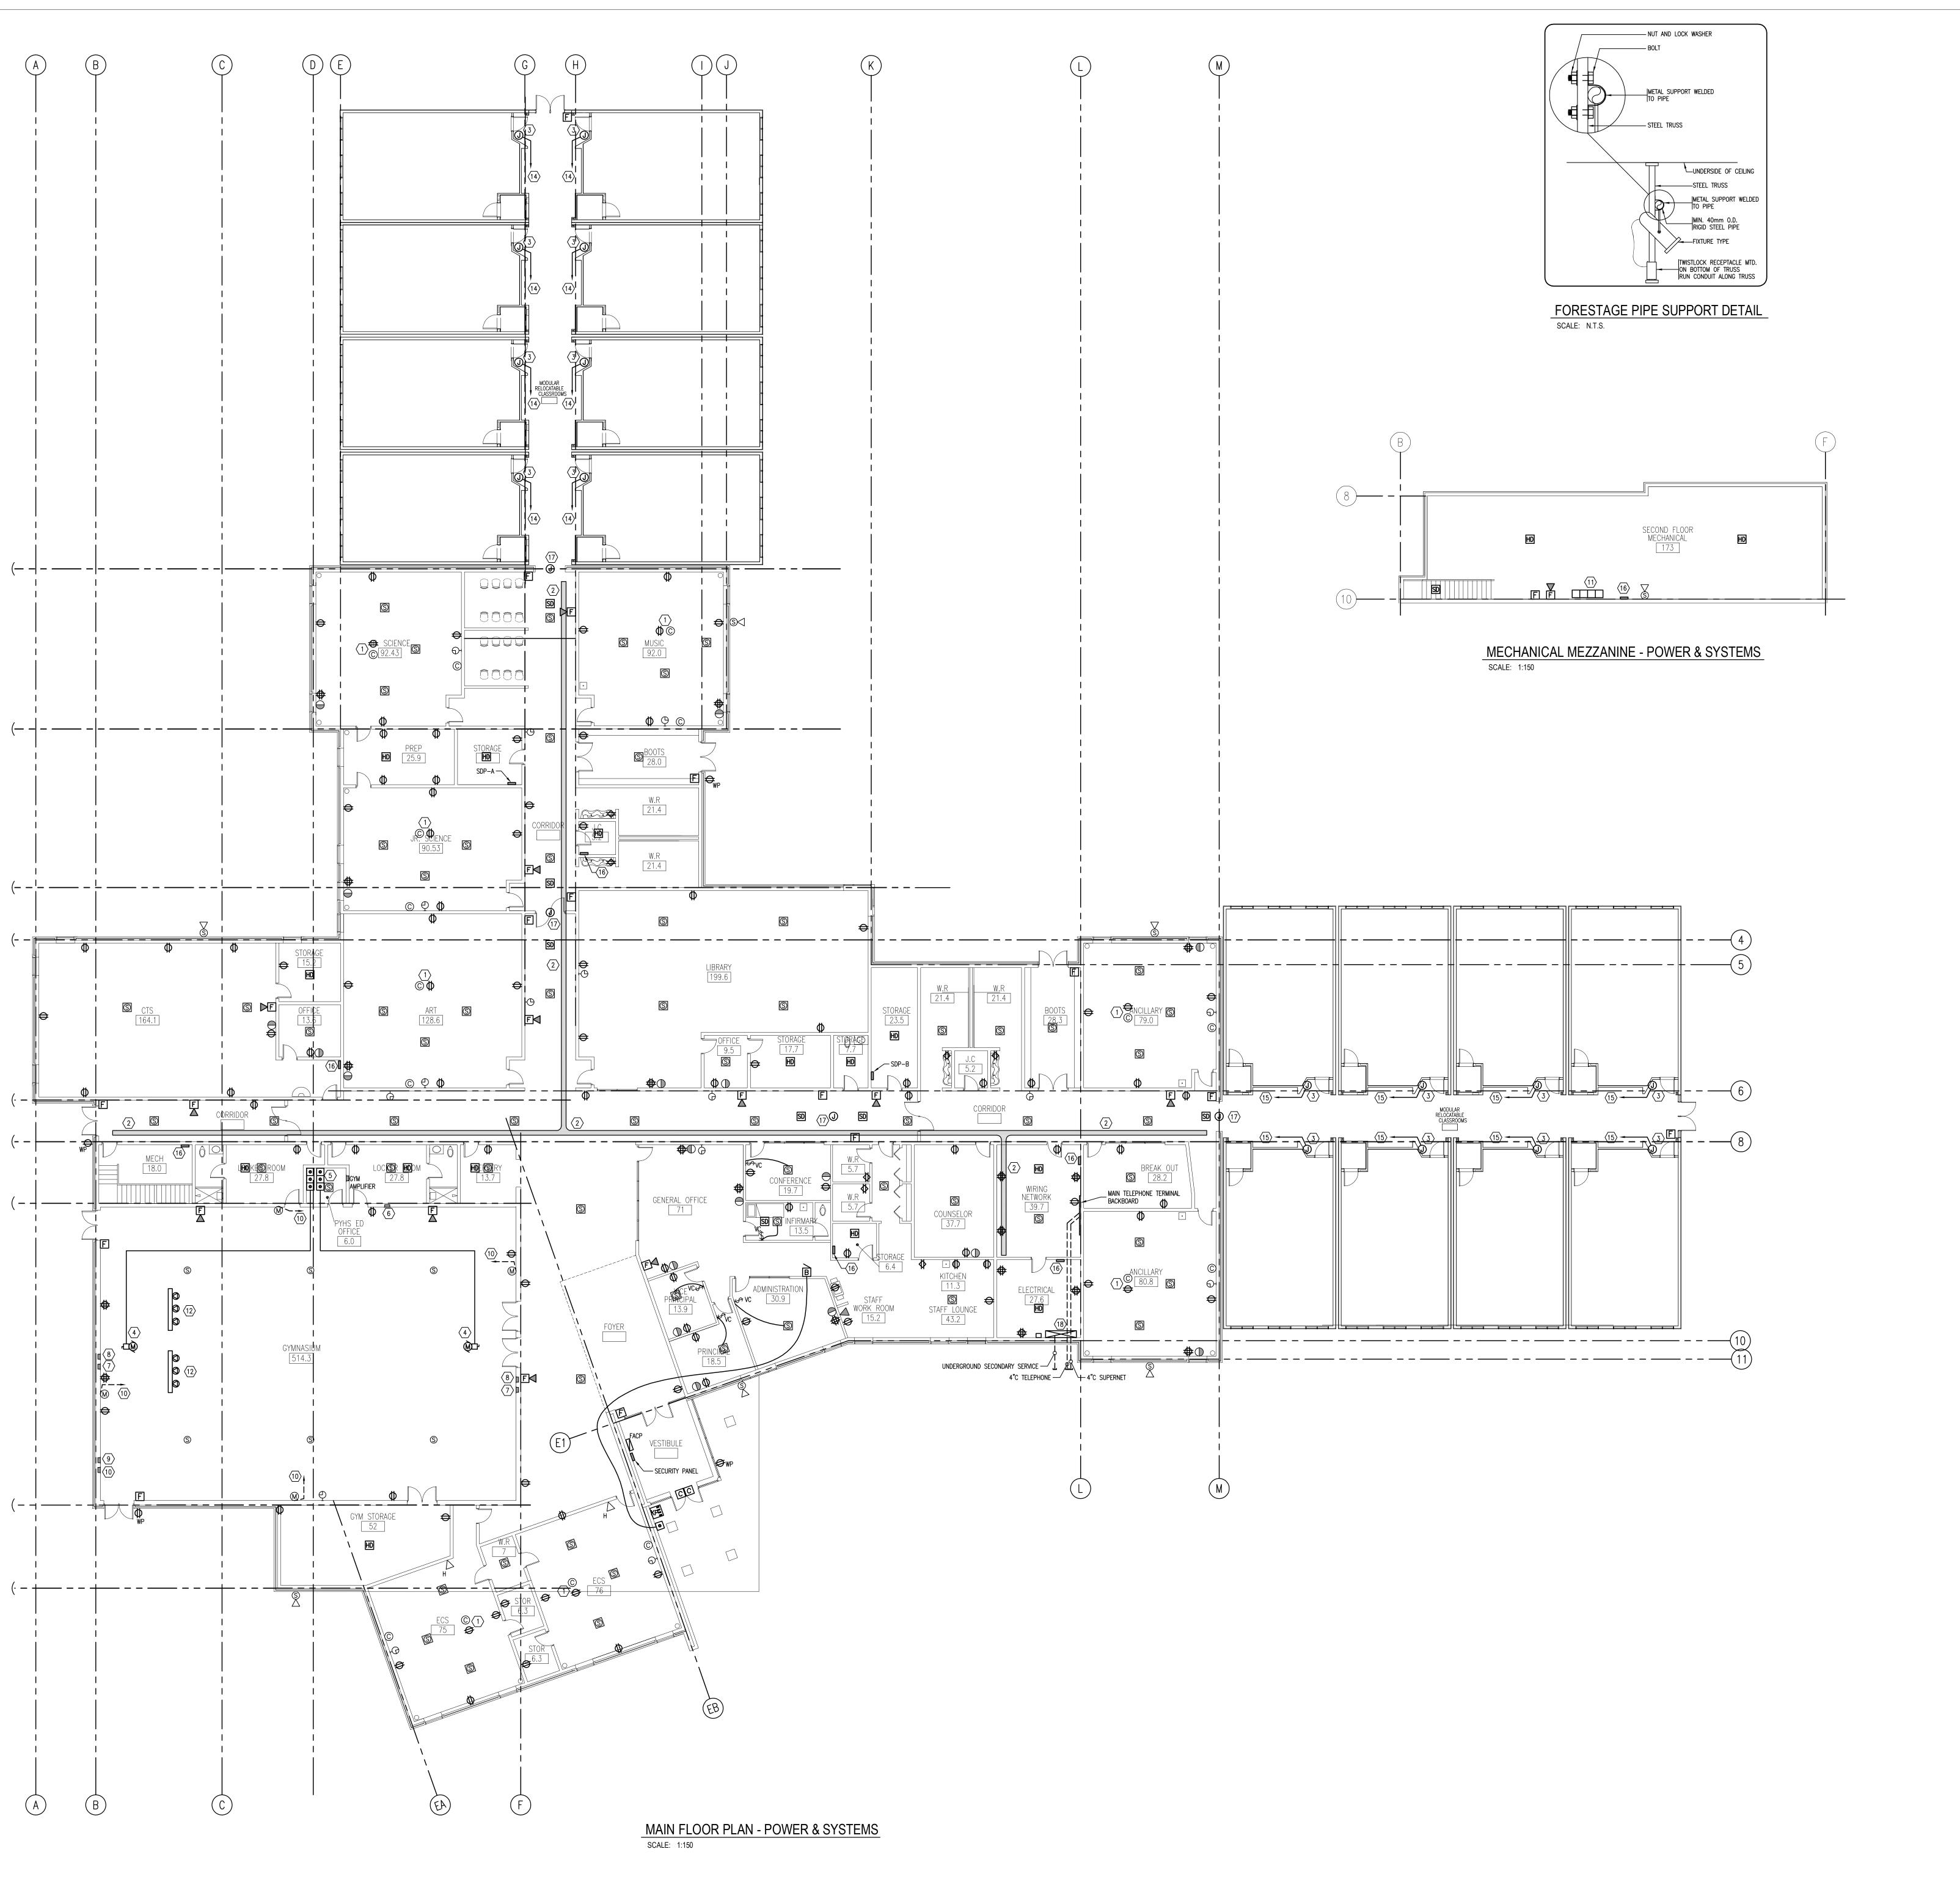

KEY NOTES:

OVERHEAD PROJECTOR DATA AND POWER CONNECTION. COORDINATE AND CONFIRM EXACT LOCATION OF PROJECTOR WITH GENERAL CONTRACTOR PRIOR TO

2 LADDER TYPE CABLE TRAY ACCESSIBLE FROM CEILING SPACE.

3 JUNCTION BOX FOR POWER CONNECTION TO MODULAR CLASSROOMS.

4 MOTORIZED BACKBOARDS.

5 CONTROLLERS: UP, DOWN AND STOP FOR MOTORIZED BACKBOARDS.

6 JUNCTION BOX FOR CONTROL OF SCOREBOARD.

7 JUNCTION BOX FOR SHOT CLOCK MOUNTED AT 2400mm AFF.

8 JUNCTION BOX FOR POWER TO SHOT CLOCK.

9 JUNCTION BOX FOR CONTROL OF SCOREBOARD

8 JUNCTION BOX FOR POWER TO SHOT CLOCK.

9 JUNCTION BOX FOR CONTROL OF SCOREBOARD MOUNTED AT 3300mm AFF.

10 JUNCTION BOX FOR POWER TO SCOREBOARD MOUNTED AT 3300mm AFF.

11 RUN 21mmC TO AMPLIFIER IN PHYS-ED OFFICE.

12 MOTOR CONTROL CENTER.

13 TWISTLOCK RECEPTACLES FOR FORESTAGE LIGHTING — REFER TO DETAIL.

14 RUN TO SUB DISTRIBUTION PANEL 'A'.

15 RUN TO SUB DISTRIBUTION PANEL 'B'.

16 BRANCH CIRCUIT PANEL.

17 JUNCITON BOX FOR DOOR SENTRONICS. TIE INTO FIRE ALARM SYSTEM.

(18) MAIN DISTRIBUTION CENTRE.

Fax: (780) 429-3962

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HEMISPHERE

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CONSULTING ENGINEERS
* EDMONTON * CALGARY * ATLANTA *

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1	2007/10/31	ISSUED FOR FINAL DESIGN DEVELOPMENT
NO	DATE	DESCRIPTION

REVISIONS

SEAL / PERMI

PROJECT
600 STUDENT

K-9 CORE SCHOOL

ALBERTA

POWER &
SYSTEMS PLAN

Drawn	Checked	
DPB	BPR	
Project No.	Date	
27335	SEPTEMBER 21, 2007	
Scale	Sheet No.	
1:150	F2	
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