

# PROPOSED NEW K-9 (900 STUDENTS) CORE SCHOOL Design Development Report

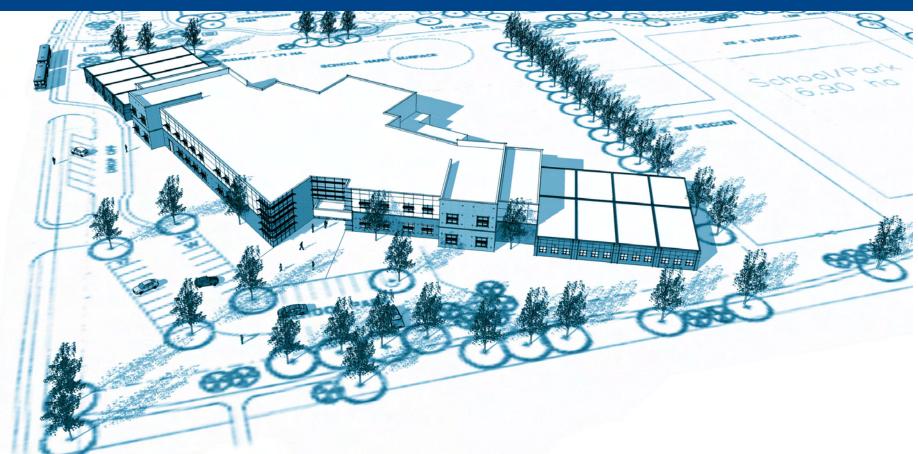

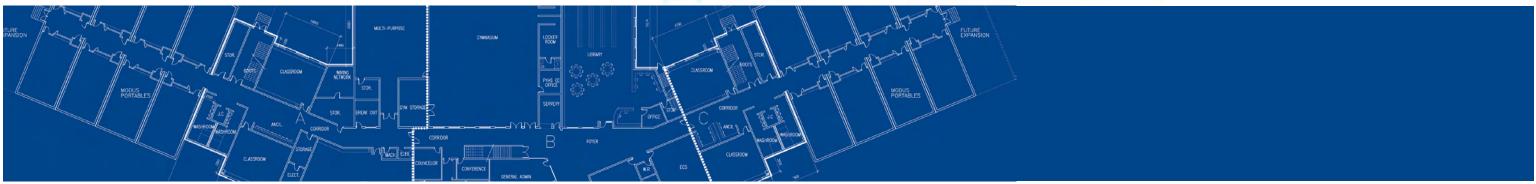






Alberta Infrastructure and Transportation





"Helping Build Communities"

Project No. 27340


November 12, 2007

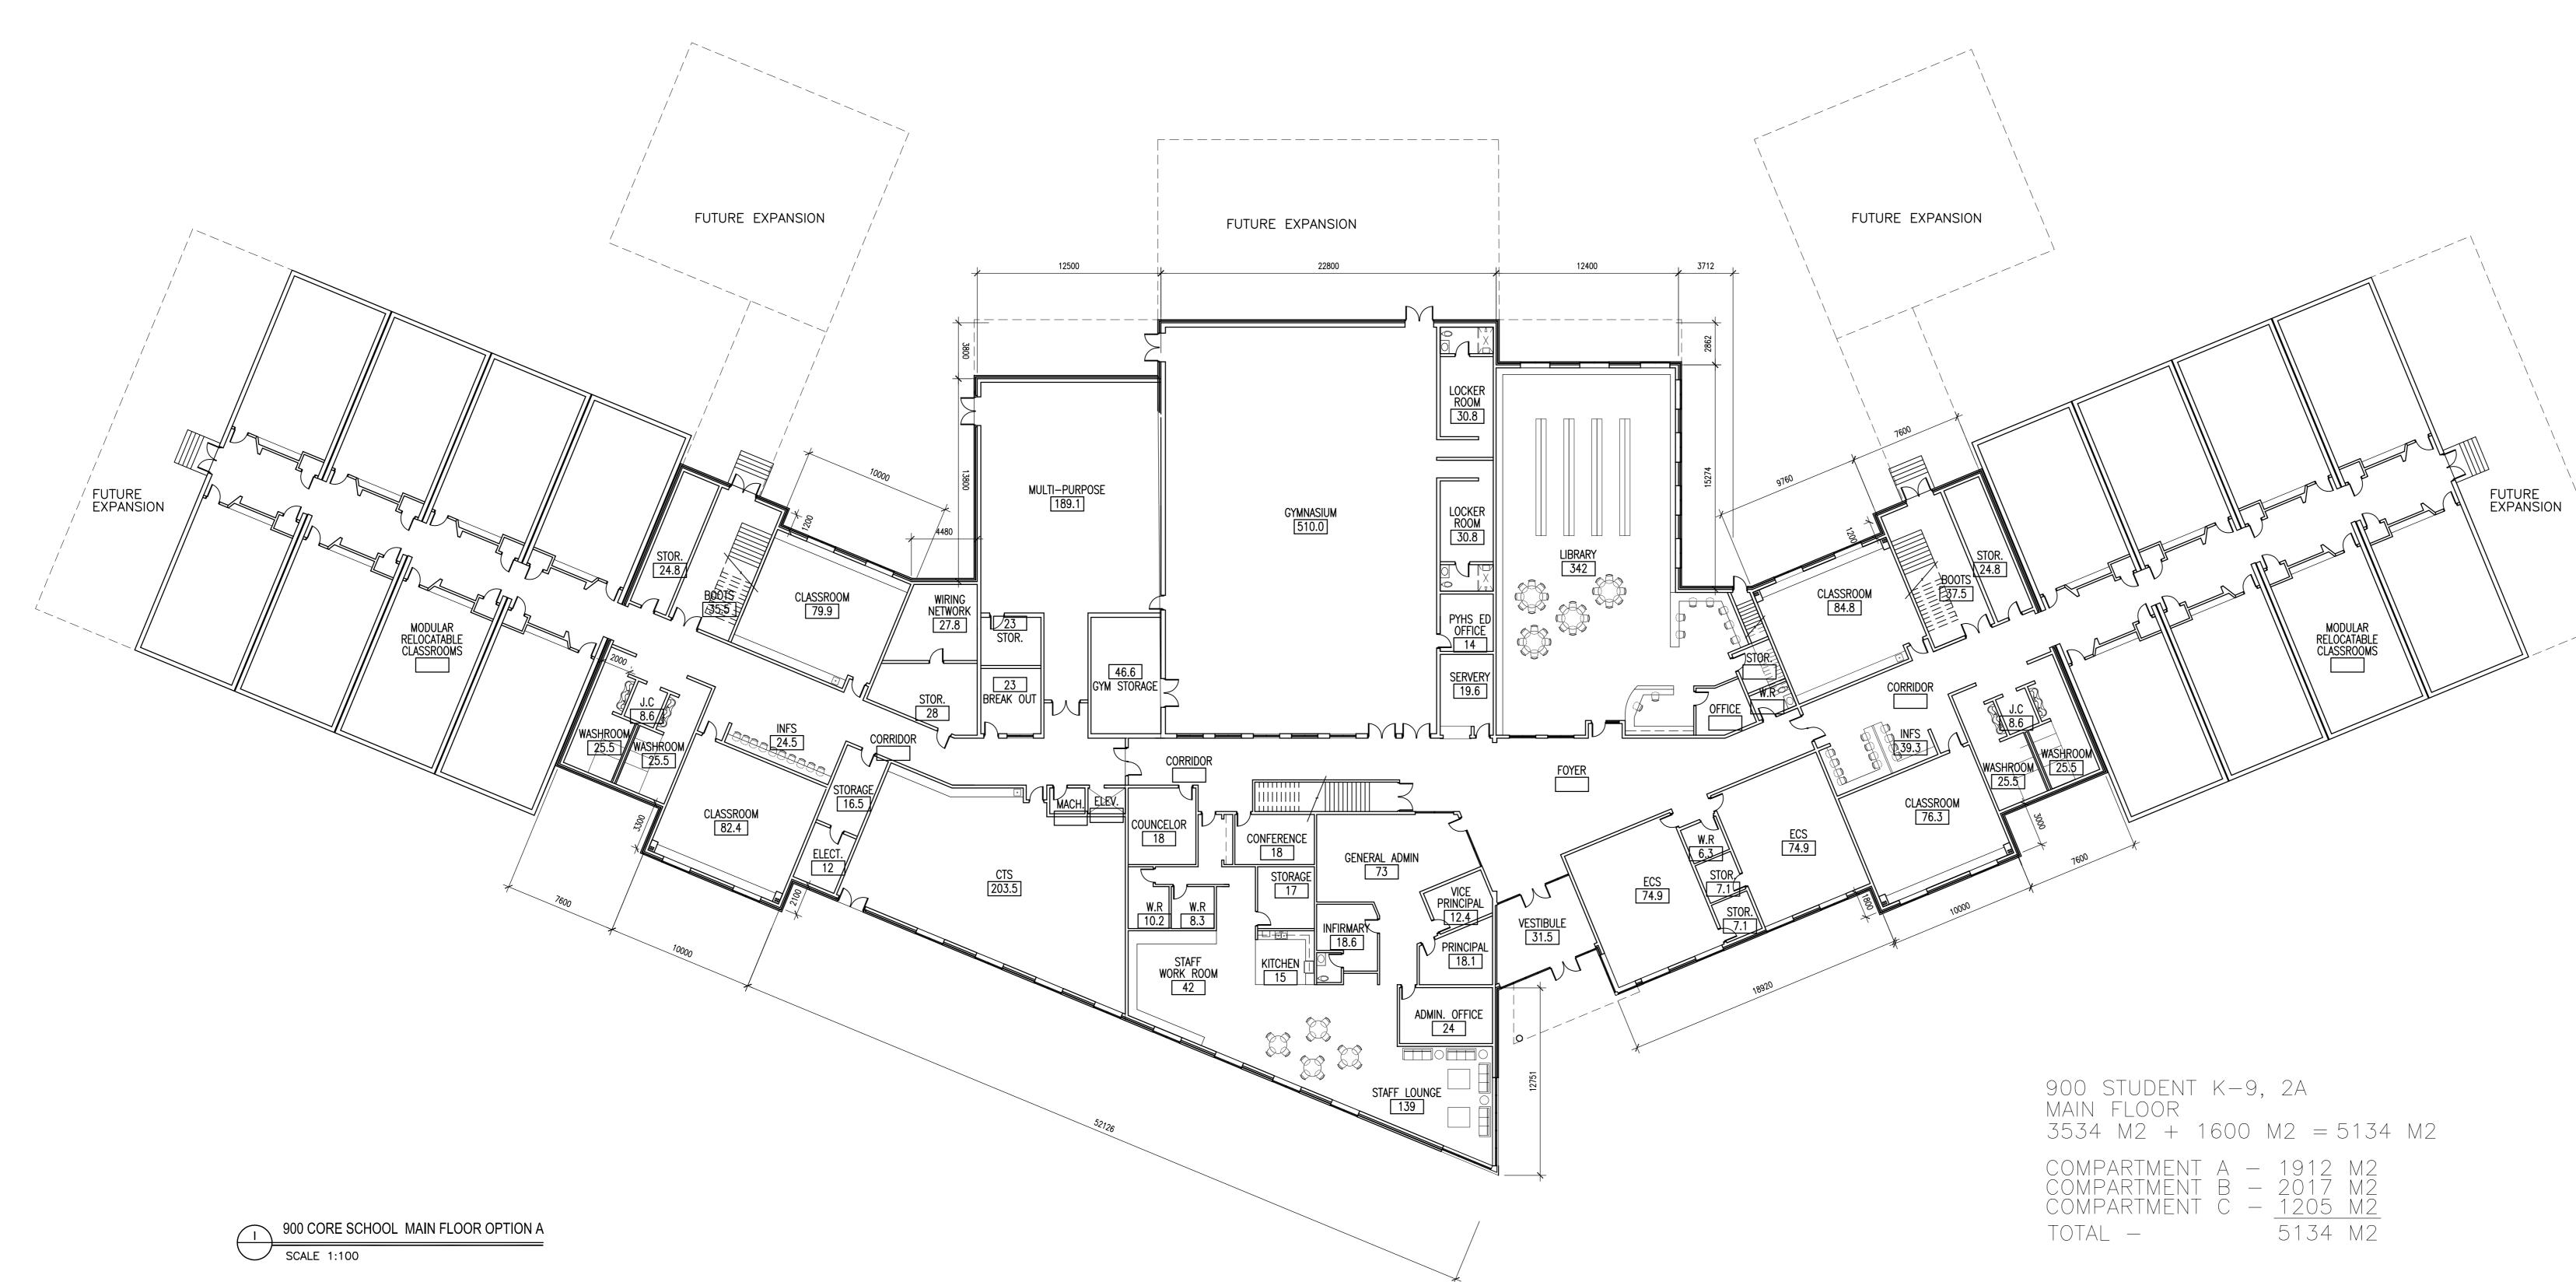

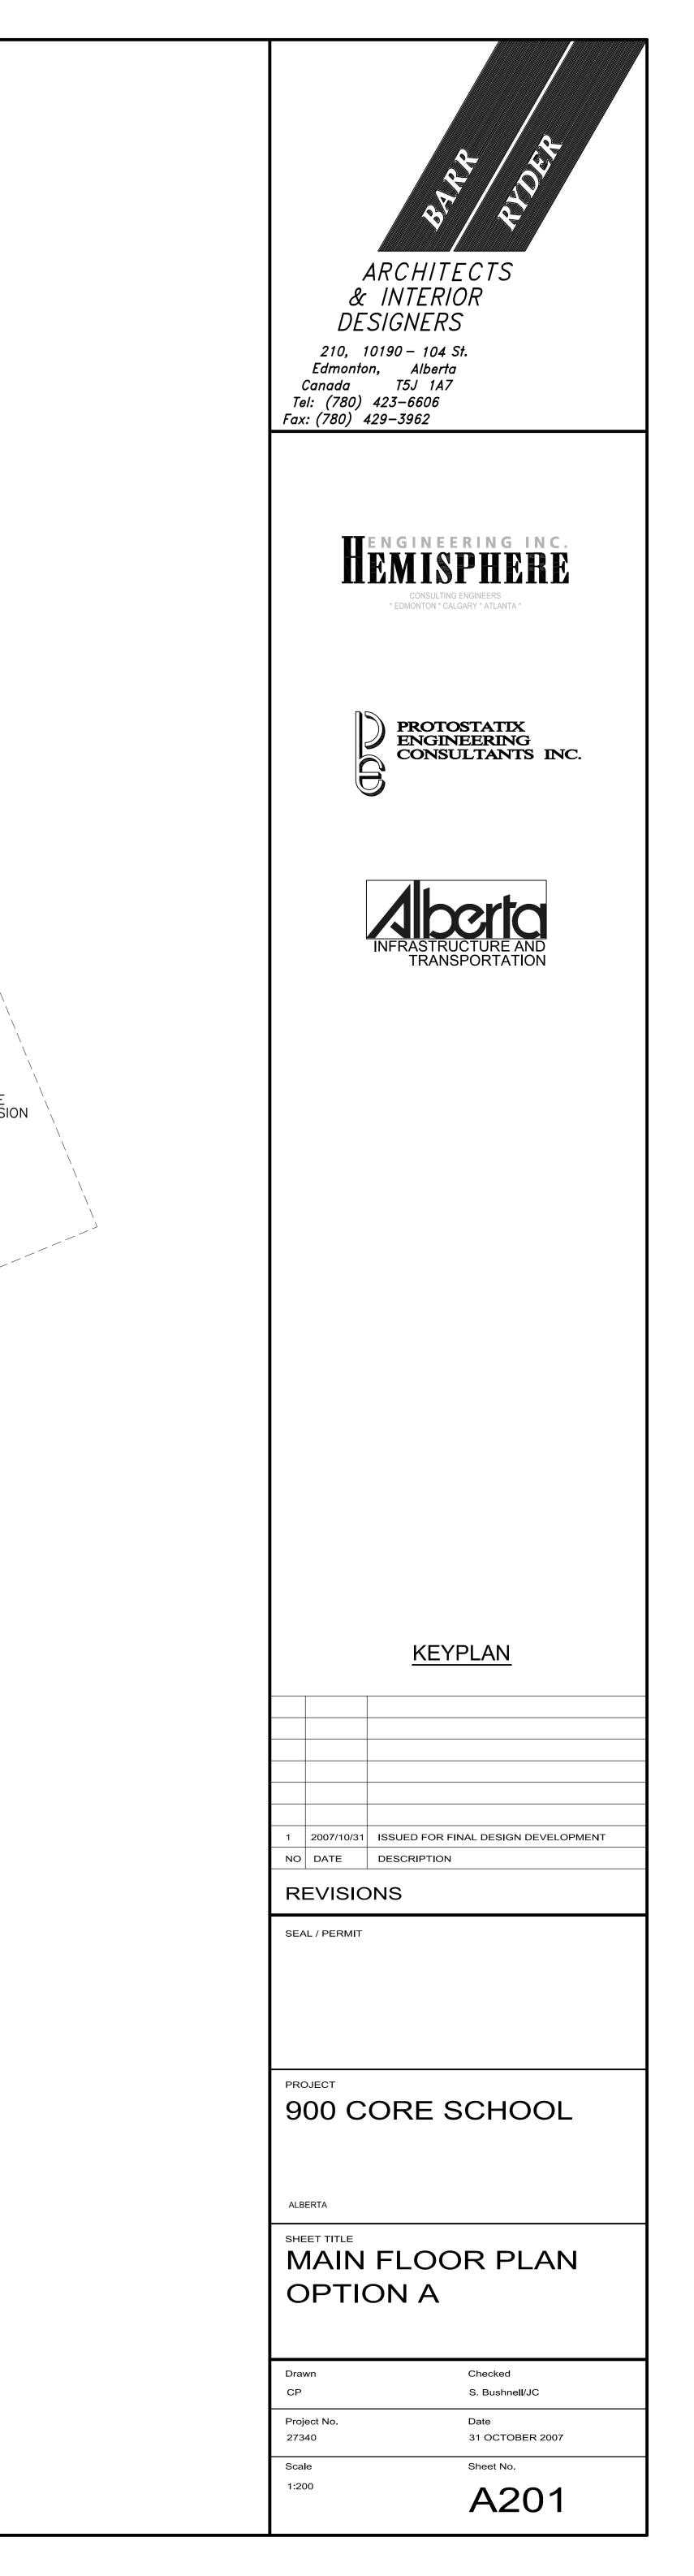


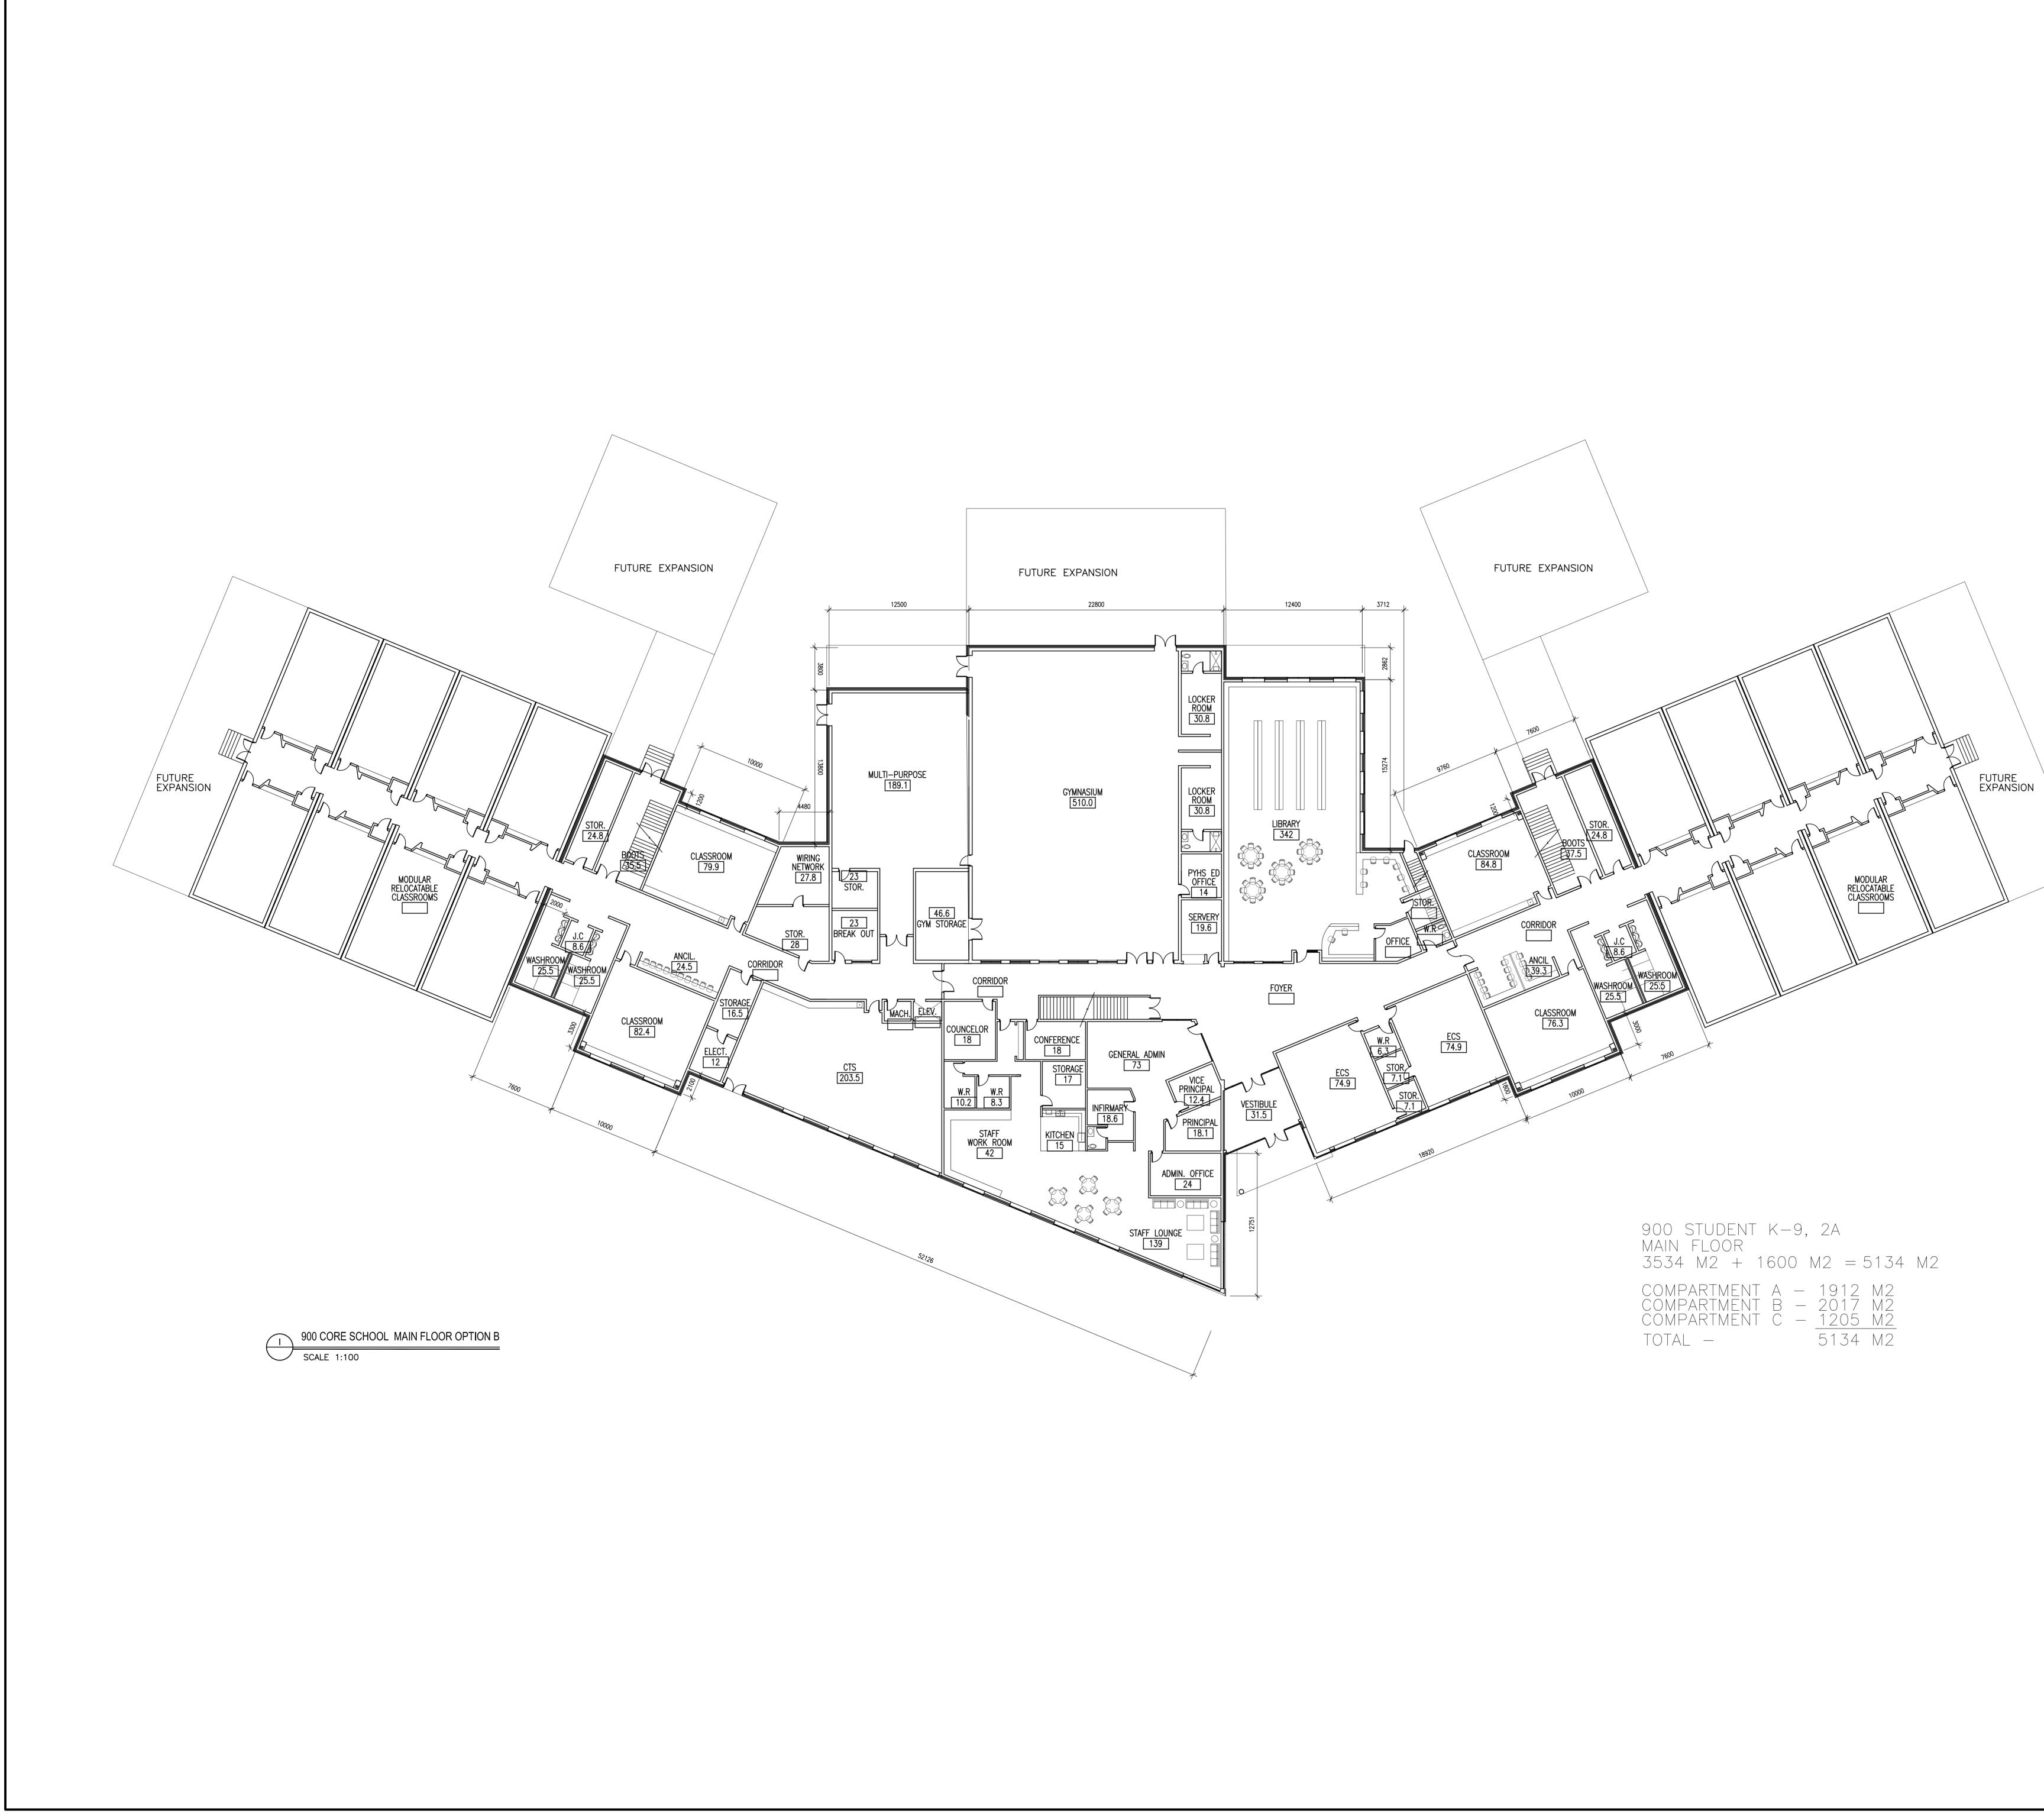

ARCHITECTS           & INTERIOR           DESIGNERS           210, 10190 - 104 St.           Edmonton, Alberta           Canada T5J 1A7           Tel: (780) 423-6606           Fax: (780) 429-3962
<b>EXAMPLE A CONSULTING ENGINEERS</b> * EDMONTON * CALGARY * ATLANTA *
PROTOSTATIX ENGINEERING CONSULTANTS INC.
<b>INFRASTRUCTURE AND</b> TRANSPORTATION
<u>KEYPLAN</u>
1     2007/10/31     ISSUED FOR FINAL DESIGN DEVELOPMENT
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PROJECT 900 CORE SCHOOL
JUU CORE SCHOUL
ALBERTA SHEET TITLE
MAIN FLOOR PLAN OPTION B
Drawn Checked CP S. Bushnell/JC
Project No.Date2734031 OCTOBER 2007ScaleSheet No.
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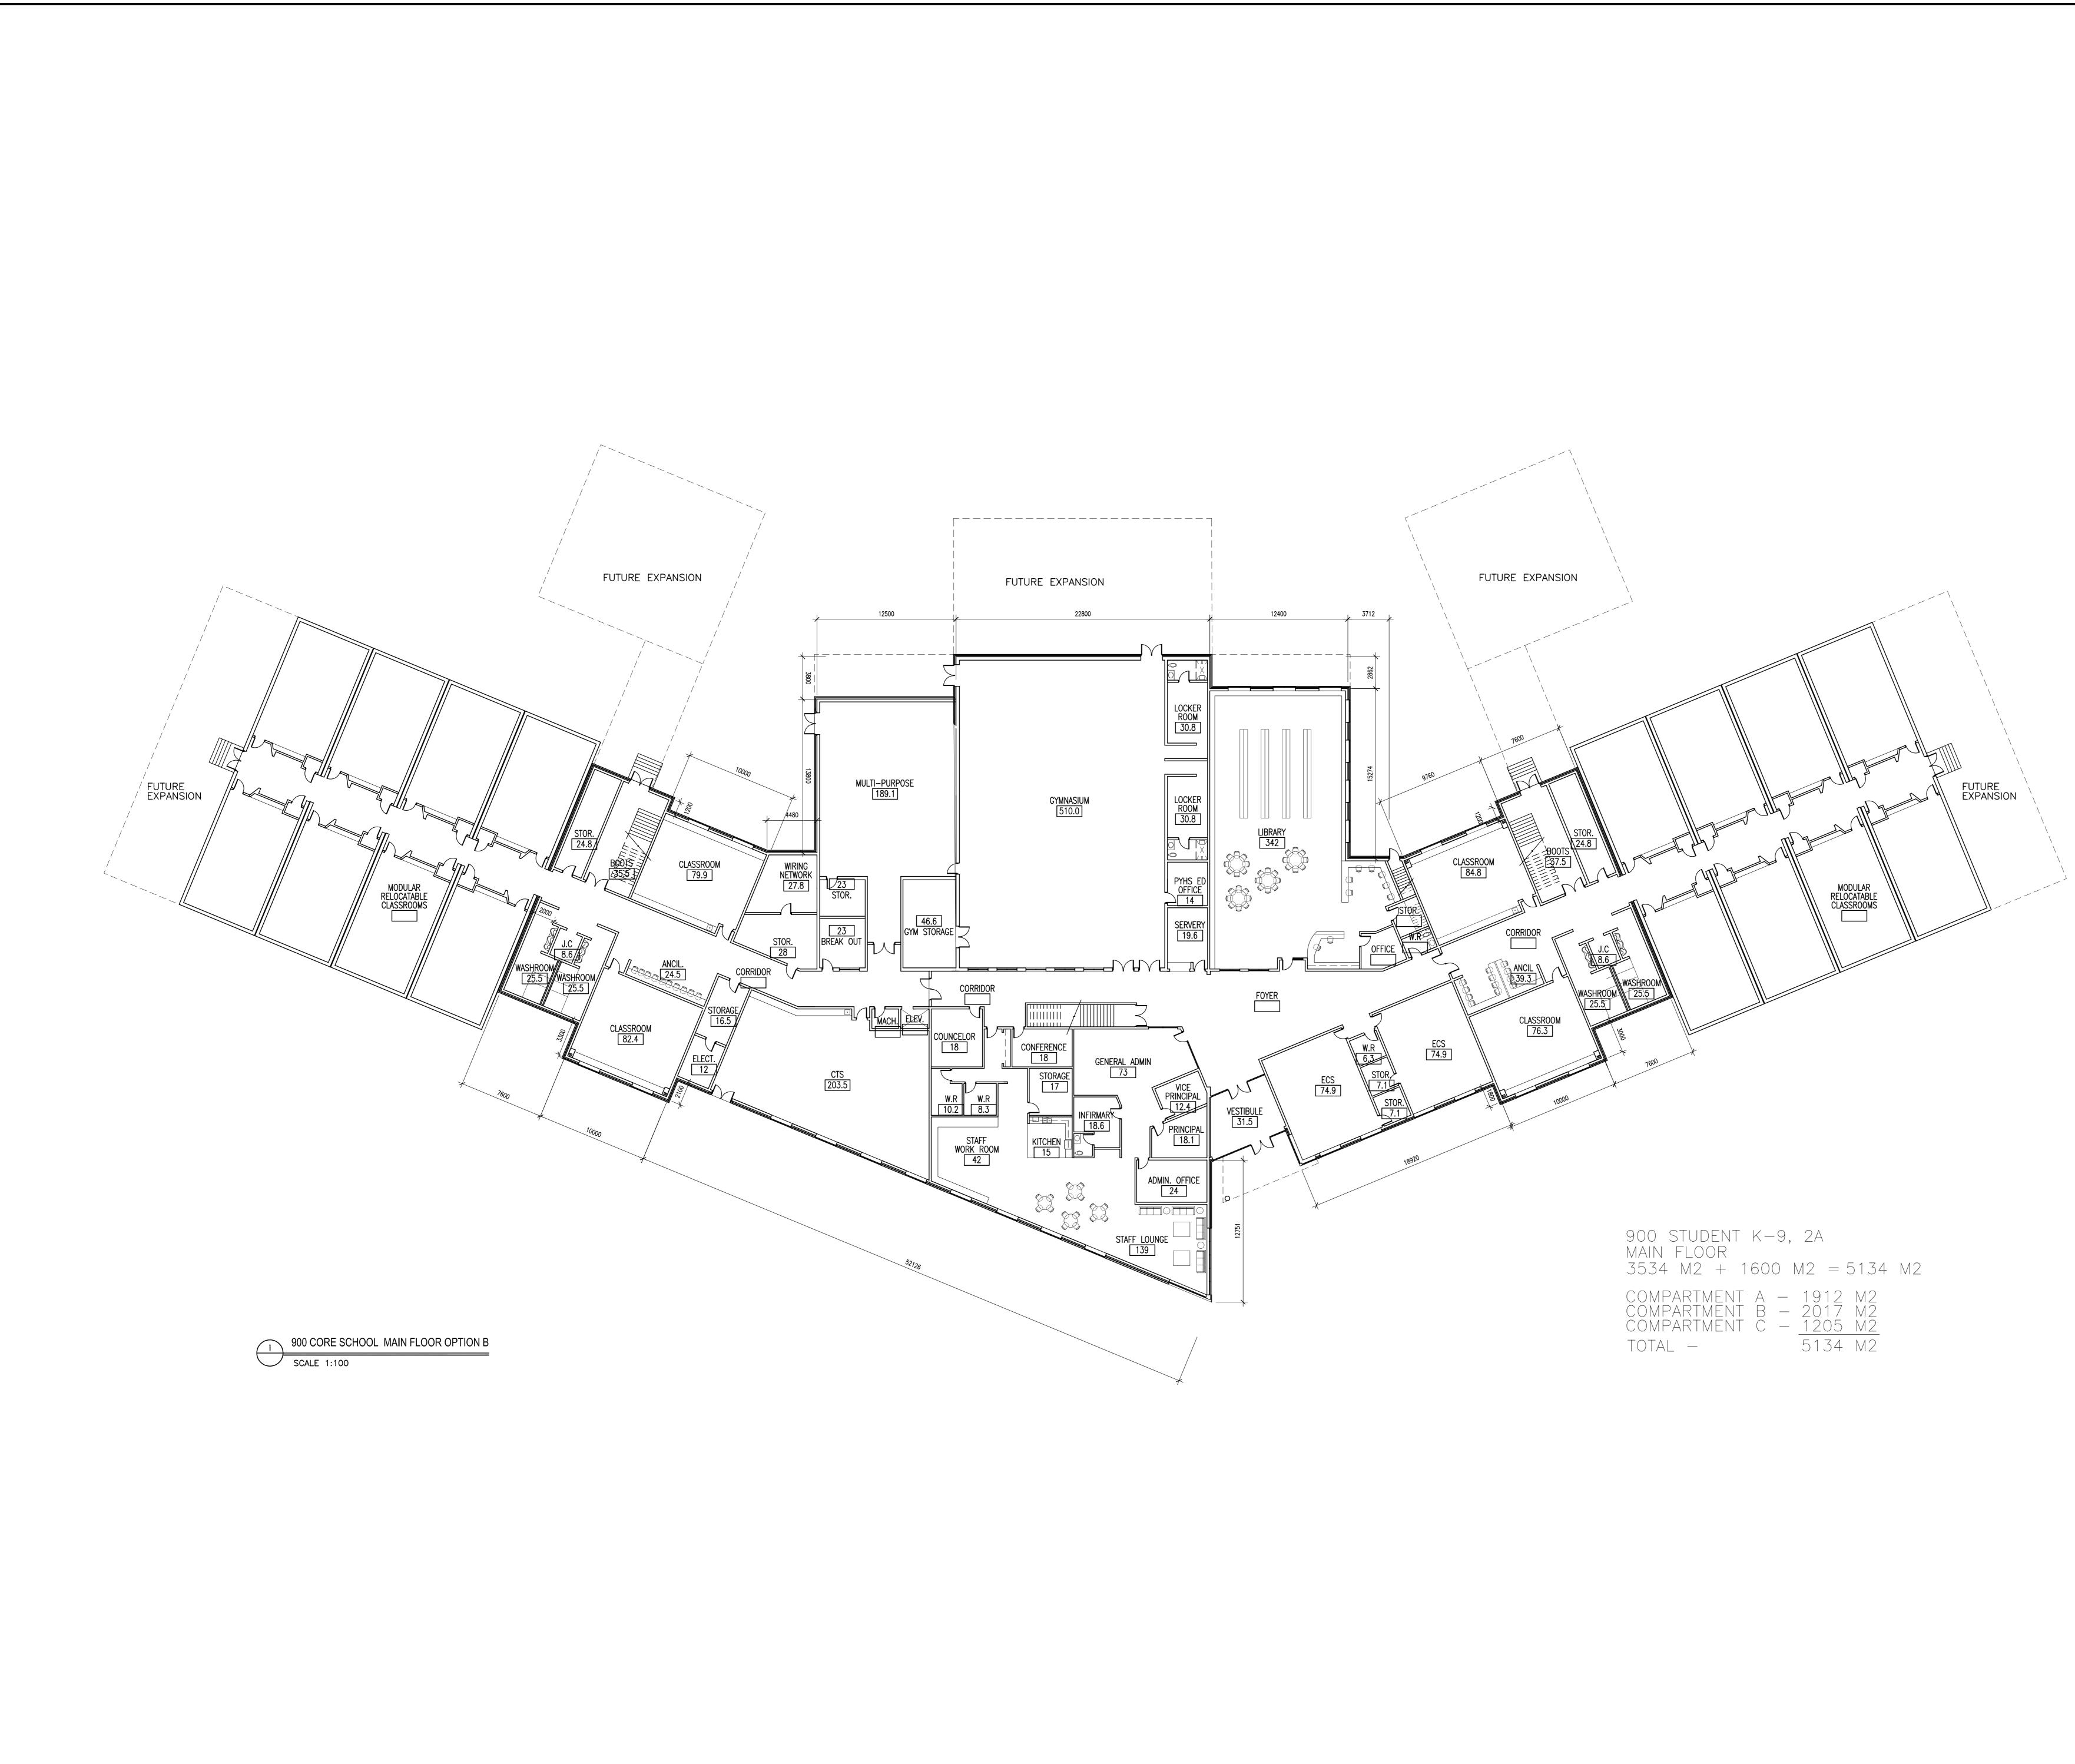


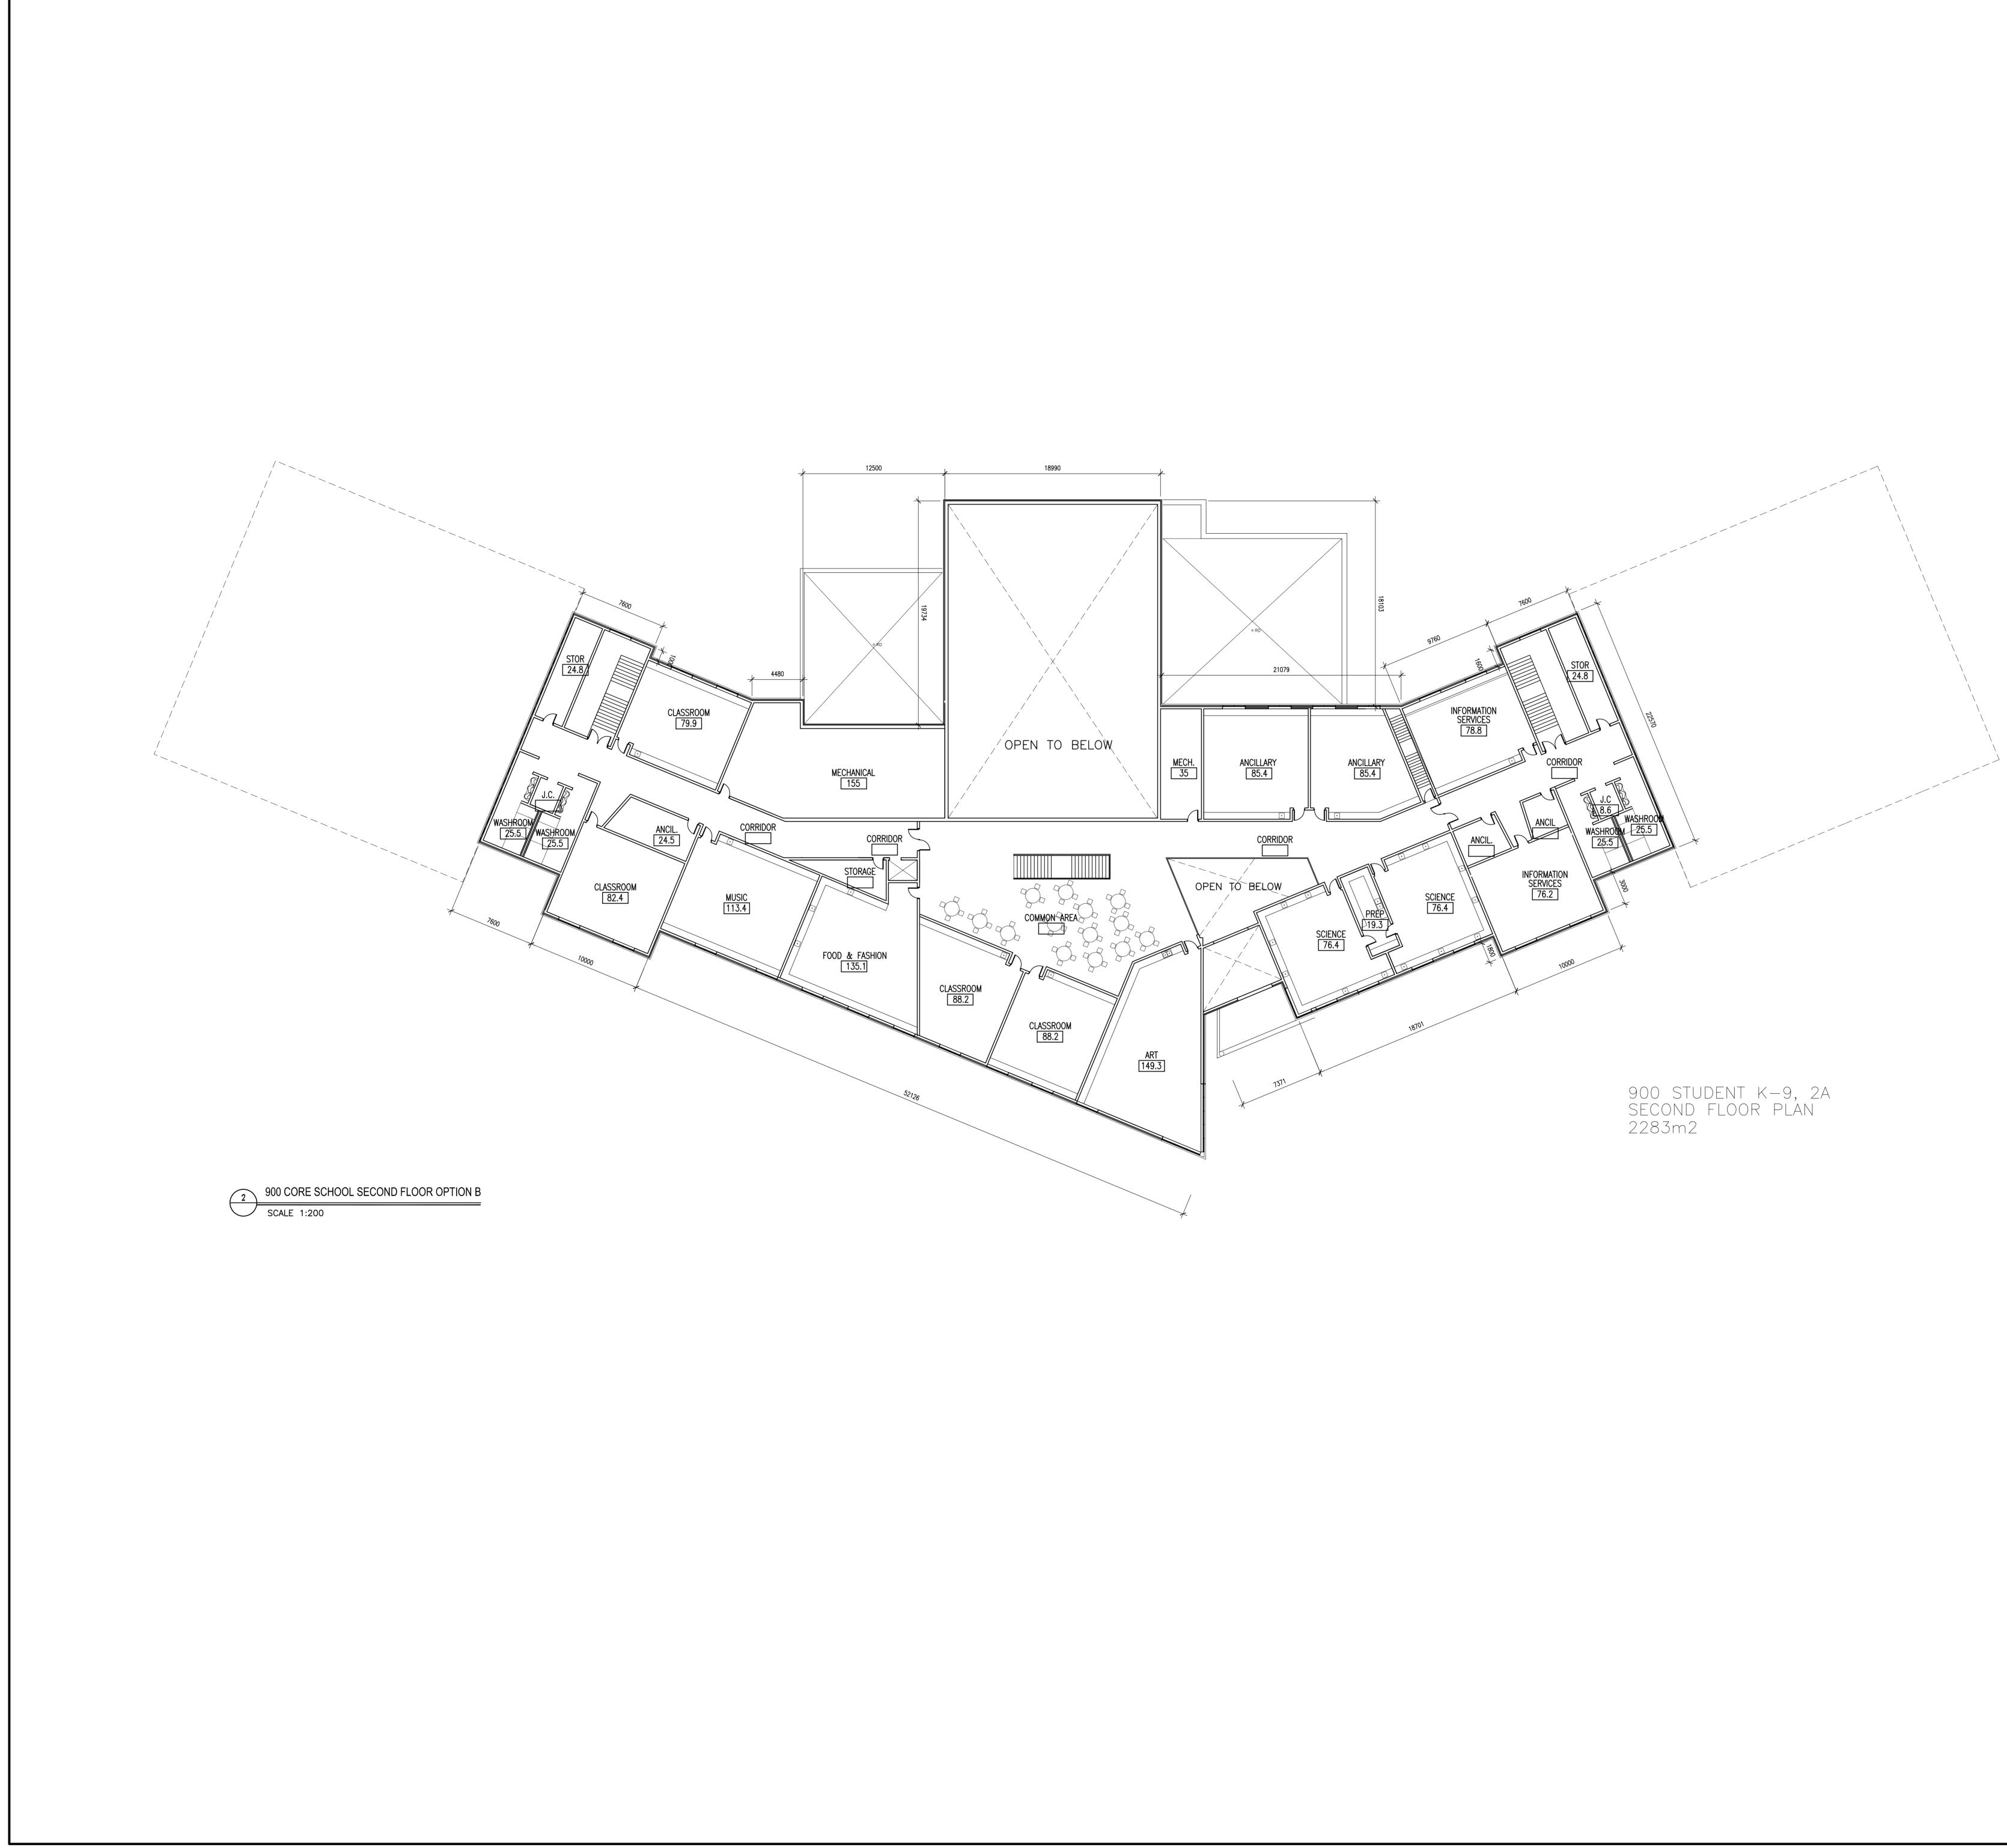
ARCHITECTS
& INTERIOR DESIGNERS 210, 10190 – 104 st.
Edmonton, Alberta Canada T5J 1A7 Tel: (780) 423–6606 Fax: (780) 429–3962
<b>EXAMPLE A CONSULTING ENGINEERS</b> * EDMONTON * CALGARY * ATLANTA *
PROTOSTATIX
ENGINEERING CONSULTANTS INC.
<b>ABCCTOR</b> INFRASTRUCTURE AND TRANSPORTATION
<u>KEYPLAN</u>
1     2007/10/31     ISSUED FOR FINAL DESIGN DEVELOPMENT       NO     DATE     DESCRIPTION
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PROJECT 900 CORE SCHOOL
ALBERTA
SHEET TITLE SECOND FLOOR PLAN OPTION B
Drawn Checked CP S. Bushnell/JC
Project No.Date2734031 OCTOBER 2007ScaleSheet No.
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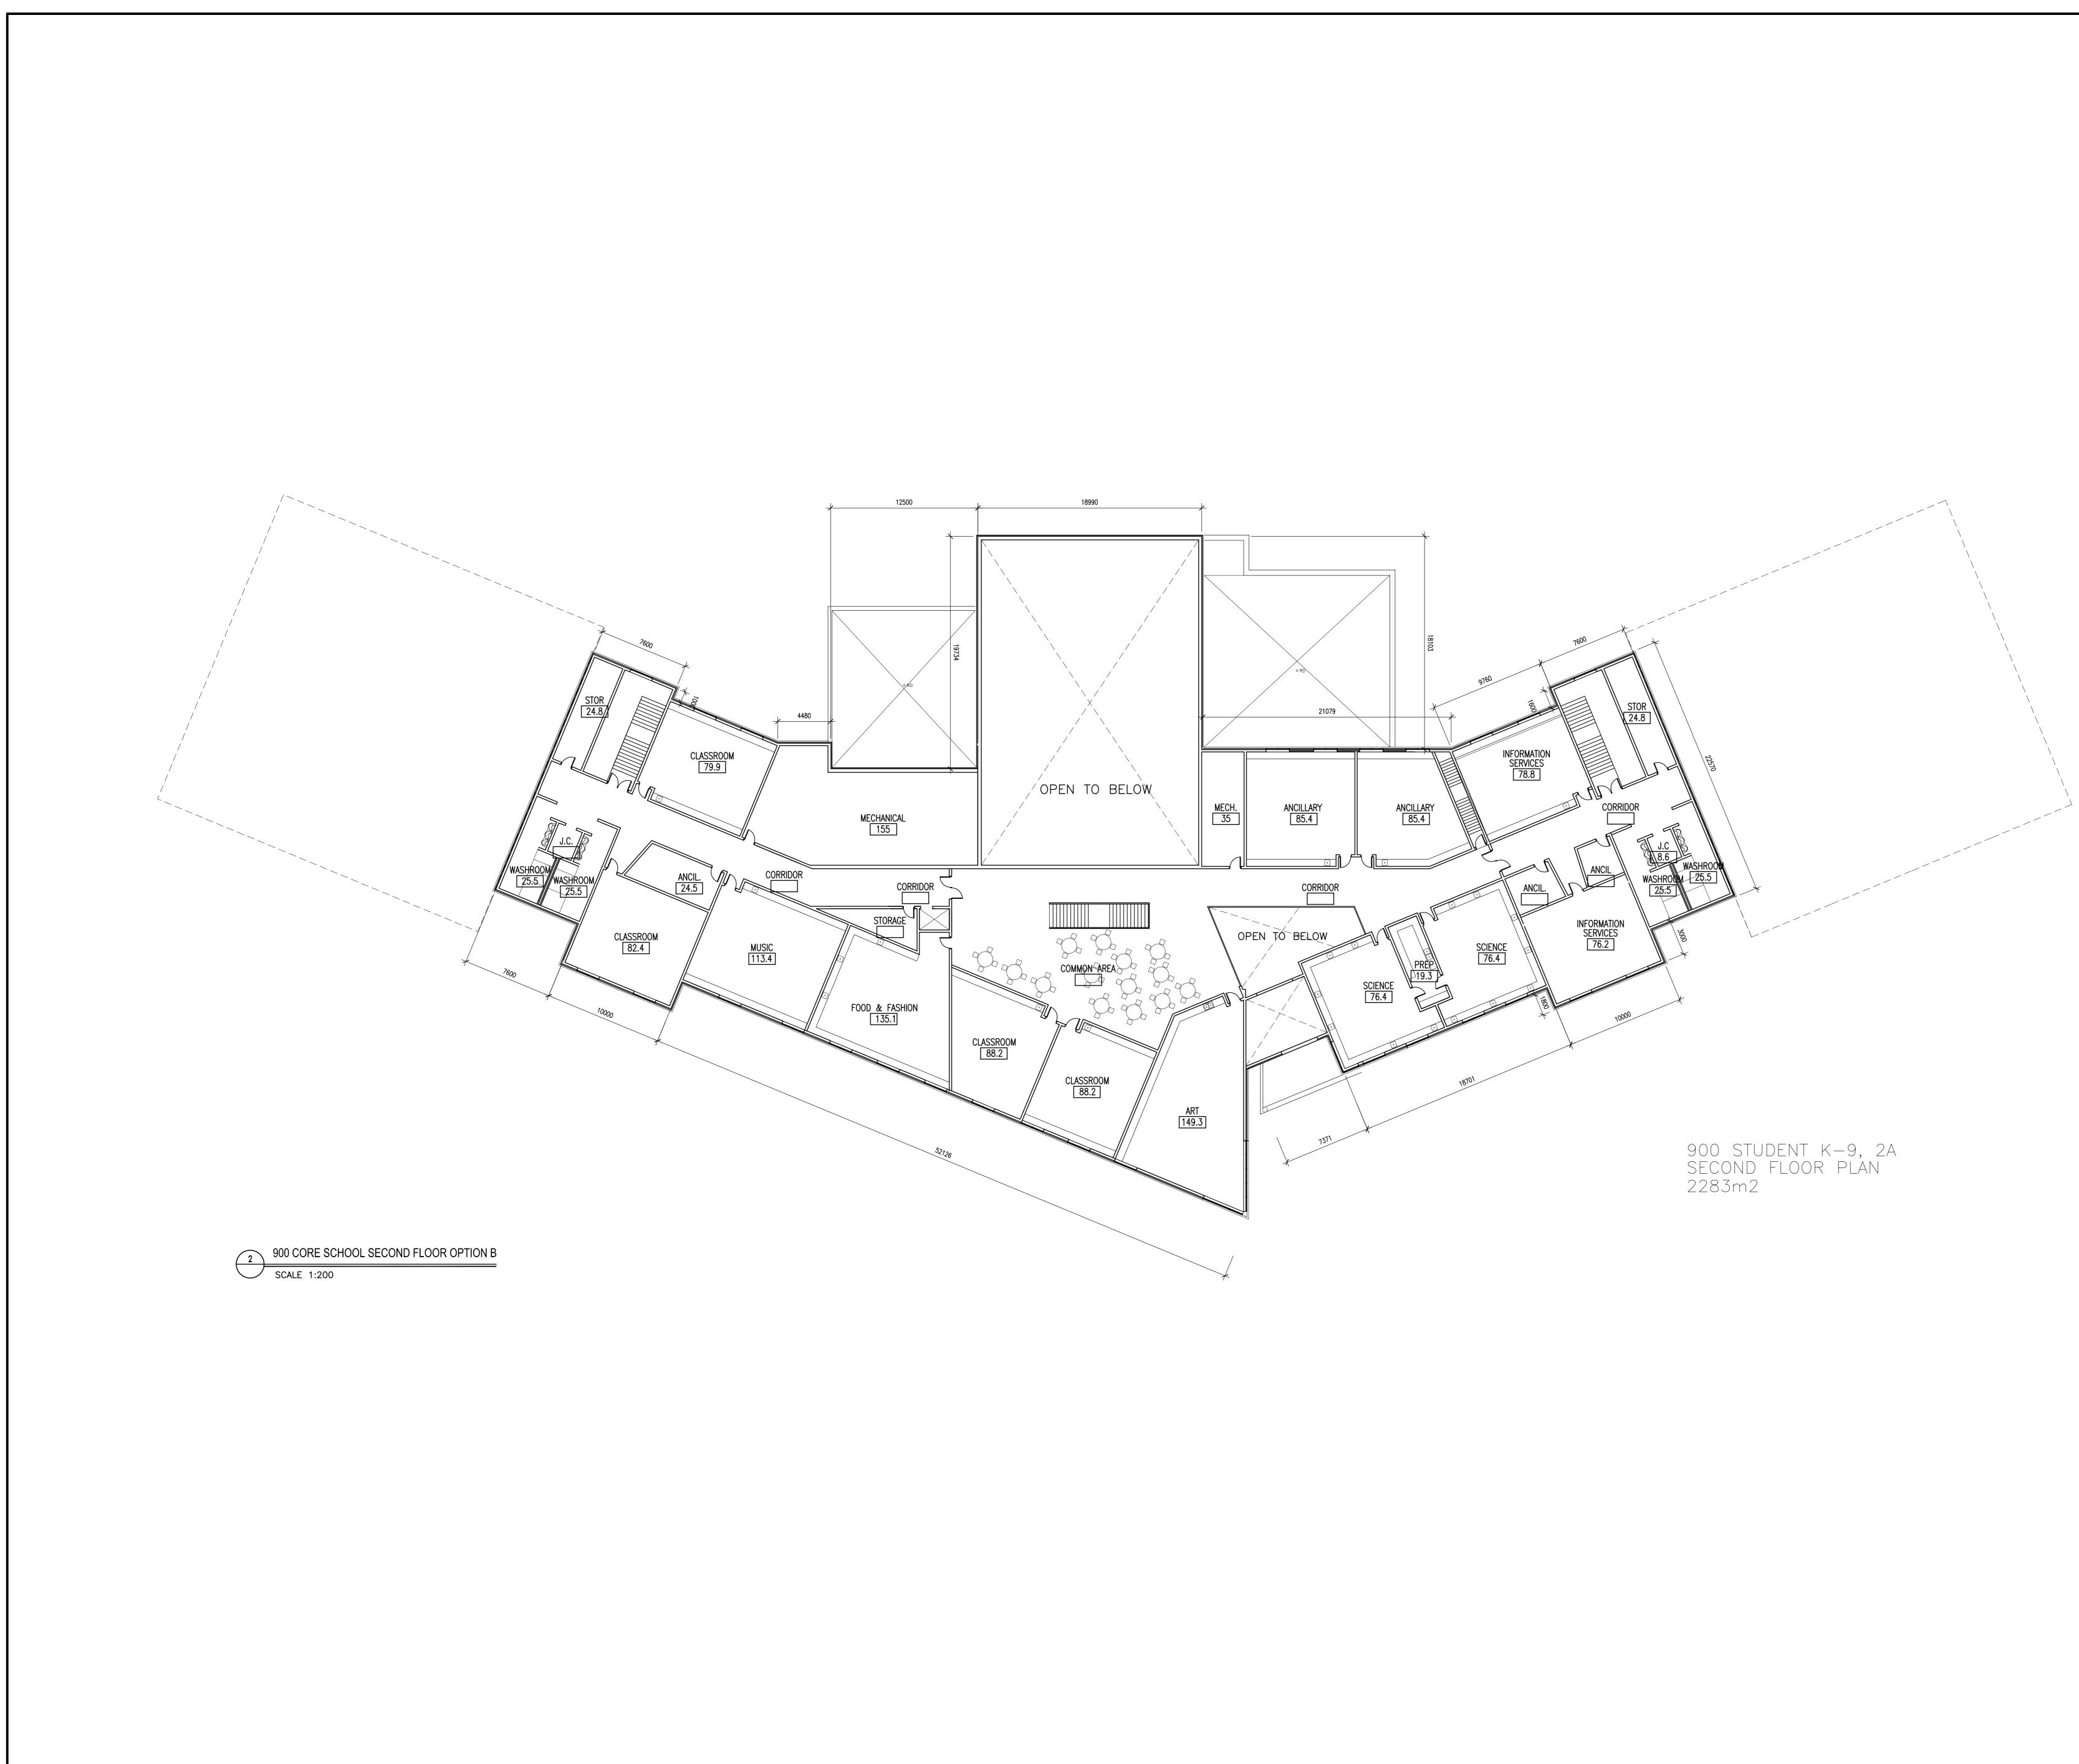



2 900 CORE SCHOOL SECOND FLOOR OPTION A SCALE 1:200

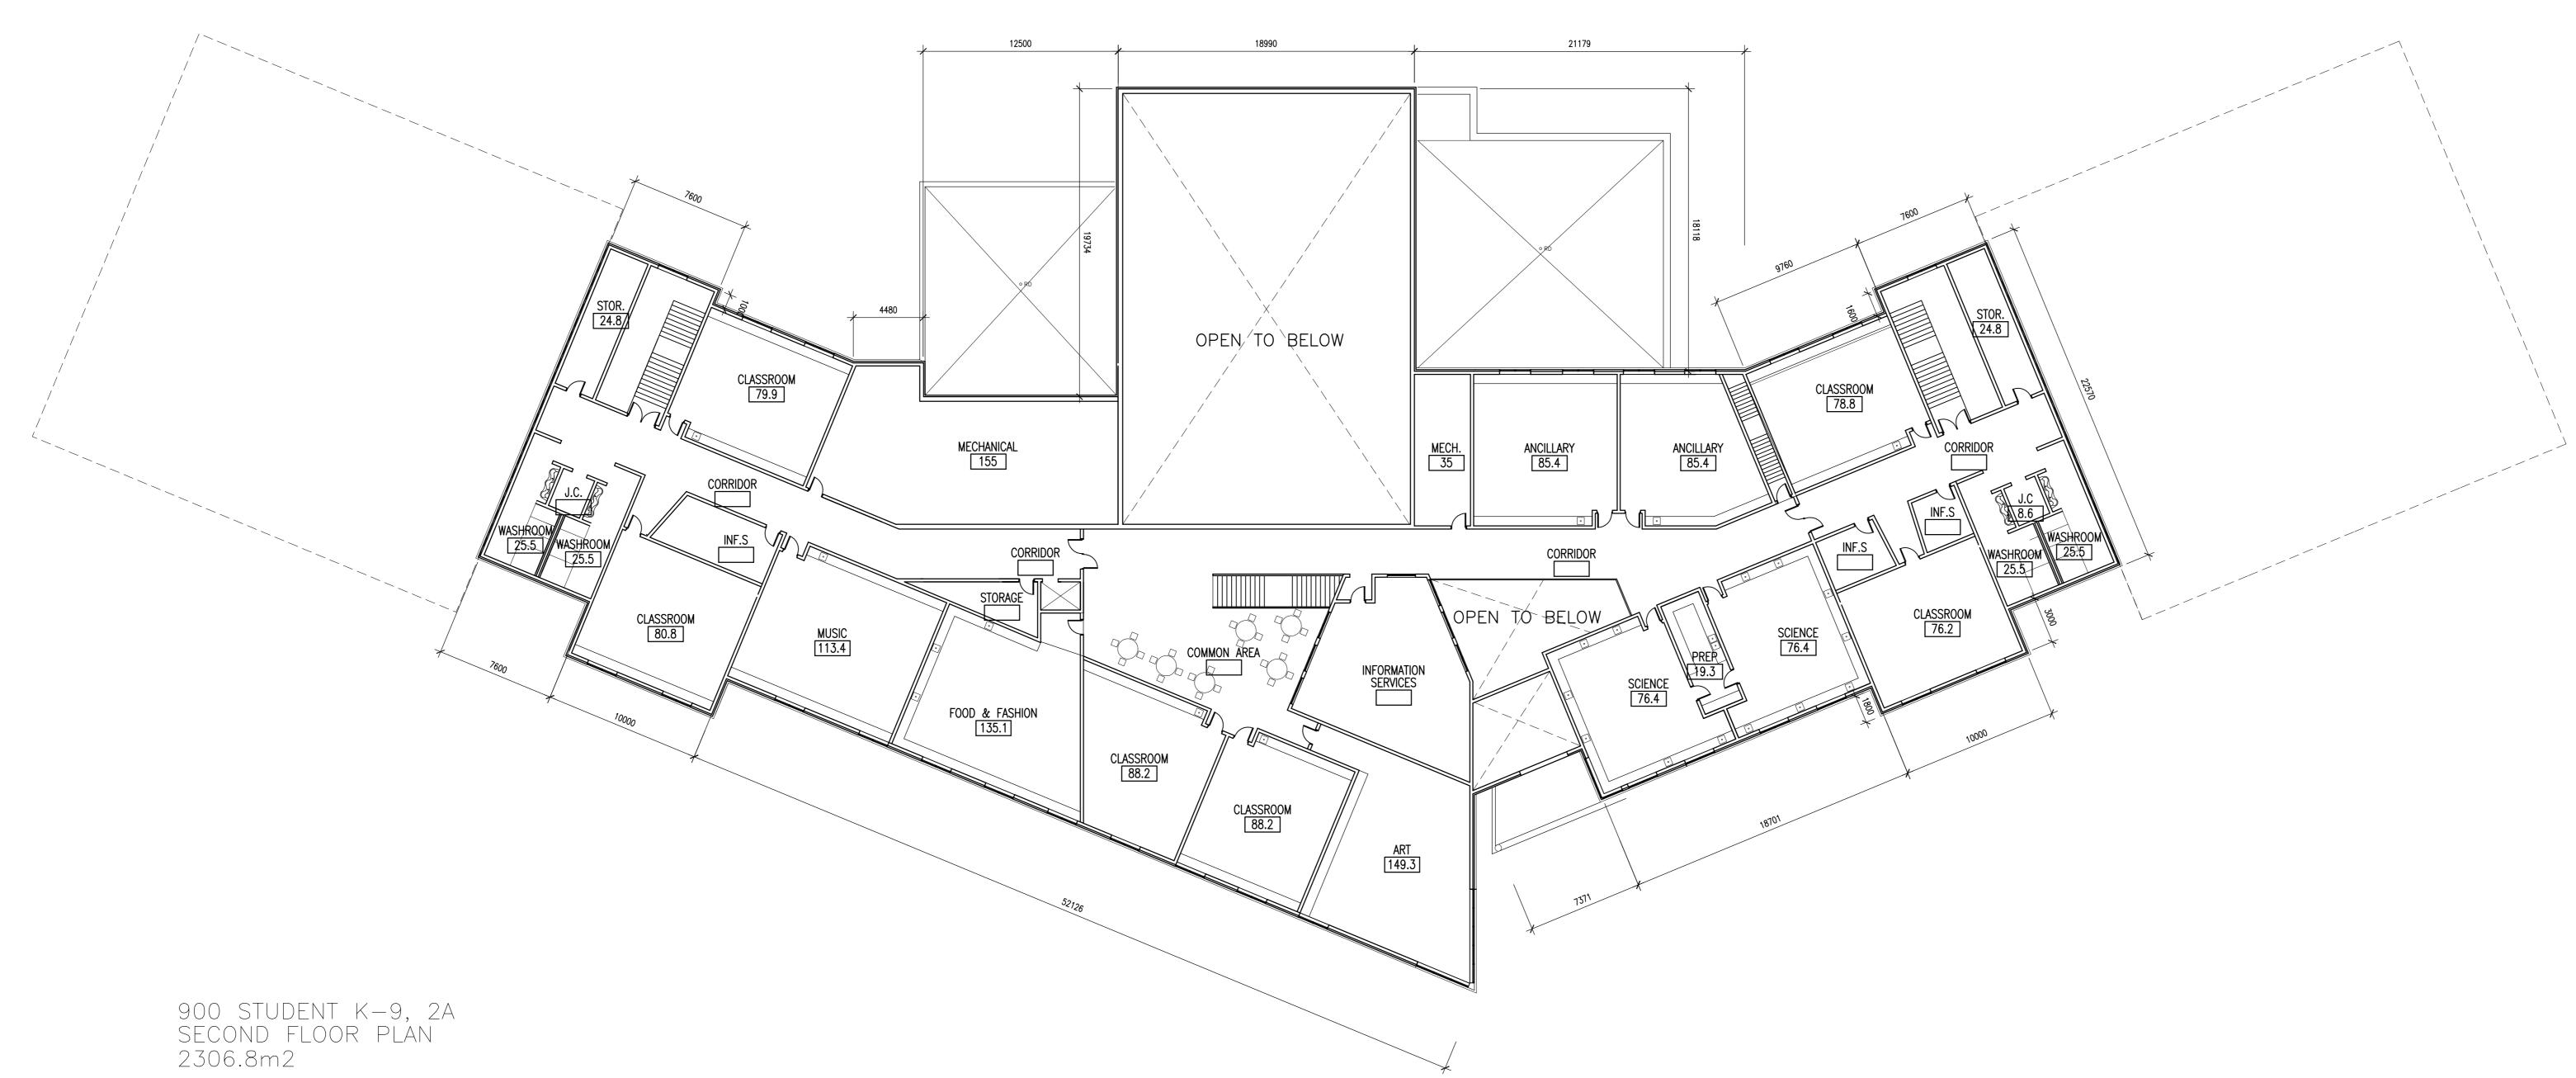
ARCHITECTS & INTERIOR DESIGNERS 210, 10190 – 104 St. Edmonton, Alberta Canada T5J 1A7 Tel: (780) 423–6606 Fax: (780) 429–3962
<b>TENGINEERING INC.</b> <b>DESCRIPTION</b> CONSULTING ENGINEERS * EDMONTON * CALGARY * ATLANTA *
PROTOSTATIX ENGINEERING CONSULTANTS INC.
<b>INFRASTRUCTURE AND</b> TRANSPORTATION
<u>KEYPLAN</u>
1 2007/10/31 ISSUED FOR FINAL DESIGN DEVELOPMENT
1     2007/10/31     Issued for final design development       NO     Date     Description       REVISIONS
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PROJECT 900 CORE SCHOOL
ALBERTA SHEET TITLE SECOND FLOOR PLAN OPTION A
Drawn Checked CP S. Bushnell/JC
Project No.Date2734031 OCTOBER 2007ScaleSheet No.
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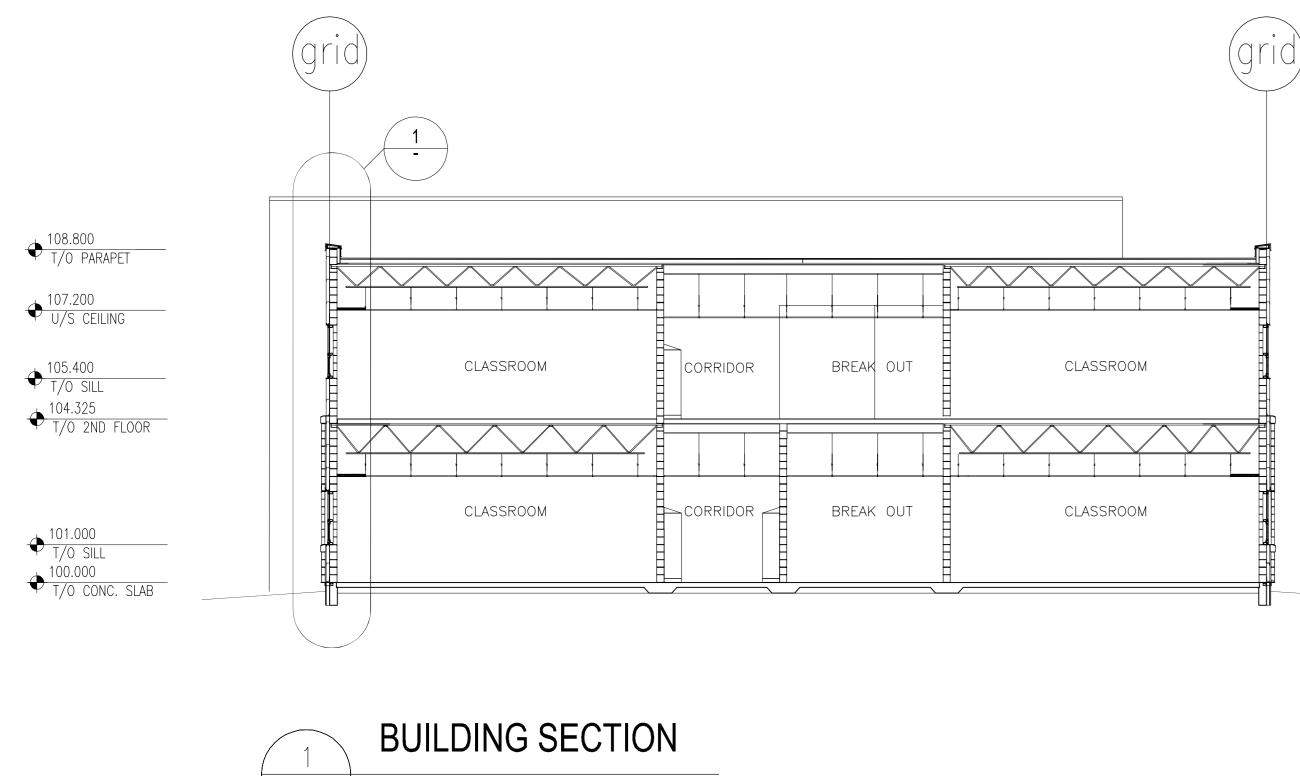





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ARCHITECTS & INTERIOR DESIGNERS 210, 10190 - 104 St. Edmonton, Alberta Canada T5J 1A7 Tel: (780) 423-6606 Fax: (780) 429-3962
Image:
PROJECT 900 CORE SCHOOL ADDRESS SHEET TITLE BUILDING ELEVATIONS
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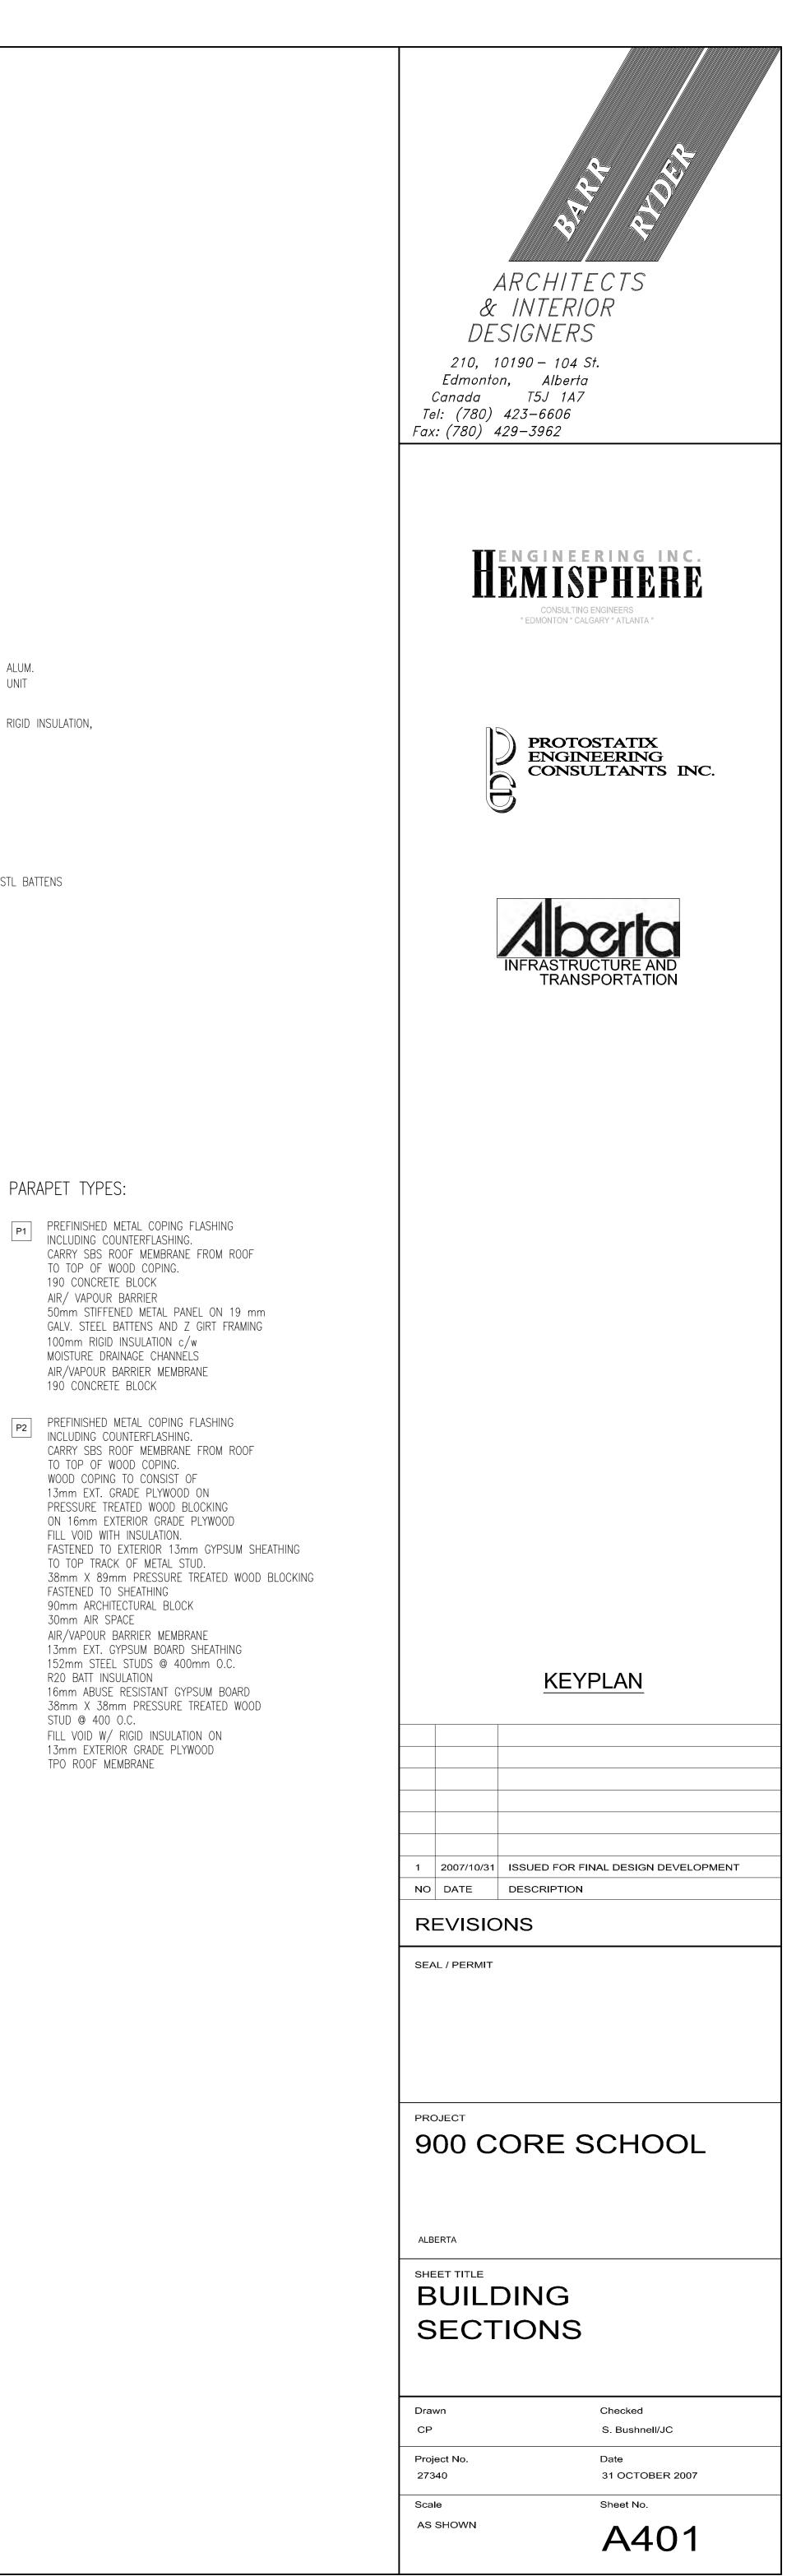


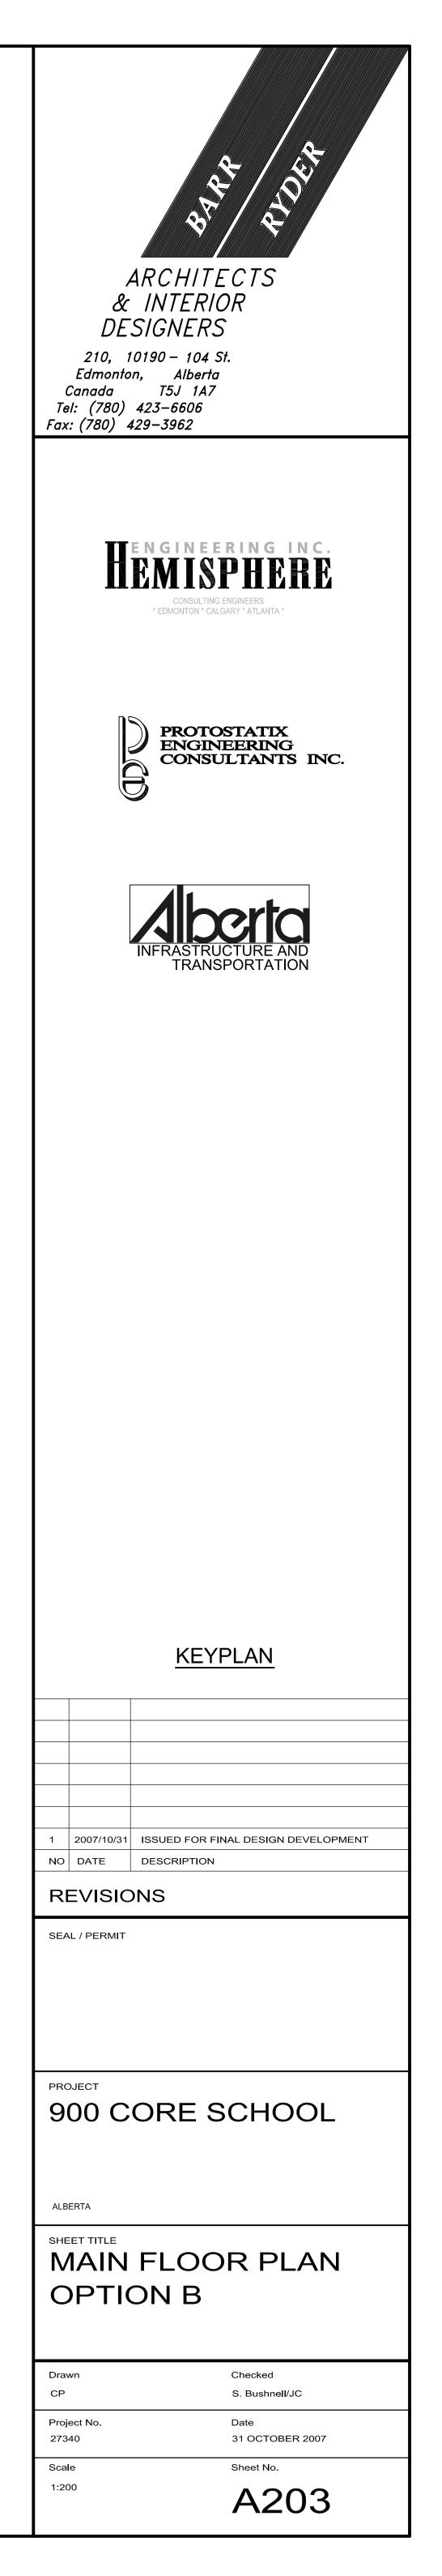


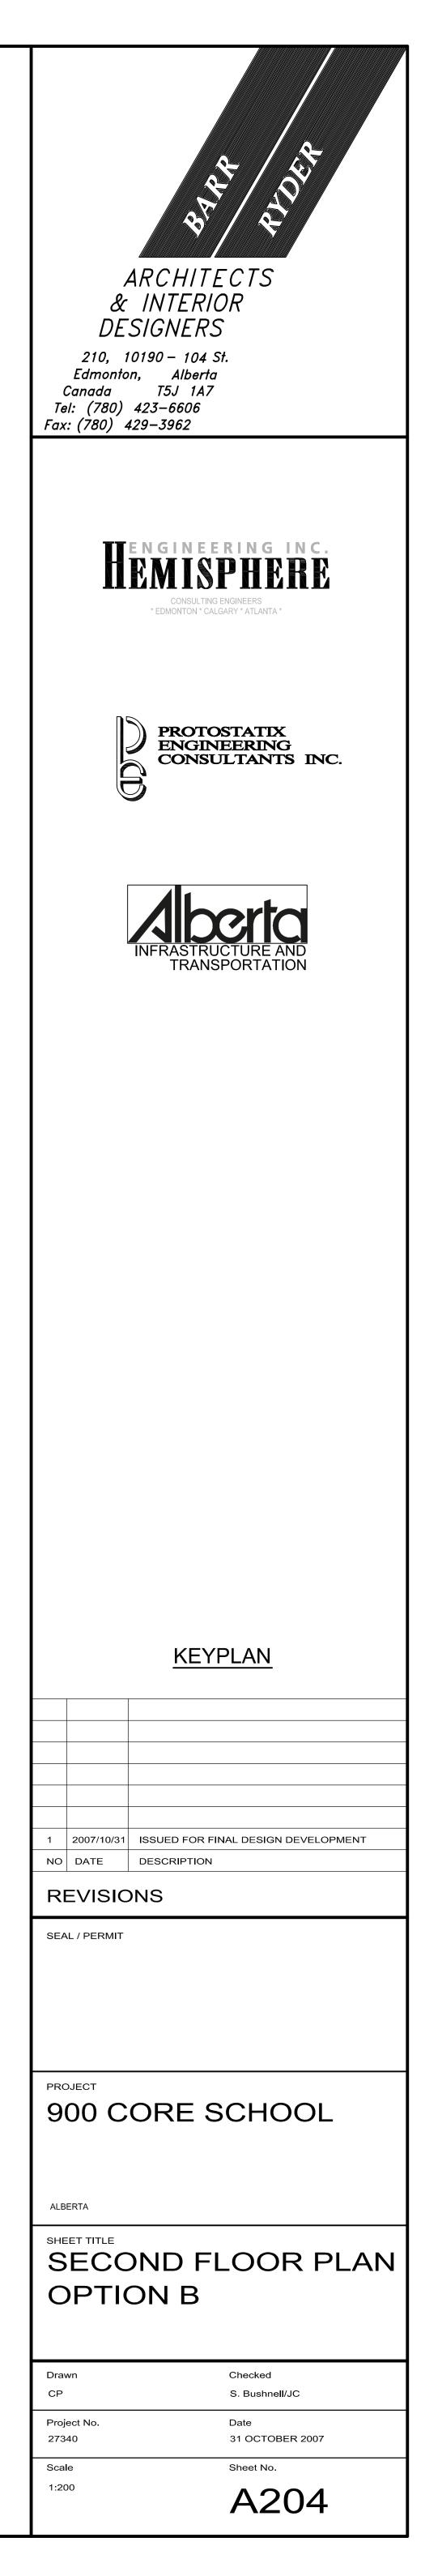- DOUBLE GLAZED THERMALLY BROKEN CLEAR ANOD. ALUM. CURTAINWALL FRAME WINDOW W/OPERABLE AWNING UNIT
- 16mm CEMENT BOARD ON 50mm Z-BARS, 50mm RIGID INSULATION,
- 50mm STIFFENED METAL PANEL ON 19mm GALV. STL BATTENS
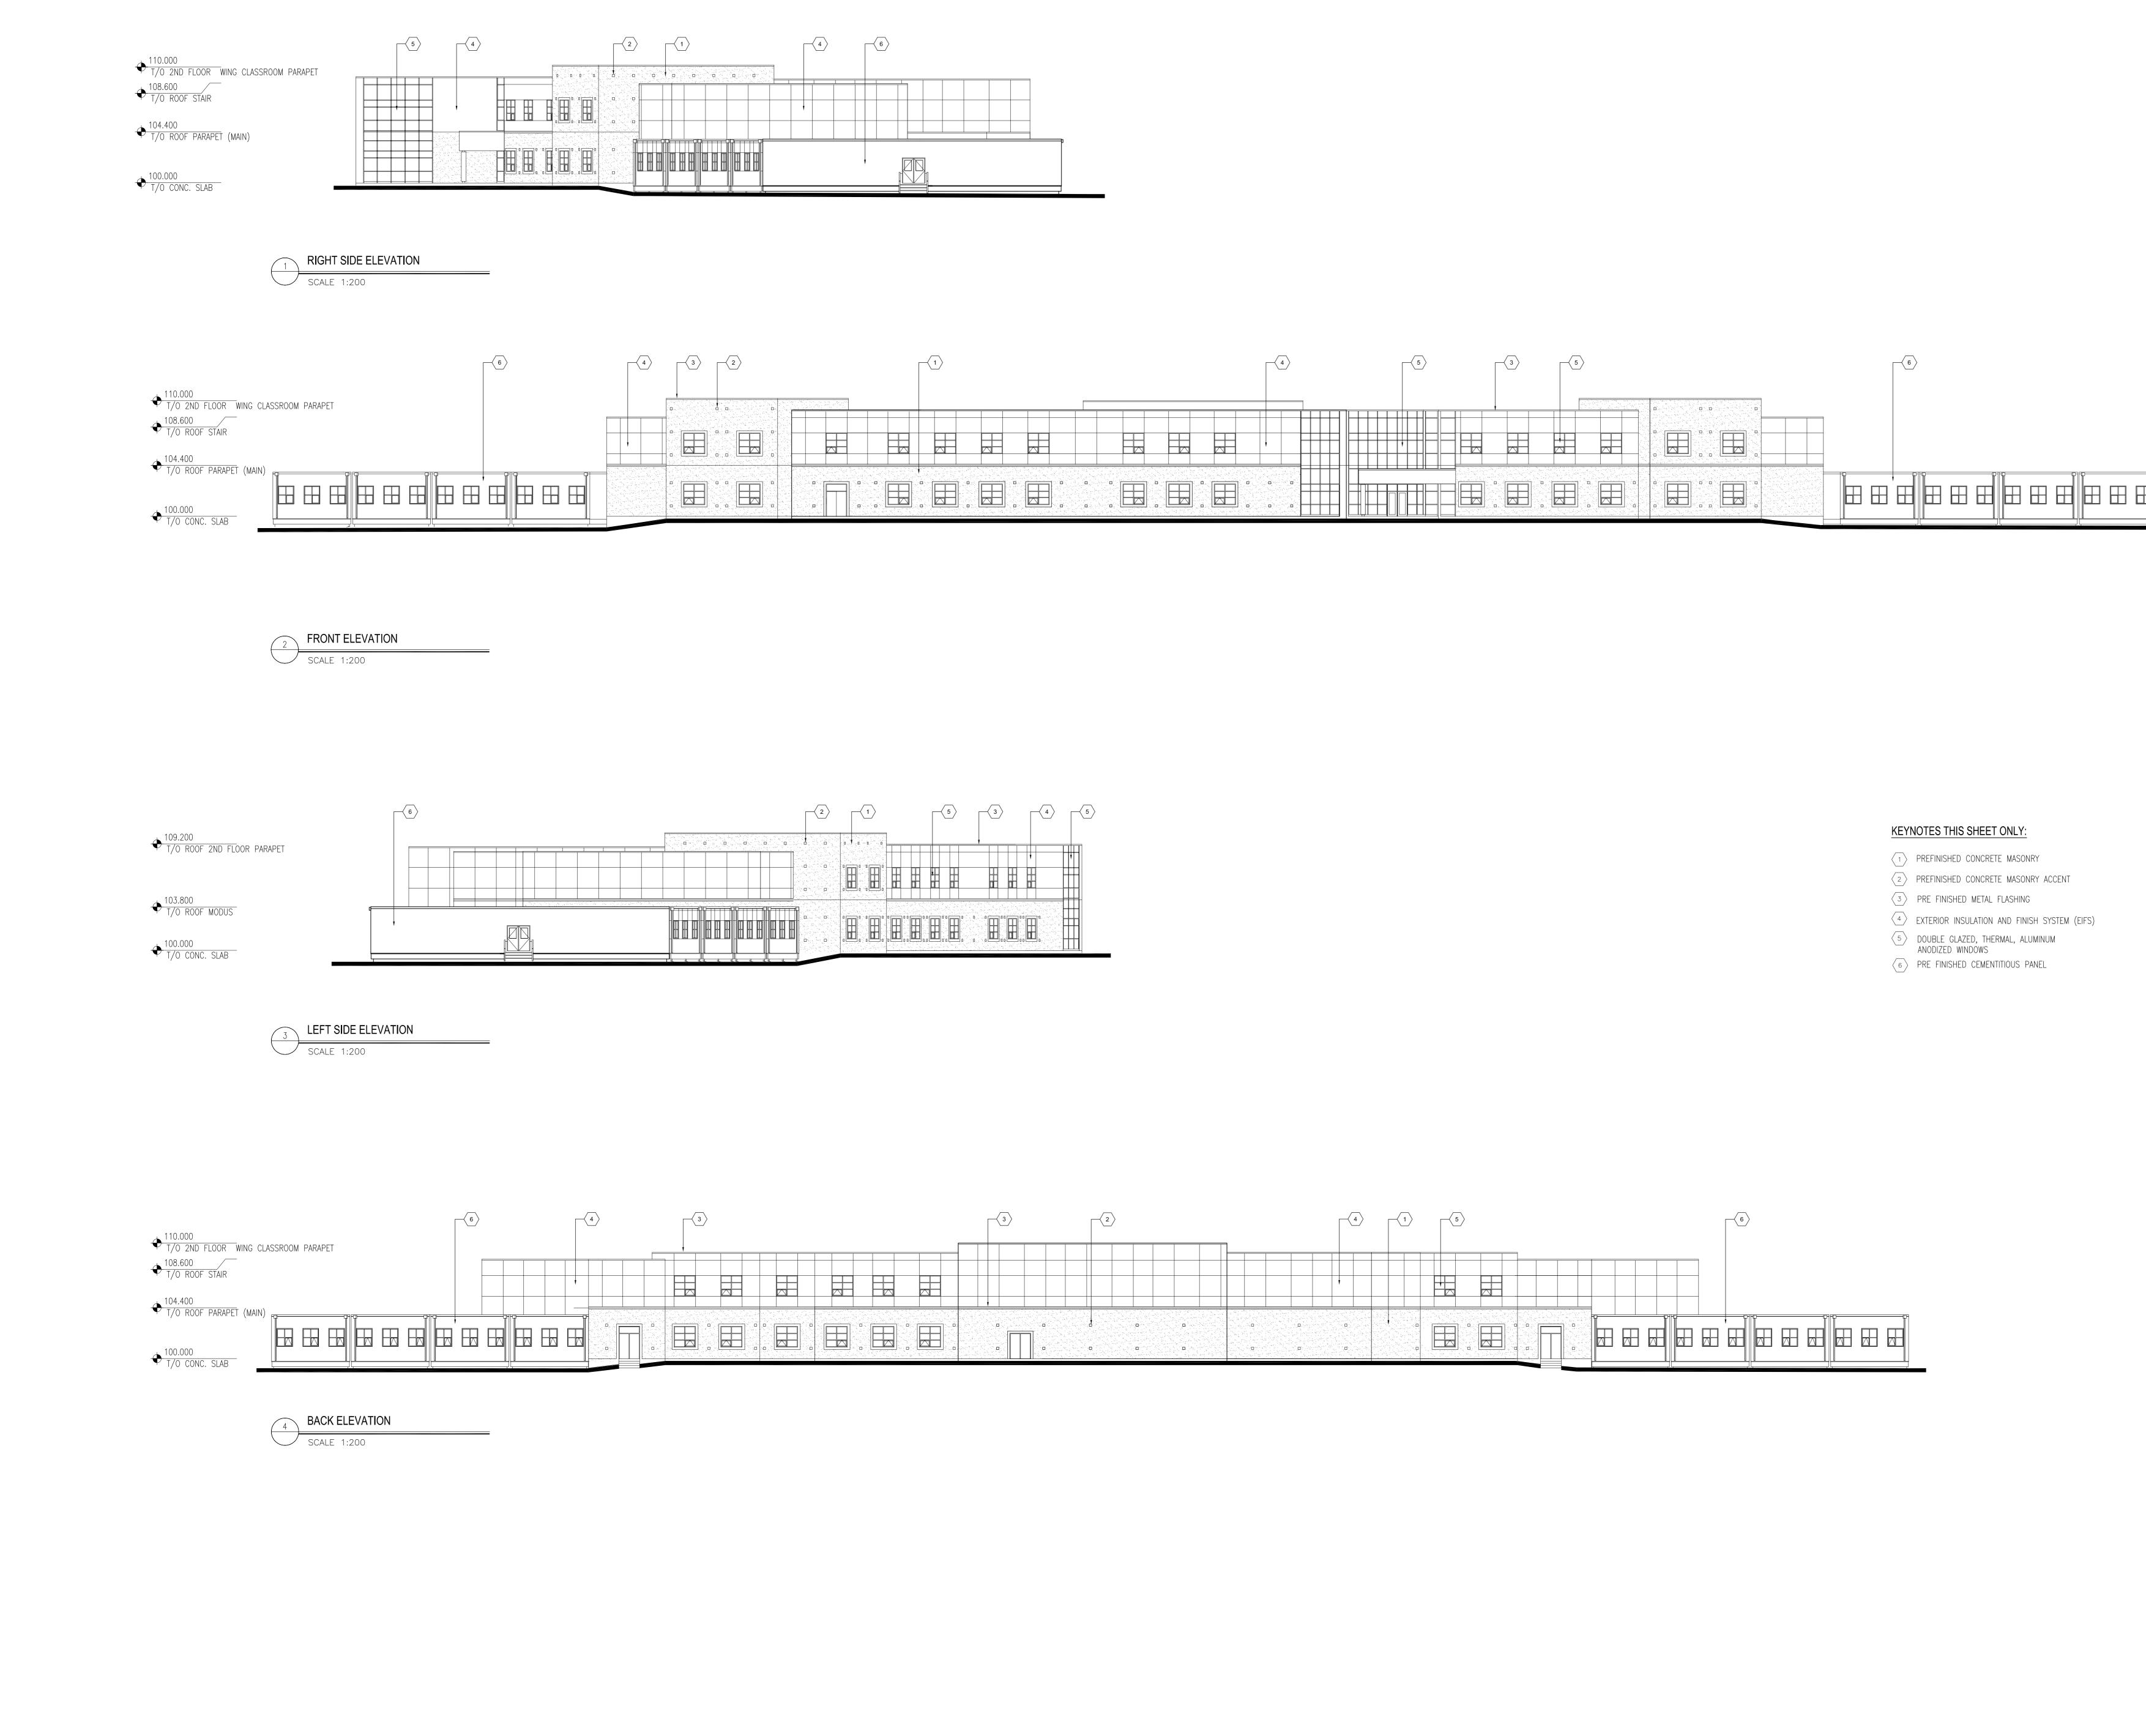
### PARAPET TYPES:

AIR/ VAPOUR BARRIER FILL VOID WITH INSULATION.

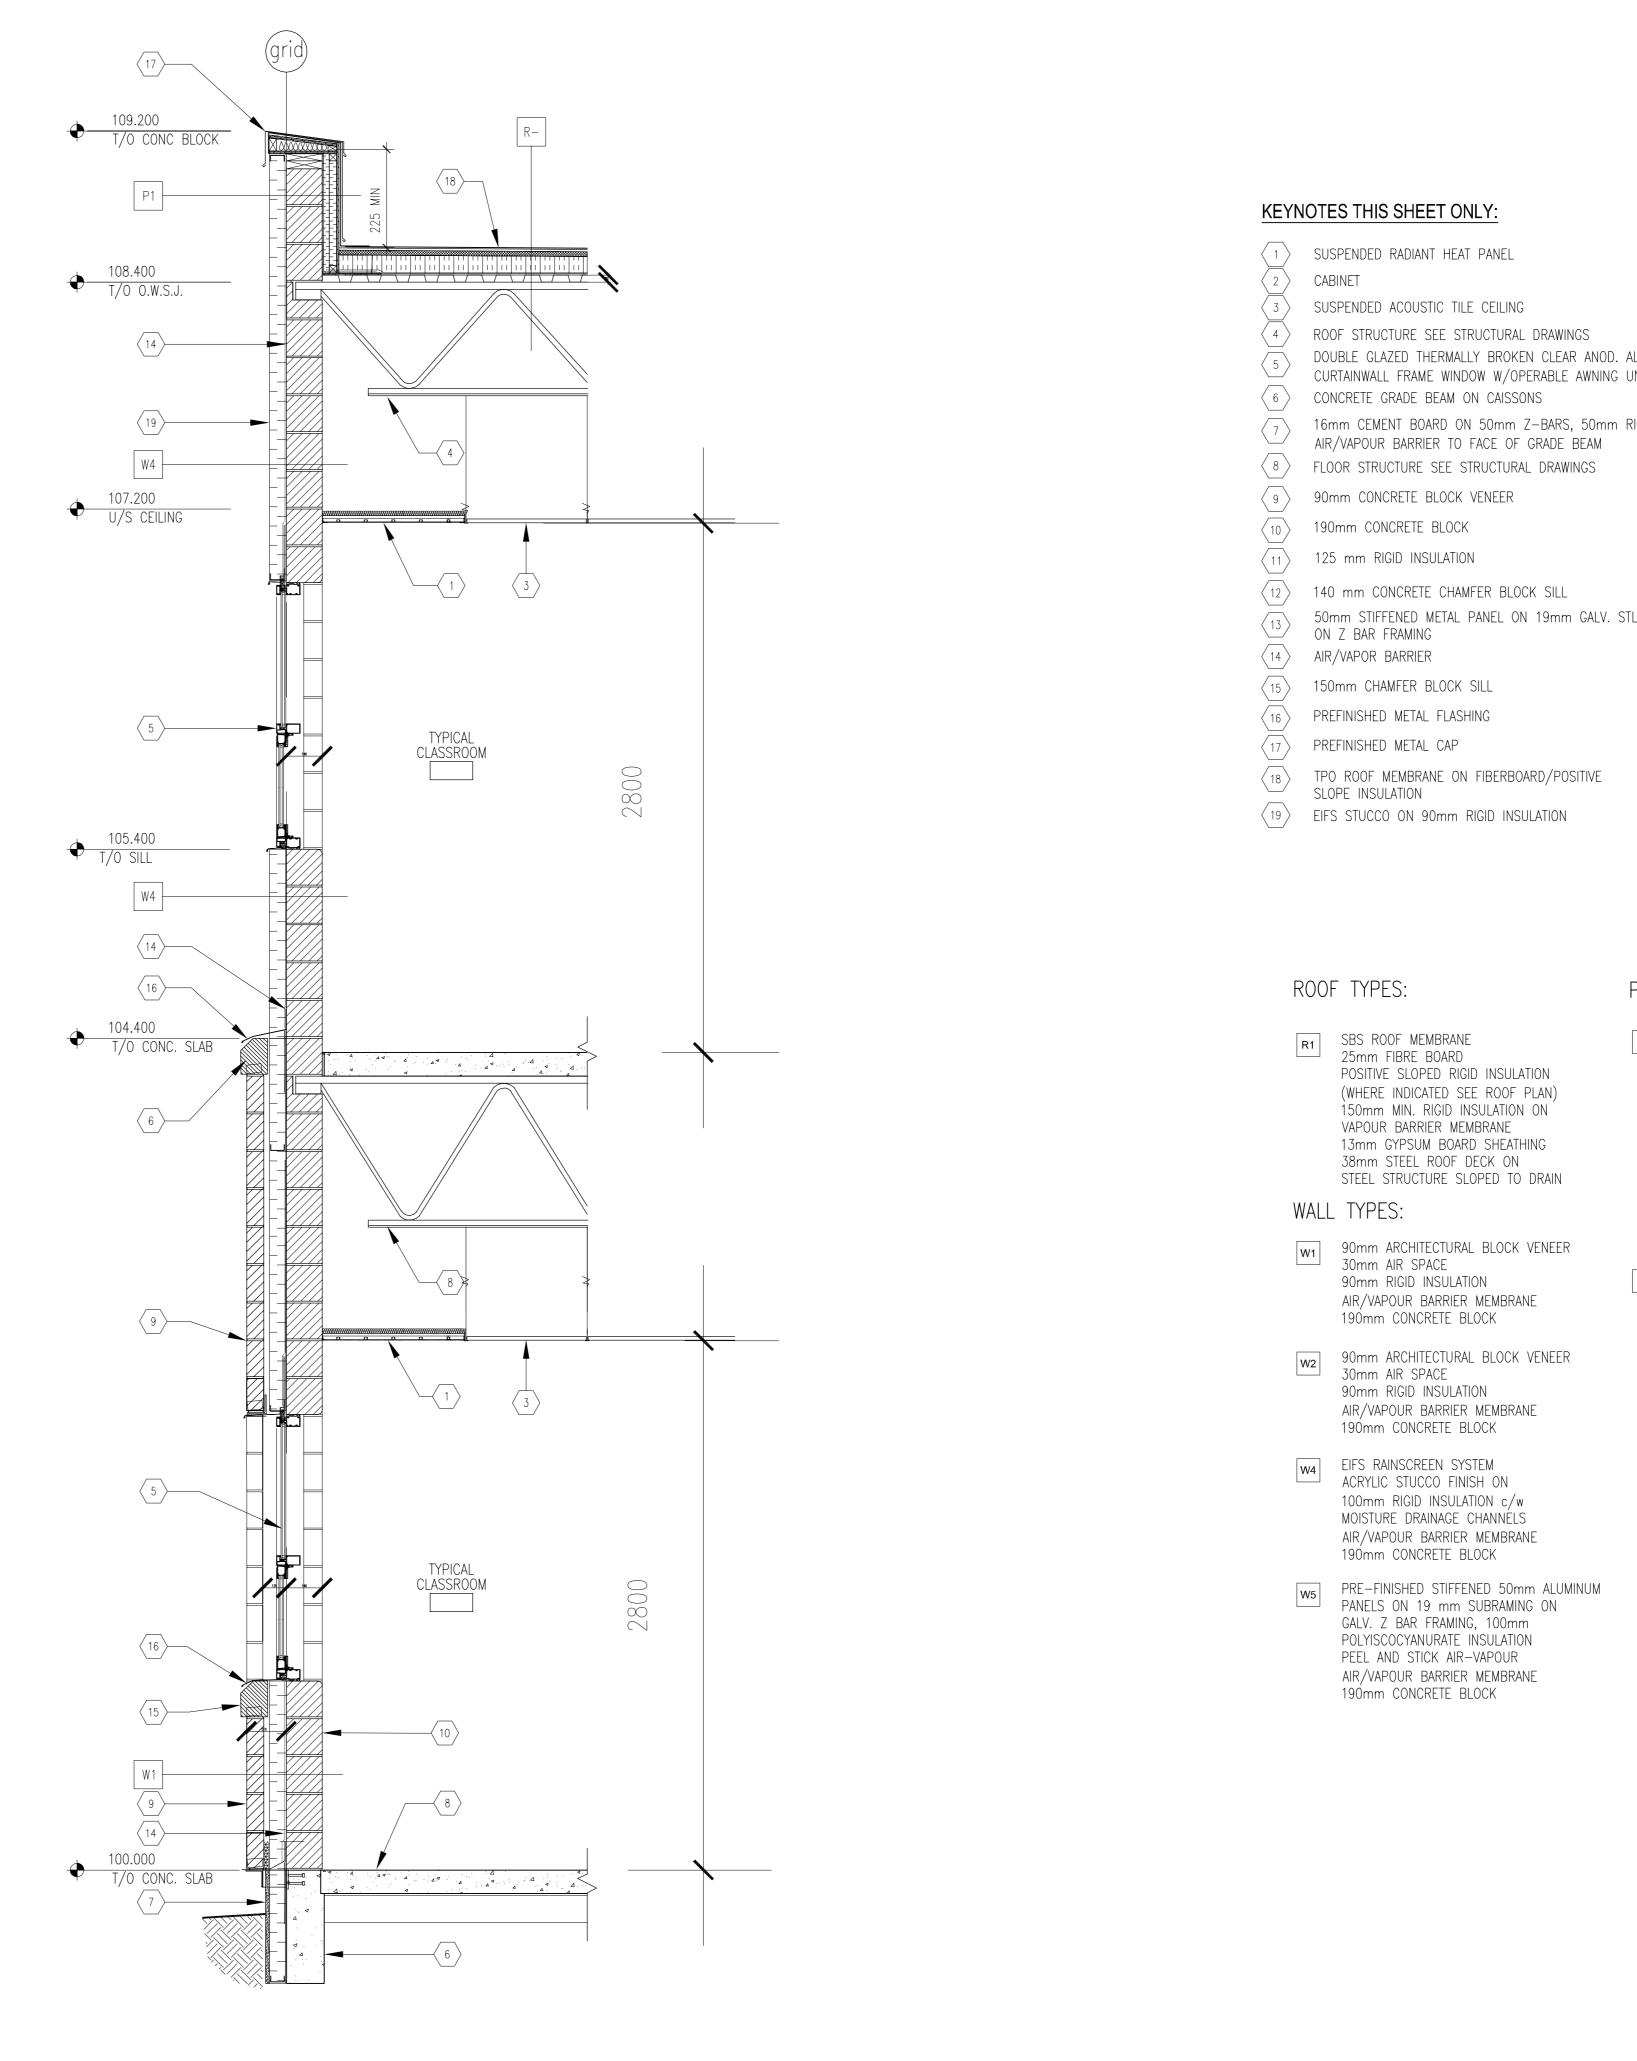

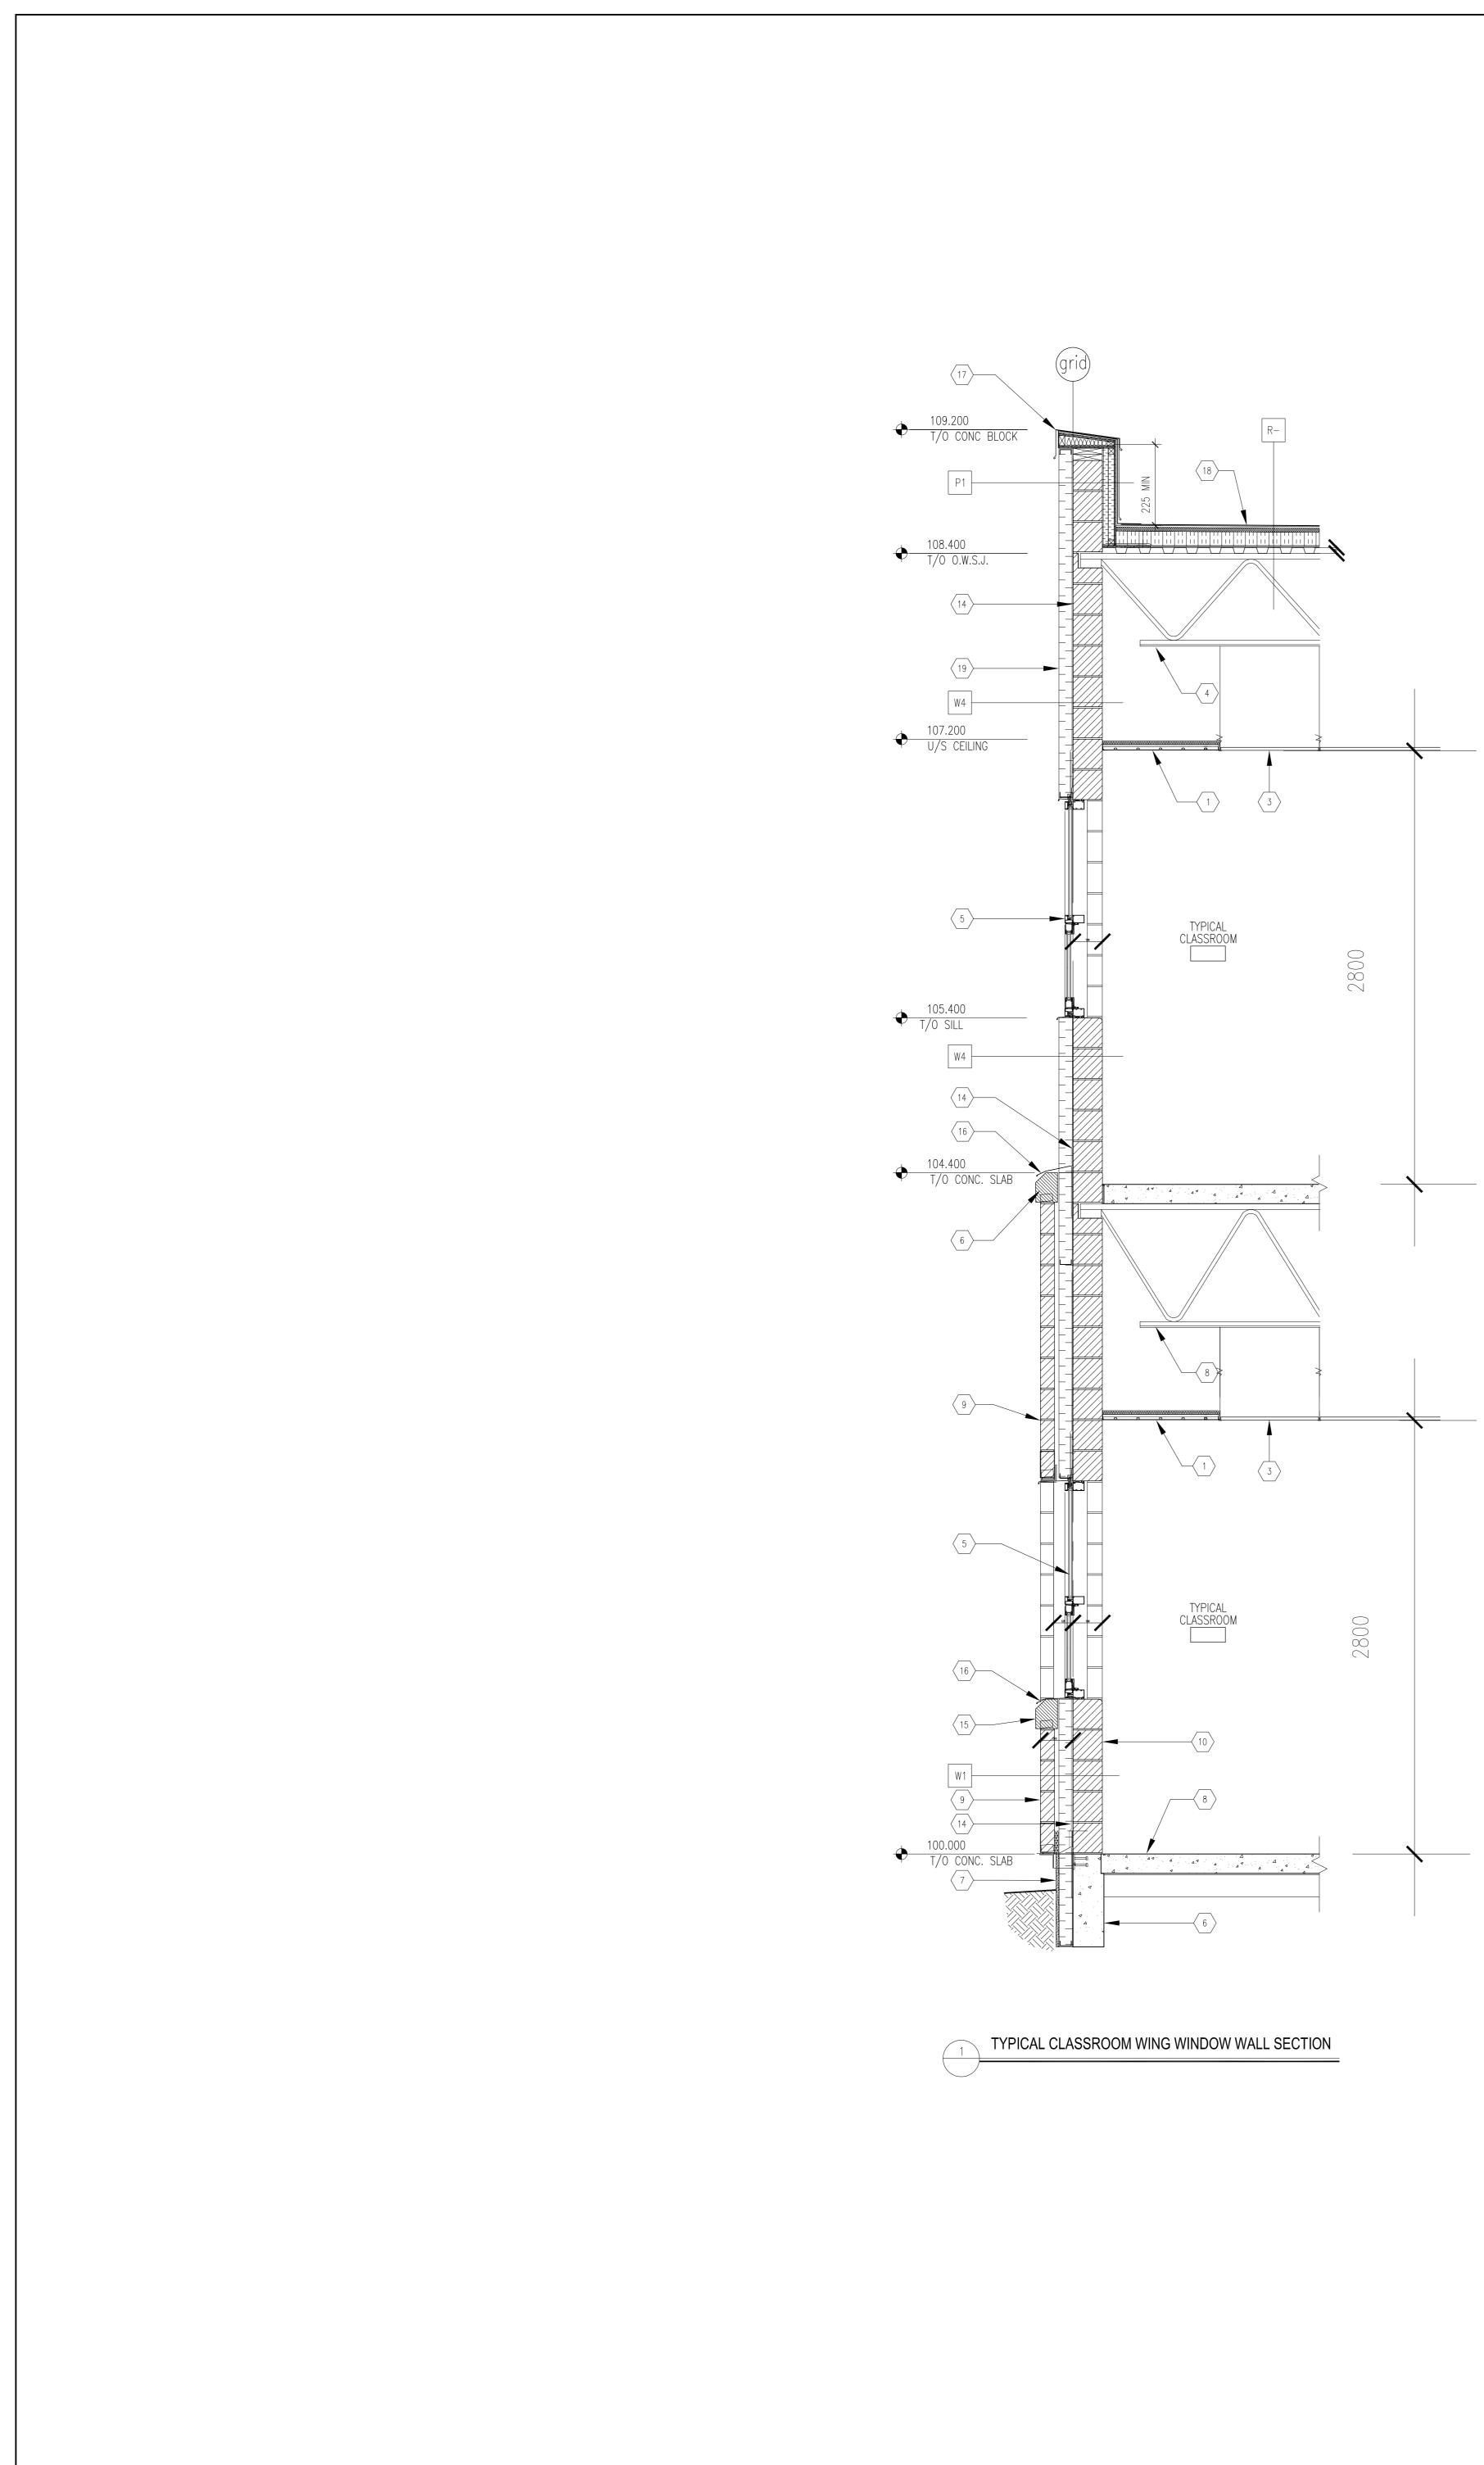

 $\langle 19 \rangle$  EIFS STUCCO ON 90mm RIGID INSULATION

### KEYNOTES THIS SHEET ONLY:

 $\langle$  1  $\rangle$  SUSPENDED RADIANT HEAT PANEL 2 CABINET SUSPENDED ACOUSTIC TILE CEILING ROOF STRUCTURE SEE STRUCTURAL DRAWINGS DOUBLE GLAZED THERMALLY BROKEN CLEAR ANOD. ALUM. CURTAINWALL FRAME WINDOW W/OPERABLE AWNING UNIT 6 CONCRETE GRADE BEAM ON CAISSONS 16mm CEMENT BOARD ON 50mm Z-BARS, 50mm RIGID INSULATION, AIR/VAPOUR BARRIER TO FACE OF GRADE BEAM  $\langle 8 \rangle$  FLOOR STRUCTURE SEE STRUCTURAL DRAWINGS 9 90mm CONCRETE BLOCK VENEER 0 190mm CONCRETE BLOCK > 125 mm RIGID INSULATION 12 140 mm CONCRETE CHAMFER BLOCK SILL 50mm STIFFENED METAL PANEL ON 19mm GALV. STL BATTENS ON Z BAR FRAMING (14) AIR/VAPOR BARRIER 15 150mm CHAMFER BLOCK SILL PREFINISHED METAL FLASHING 17 PREFINISHED METAL CAP TPO ROOF MEMBRANE ON FIBERBOARD/POSITIVE SLOPE INSULATION


### ROOF TYPES:

### PARAPET TYPES:


- R1 SBS ROOF MEMBRANE 25mm FIBRE BOARD POSITIVE SLOPED RIGID INSULATION (WHERE INDICATED SEE ROOF PLAN) 150mm MIN. RIGID INSULATION ON VAPOUR BARRIER MEMBRANE 13mm GYPSUM BOARD SHEATHING 38mm STEEL ROOF DECK ON STEEL STRUCTURE SLOPED TO DRAIN
- WALL TYPES:
- W1 90mm ARCHITECTURAL BLOCK VENEER 30mm AIR SPACE 90mm RIGID INSULATION AIR/VAPOUR BARRIER MEMBRANE 190mm CONCRETE BLOCK
- w2 90mm ARCHITECTURAL BLOCK VENEER 30mm AIR SPACE 90mm RIGID INSULATION AIR/VAPOUR BARRIER MEMBRANE 190mm CONCRETE BLOCK
- W4 EIFS RAINSCREEN SYSTEM ACRYLIC STUCCO FINISH ON 100mm RIGID INSULATION c/w MOISTURE DRAINAGE CHANNELS AIR/VAPOUR BARRIER MEMBRANE 190mm CONCRETE BLOCK
- W5 PRE-FINISHED STIFFENED 50mm ALUMINUM PANELS ON 19 mm SUBRAMING ON GALV. Z BAR FRAMING, 100mm POLYISCOCYANURATE INSULATION PEEL AND STICK AIR-VAPOUR AIR/VAPOUR BARRIER MEMBRANE 190mm CONCRETE BLOCK


- PT PREFINISHED METAL COPING FLASHING INCLUDING COUNTERFLASHING. CARRY SBS ROOF MEMBRANE FROM ROOF TO TOP OF WOOD COPING. 190 CONCRETE BLOCK AIR/ VAPOUR BARRIER 50mm STIFFENED METAL PANEL ON 19 mm GALV. STEEL BATTENS AND Z GIRT FRAMING 100mm RIGID INSULATION c/w MOISTURE DRAINAGE CHANNELS AIR/VAPOUR BARRIER MEMBRANE 190 CONCRETE BLOCK
- P2 PREFINISHED METAL COPING FLASHING INCLUDING COUNTERFLASHING. CARRY SBS ROOF MEMBRANE FROM ROOF TO TOP OF WOOD COPING. WOOD COPING TO CONSIST OF 13mm EXT. GRADE PLYWOOD ON PRESSURE TREATED WOOD BLOCKING ON 16mm EXTERIOR GRADE PLYWOOD FILL VOID WITH INSULATION. EASTENED TO EXTERIOR 13mm GYPSUM SHEA FASTENED TO EXTERIOR 13mm GYPSUM SHEATHING TO TOP TRACK OF METAL STUD. 38mm X 89mm PRESSURE TREATED WOOD BLOCKING FASTENED TO SHEATHING 90mm ARCHITECTURAL BLOCK 30mm AIR SPACE AIR/VAPOUR BARRIER MEMBRANE 13mm EXT. GYPSUM BOARD SHEATHING 152mm STEEL STUDS @ 400mm O.C. R20 BATT INSULATION 16mm ABUSE RESISTANT GYPSUM BOARD 38mm X 38mm PRESSURE TREATED WOOD STUD @ 400.0.0 STUD @ 400 O.C.
  - FILL VOID W/ RIGID INSULATION ON 13mm EXTERIOR GRADE PLYWOOD TPO ROOF MEMBRANE


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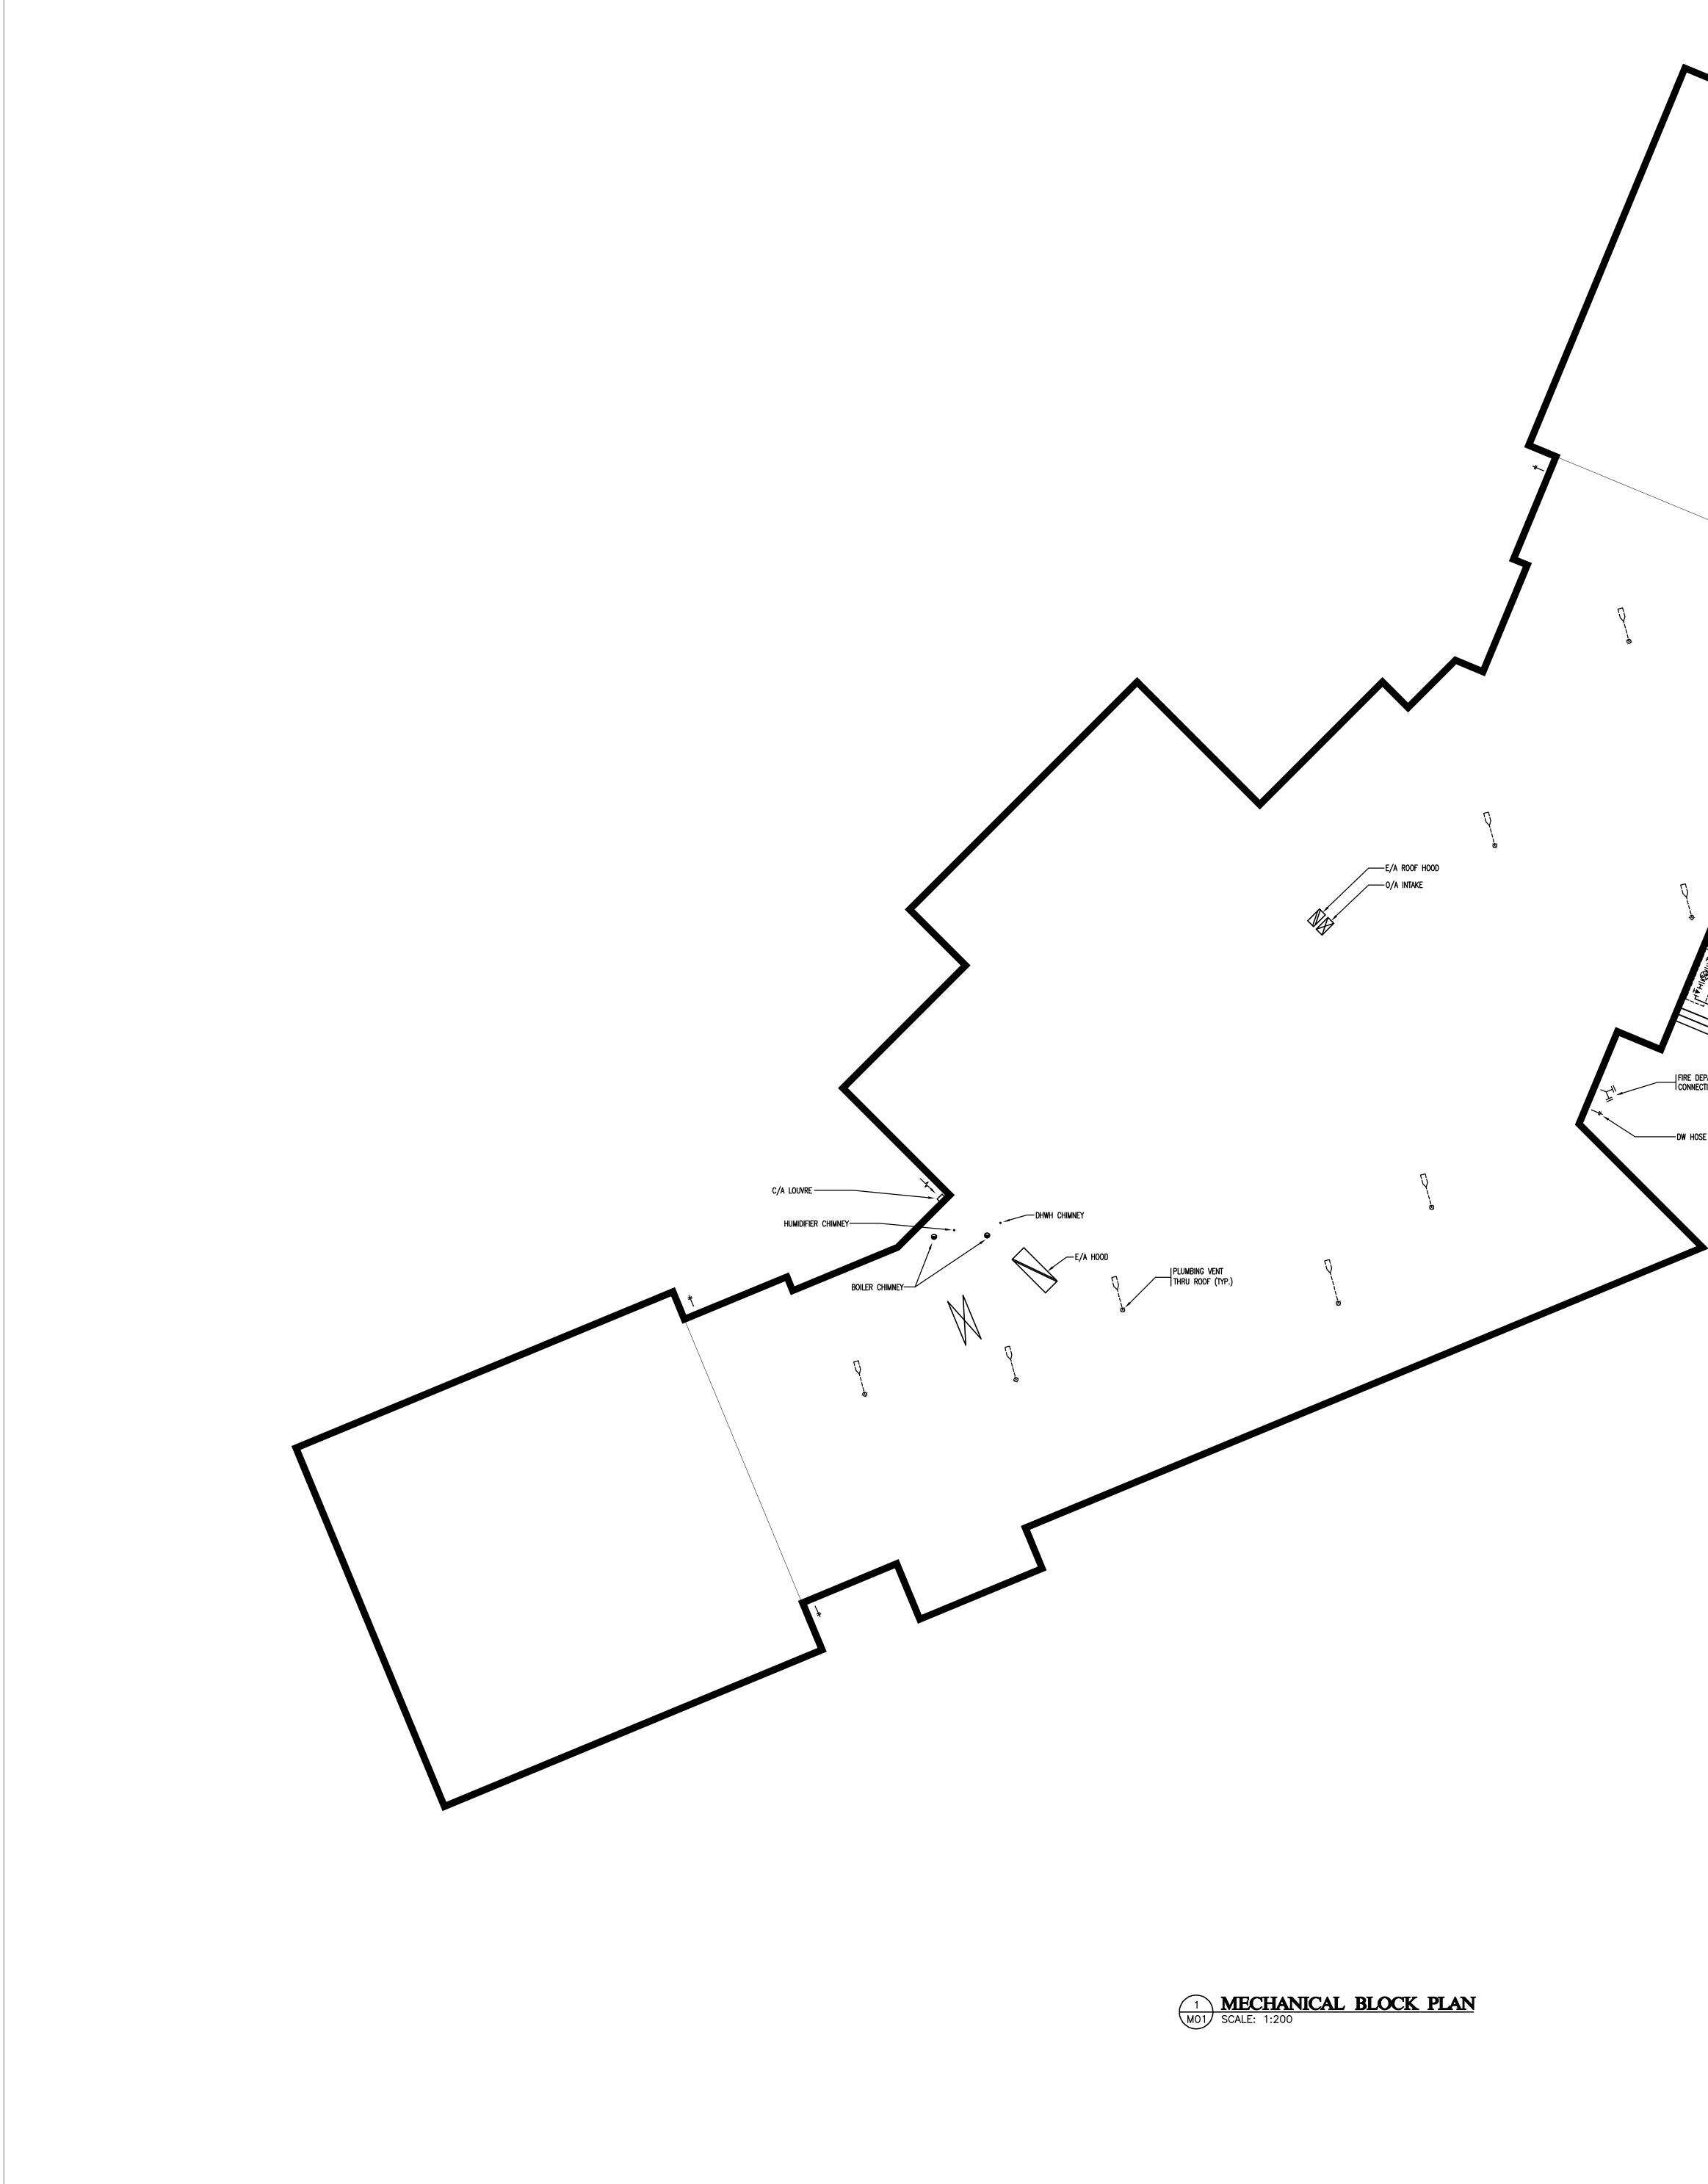


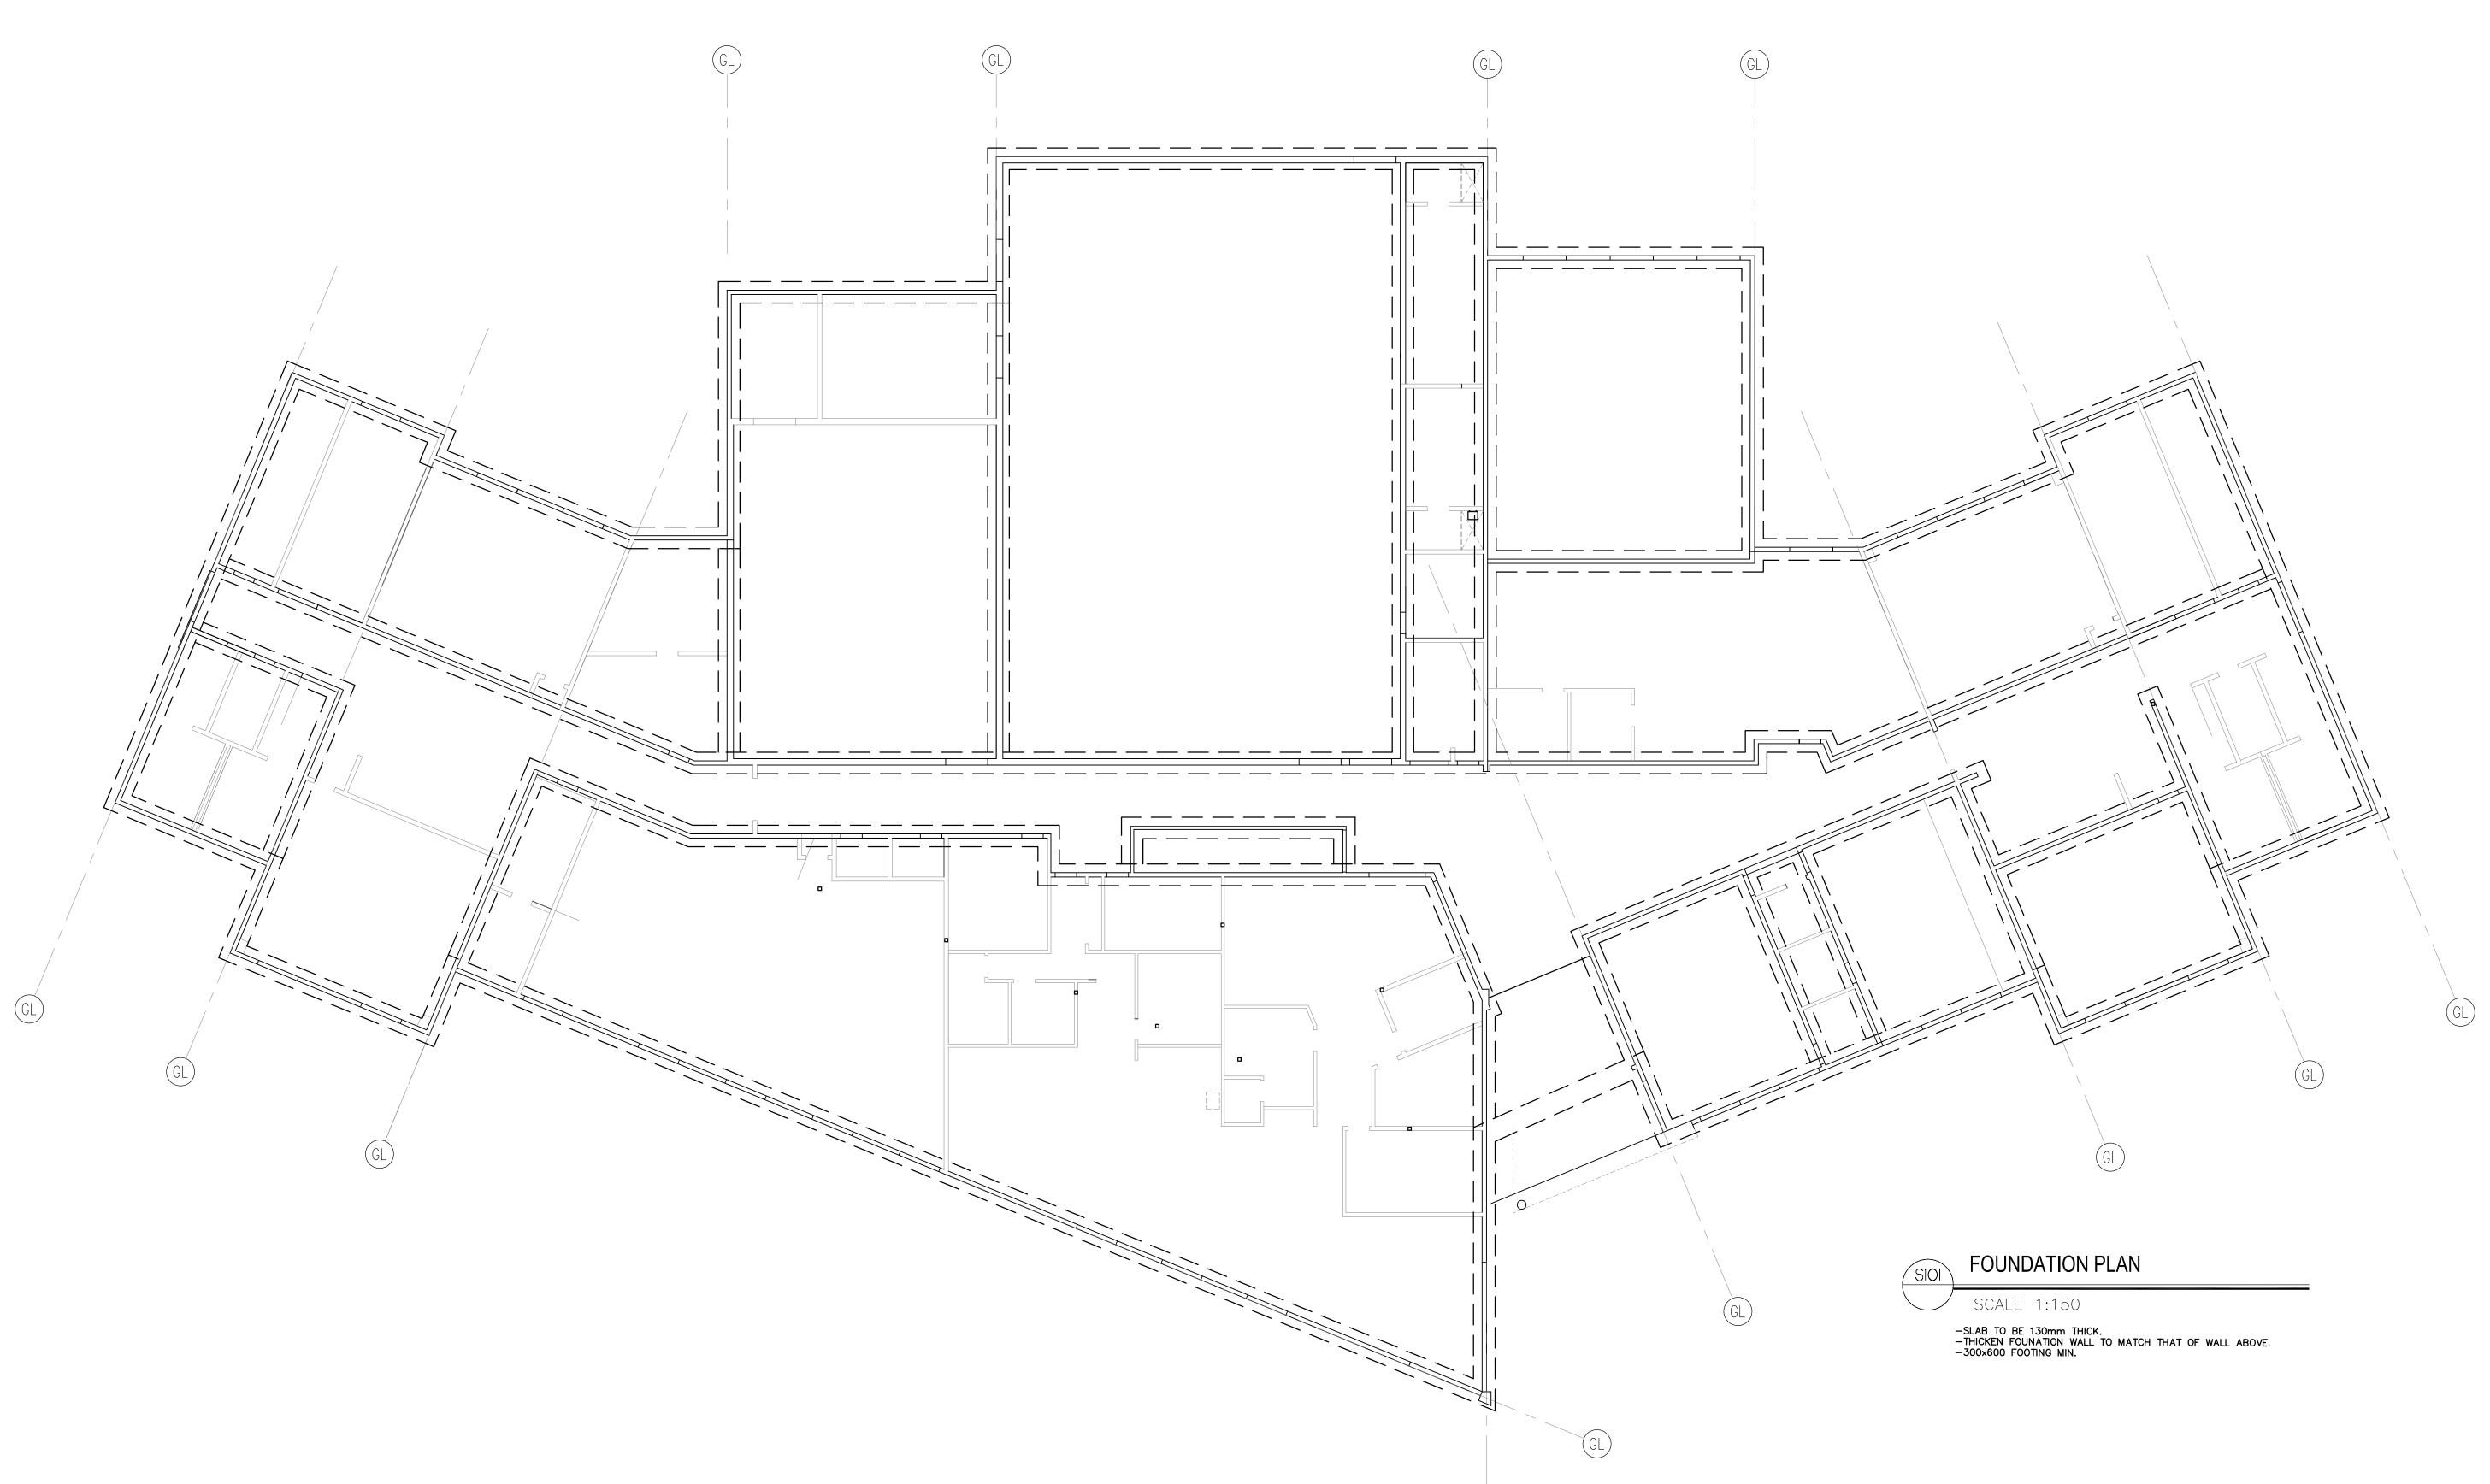ARCHITECTS & INTERIOR DESIGNERS 210, 10190 - 104 St. Edmonton, Alberta Canada T5J 1A7 Tel: (780) 423-6606 Fax: (780) 429-3962
<b>EXAMPLE 1</b> Service Structure Struct
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1       10/31/07       ISSUED FOR FINAL DESIGN DEVELOPMENT         NO       DATE       DESCRIPTION         REVISIONS         SEAL / PERMIT
PROJECT BOO STUDENT K-9 CORE SCHOOL ALBERTA SHEET TITLE FOUNDATION PLAN
DrawnCheckedDACCALProject No.Date07-2288OCT 31/07ScaleSheet No.1:150S101



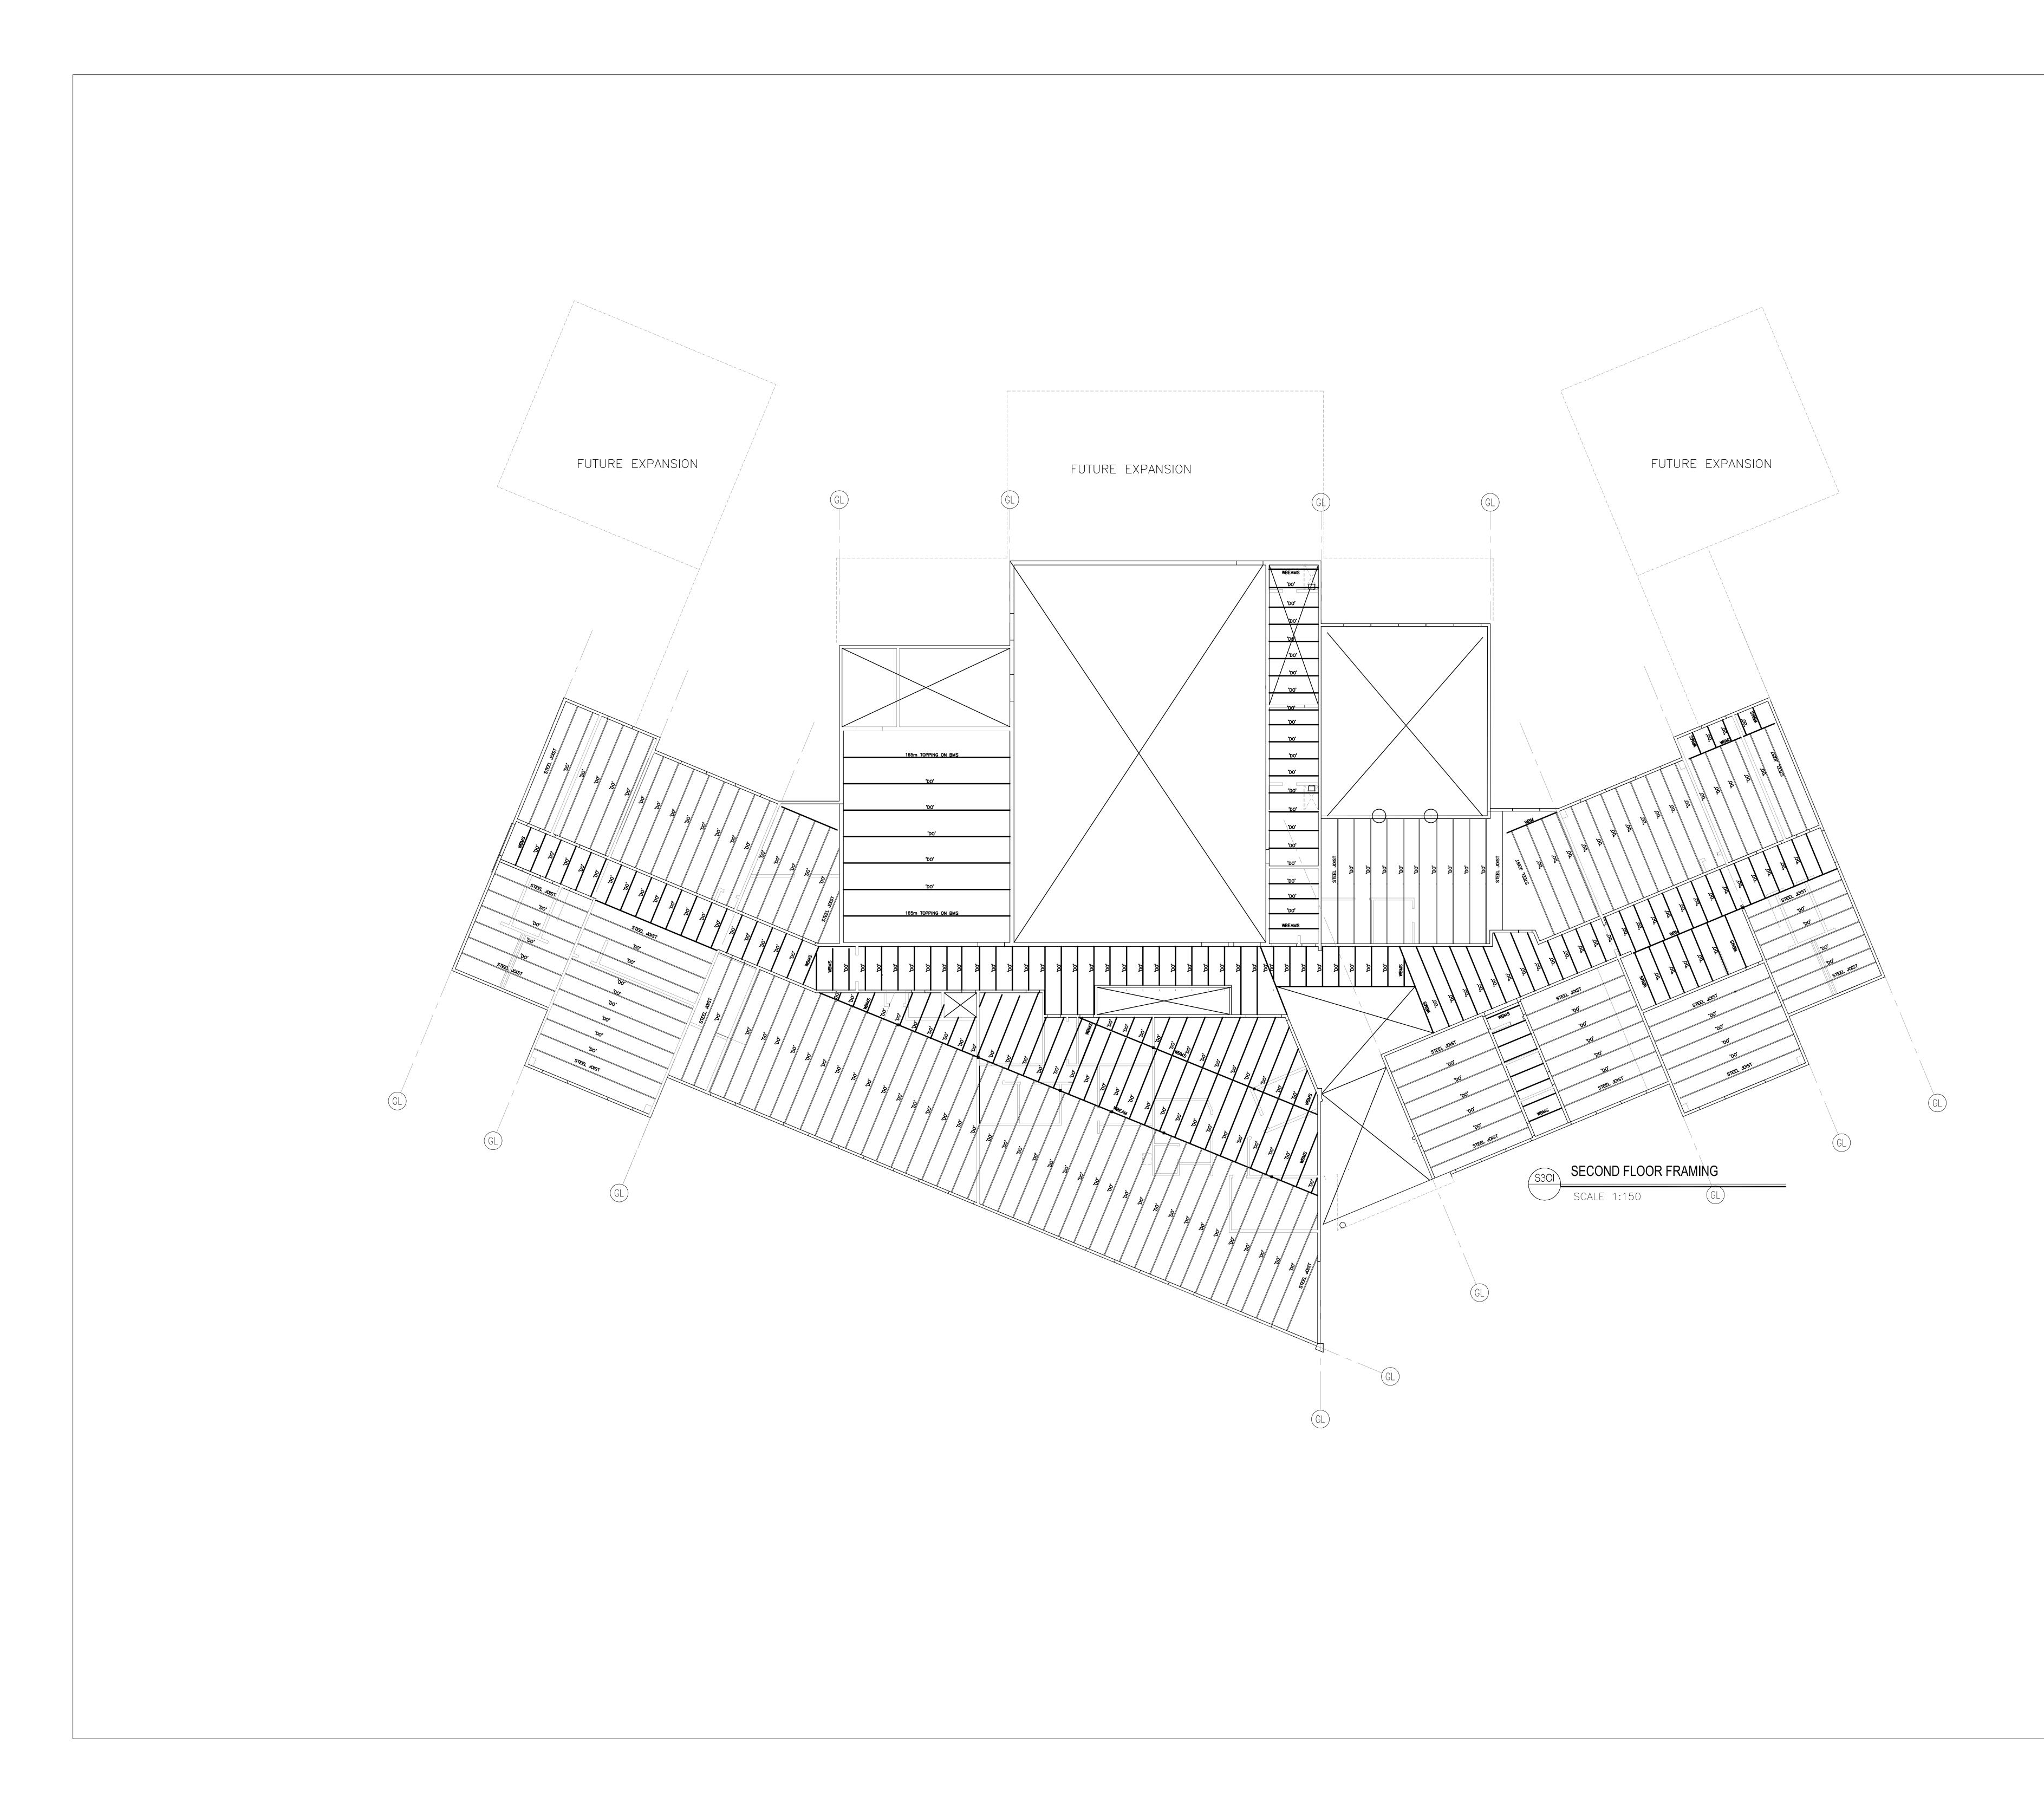

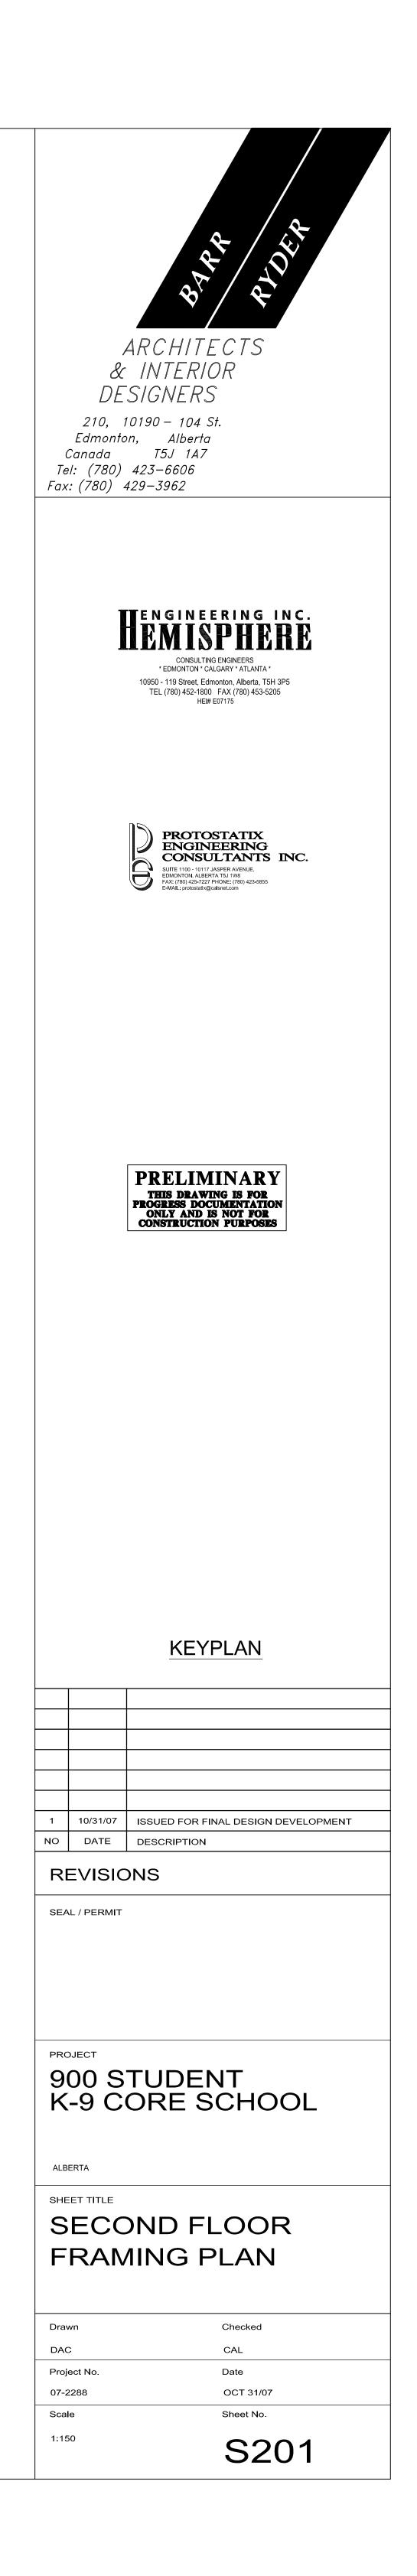


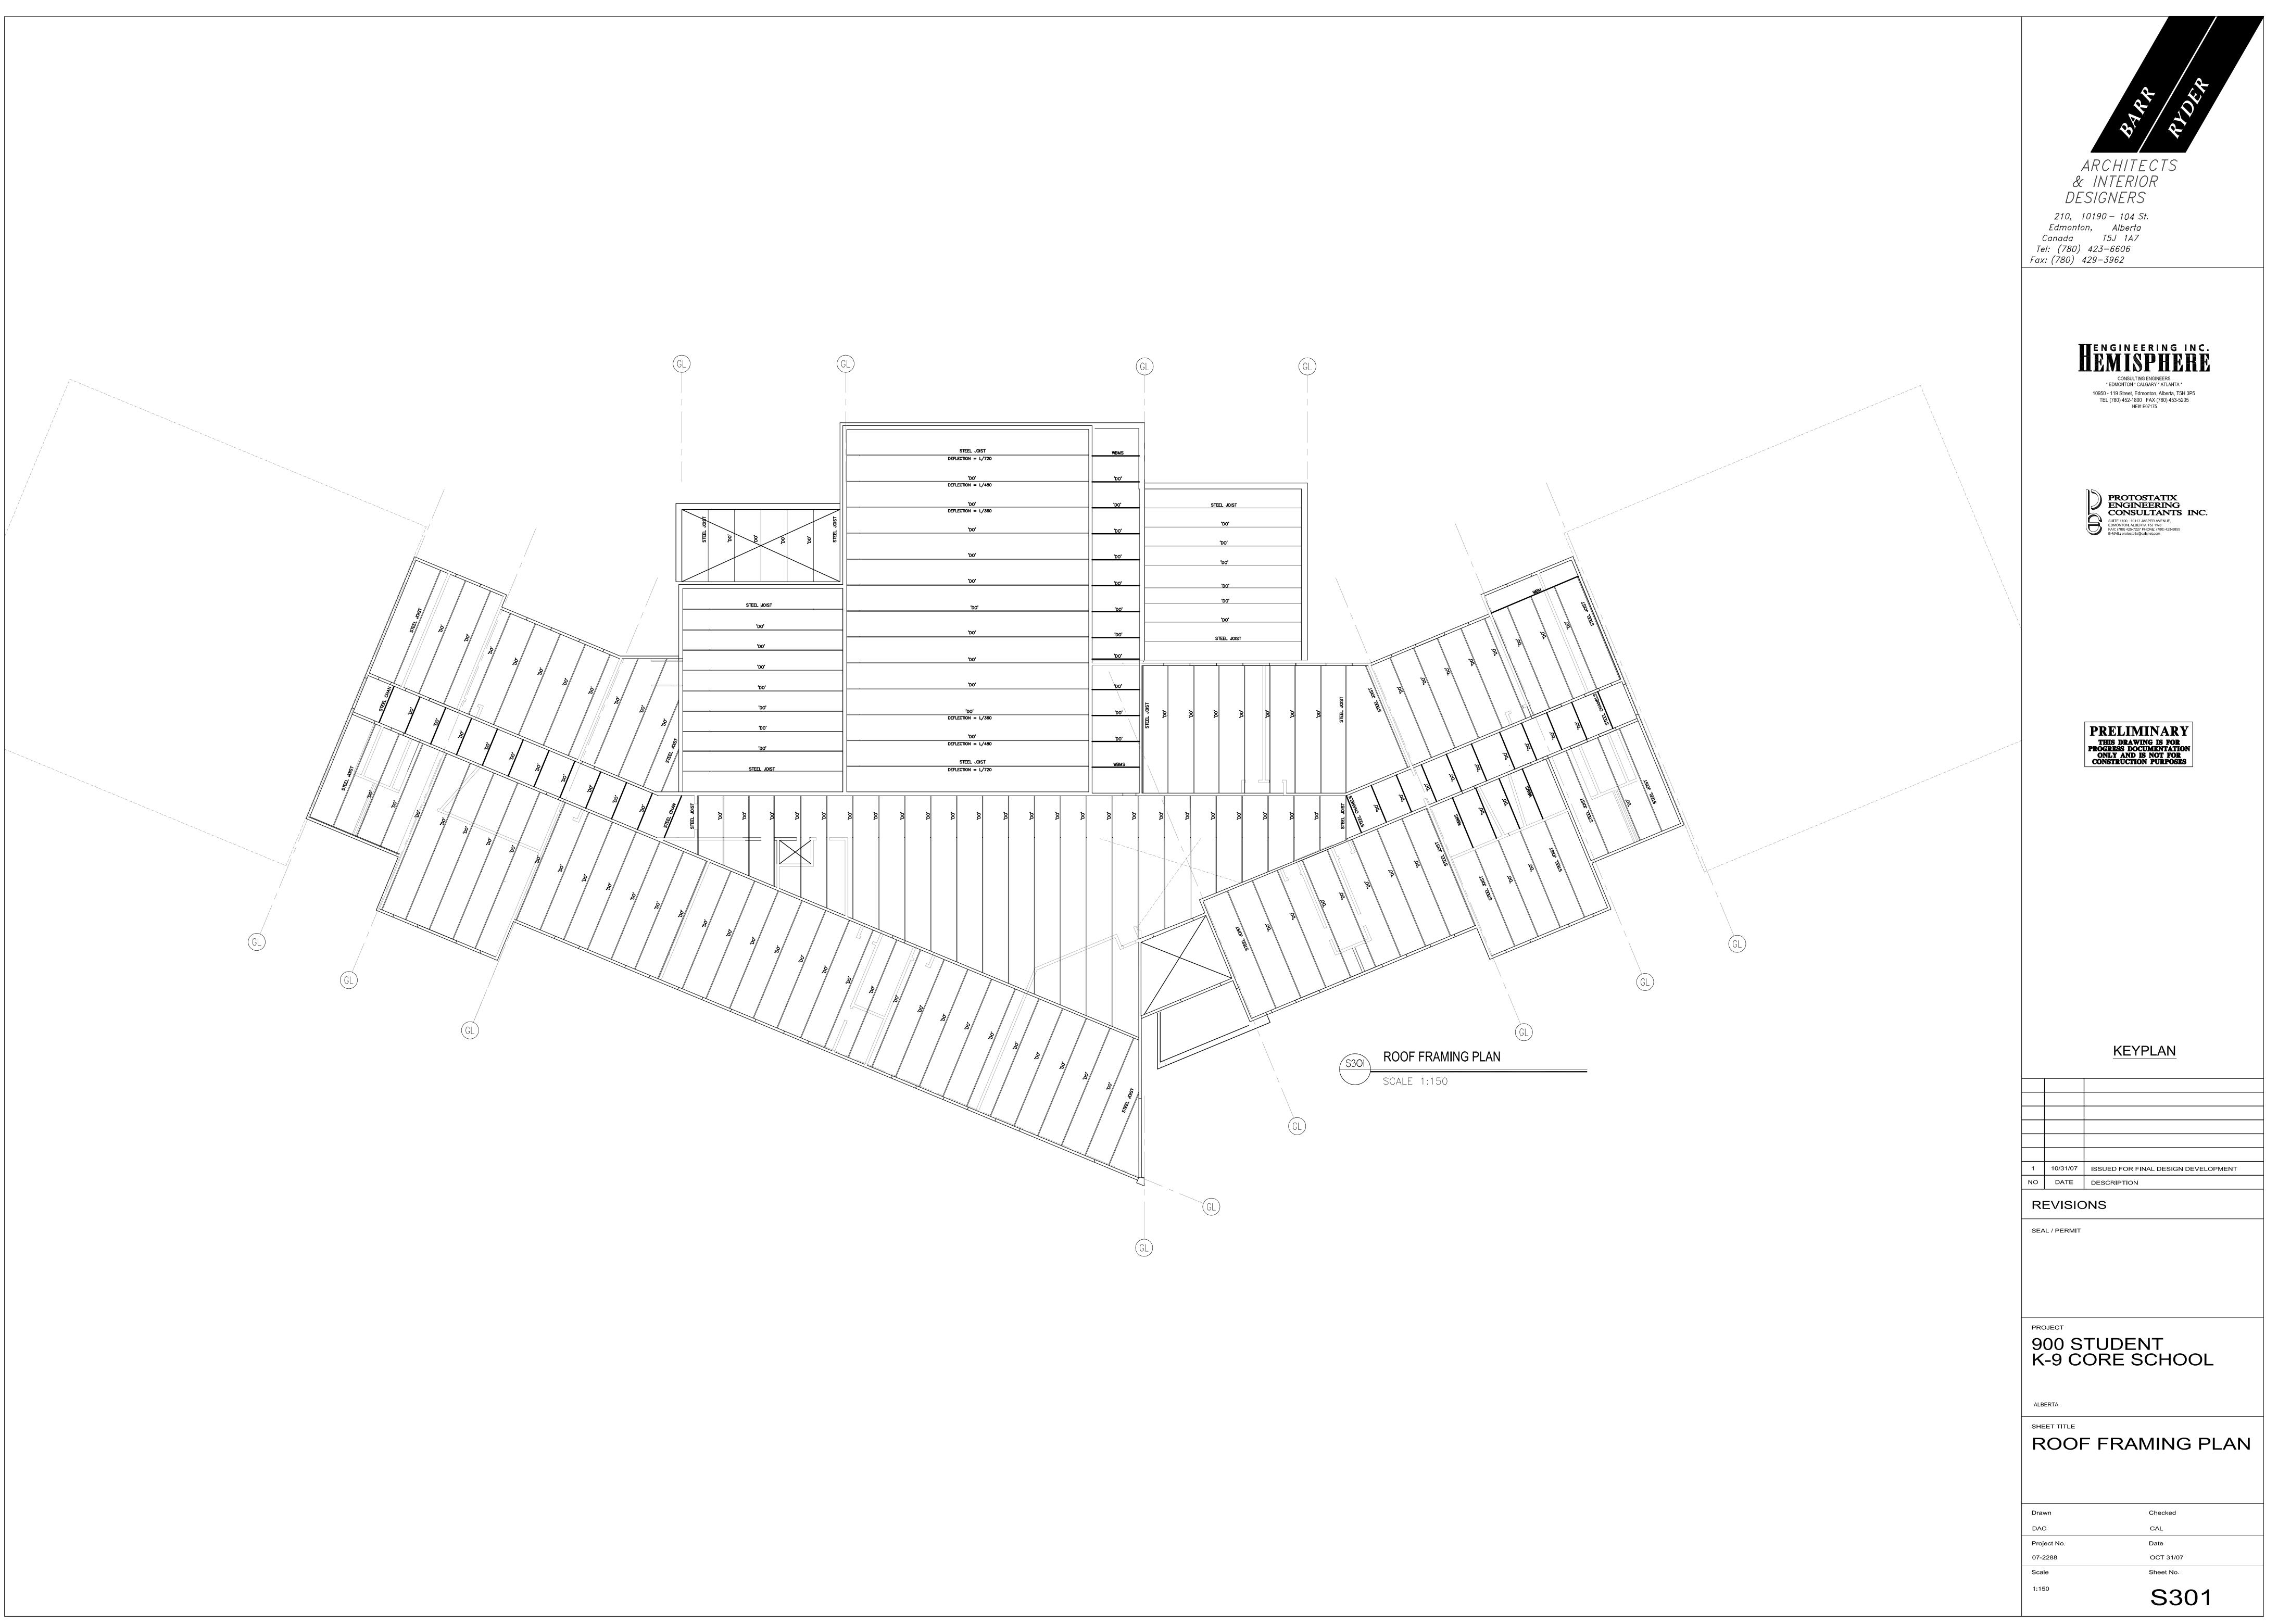


	MECHAN
	ELBOW RISING
	TOP TAKEOFF
	BOTTOM TAKEOFF
	ELBOW DROPPING
	SHUTOFF VALVE VERTICAL MOUNT
	THROTTLING VALVE
	CHECK VALVE
	2-WAY CONTROL VALVE
	3-WAY CONTROL VALVE
	MECHANICAL PRESSURE REDUCING Y RELIEF VALVE
	UNION OR FLANGE
	AUTOMATIC AIR VENT
	CAP OR PLUG
	PUMP
	NEW THERMOSTAT/THERMOSTAT C/
	SWITCH
	THERMOMETER/THERMOMETER & PR
	PRESSURE GAUGE/PRESSURE TAP -
	FLOW METER
	FIRE EXTINGUISHER C/W CABINET ( FIRE HOSE CABINET
	SIAMESE CONNECTION
	SANITARY DRAIN
	STORM DRAIN
	ACID WASTE
	INDIRECT DRAIN
	DOMESTIC HOT WATER
	DOMESTIC HOT WATER RECIRC.
	GAS-LOW PRESSURE
	CLEANOUT
	FLOOR DRAIN
	HUB DRAIN
	ROOF DRAIN
	PLUMBING FIXTURE (TYPE NOTED) -
	REDUCED BACKFLOW PRESSURE AS
	SANITARY VENT CAP
	RUNNING TRAP
	FIRE HYDRANT
	MANHOLE
	CATCH BASIN
	SUPPLY DUCT (UP & DOWN)
	EXHAUST (UP & DOWN)
	ROUND DUCT (UP & DOWN)
	FLEXIBLE DUCT CONNECTION
	OPPOSED BLADE DAMPERS
DIAGRAMMATIC LOCATION	MOTORIZED DAMPER
OF GAS METER.	
CONFIRM EXACT LOCATION ON SITE. CO-ORDINATE WITH WINDOW LOCATION.	DIFFUSER
	FIRE DAMPER OR SMOKE DAMPER-
	ACOUSTIC LINED DUCTWORK
CONNECT NEW GAS, WATER, SANITARY AND	
STORM PIPING TO EXISTING CITY SERVICE.	
DETERMINE EXACT	AIR OUTLET OR INLET
PARTMENT	
TION Y	RADIANT PANEL
e BIBB (TYP.)	
	RADIATION


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		HENGINEERING INC.
		<b>EXAMPLE A CONSULTING ENGINEERS</b> * EDMONTON * CALGARY * ATLANTA *
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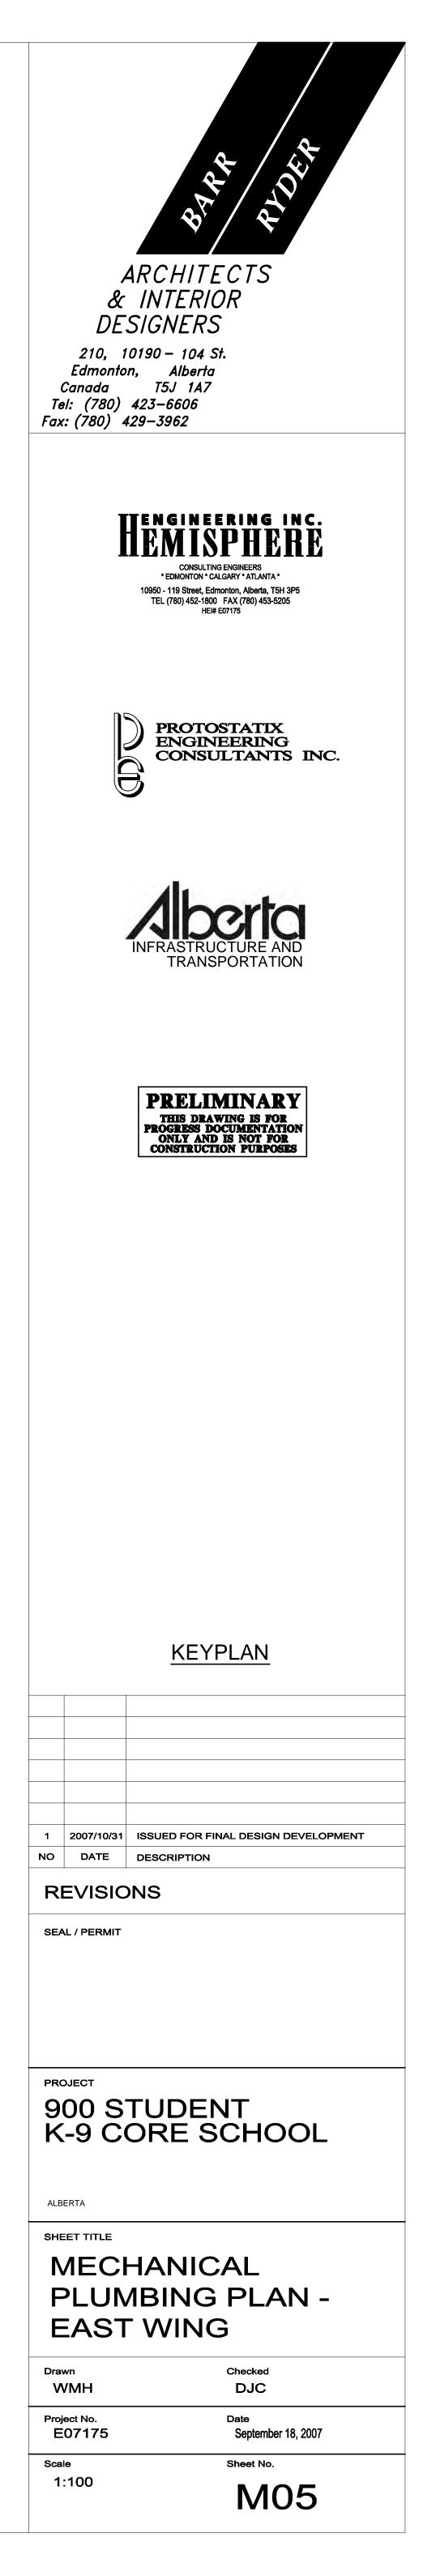


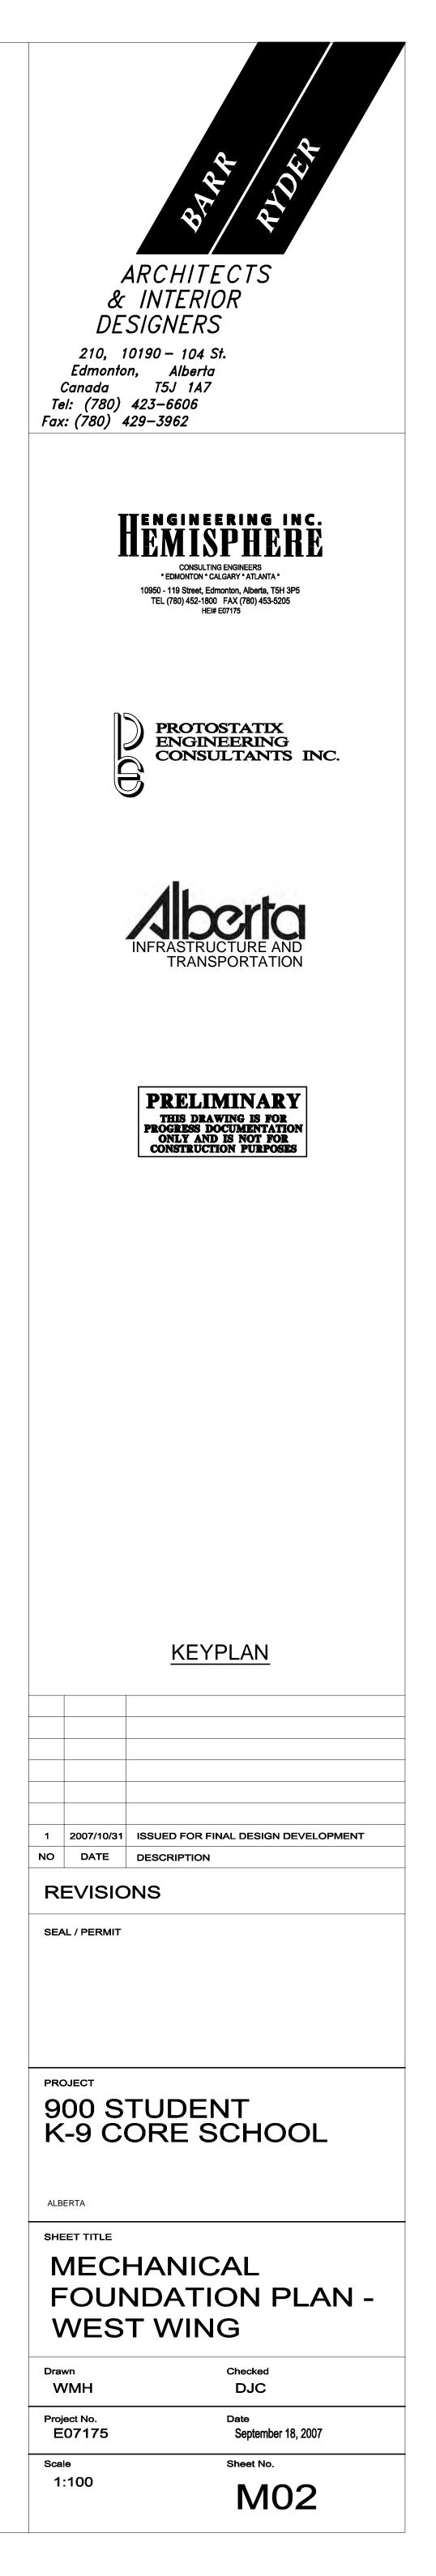

ARCHITECTS & INTERIOR DESIGNERS 210, 10190 – 104 St. Edmonton, Alberta Canada T5J 1A7 Tel: (780) 423–6606 Fax: (780) 429–3962 CONSULTING ENGINEERS \* EDMONTON \* CALGARY \* ATLANTA\* 10950 - 119 Street, Edmonton, Alberta, T5H 3P5 TEL (780) 452-1800 FAX (780) 453-5205 HEI# E07175 PROTOSTATIX ENGINEERING CONSULTANTS INC. RASTRUCTURE AND TRANSPORTATION PRELIMINARY THIS DRAWING IS FOR PROGRESS DOCUMENTATION ONLY AND IS NOT FOR CONSTRUCTION PURPOSES <u>KEYPLAN</u> 1 2007/10/31 ISSUED FOR FINAL DESIGN DEVELOPMENT NO DATE DESCRIPTION REVISIONS SEAL / PERMIT PROJECT 900 STUDENT K-9 CORE SCHOOL ALBERTA SHEET TITLE MECHANICAL FOUNDATION PLAN -EAST WING Checked Drawn WMH \_\_\_\_\_ Project No. E07175 Date September 18, 2007 Scale Sheet No. 1:100 M03

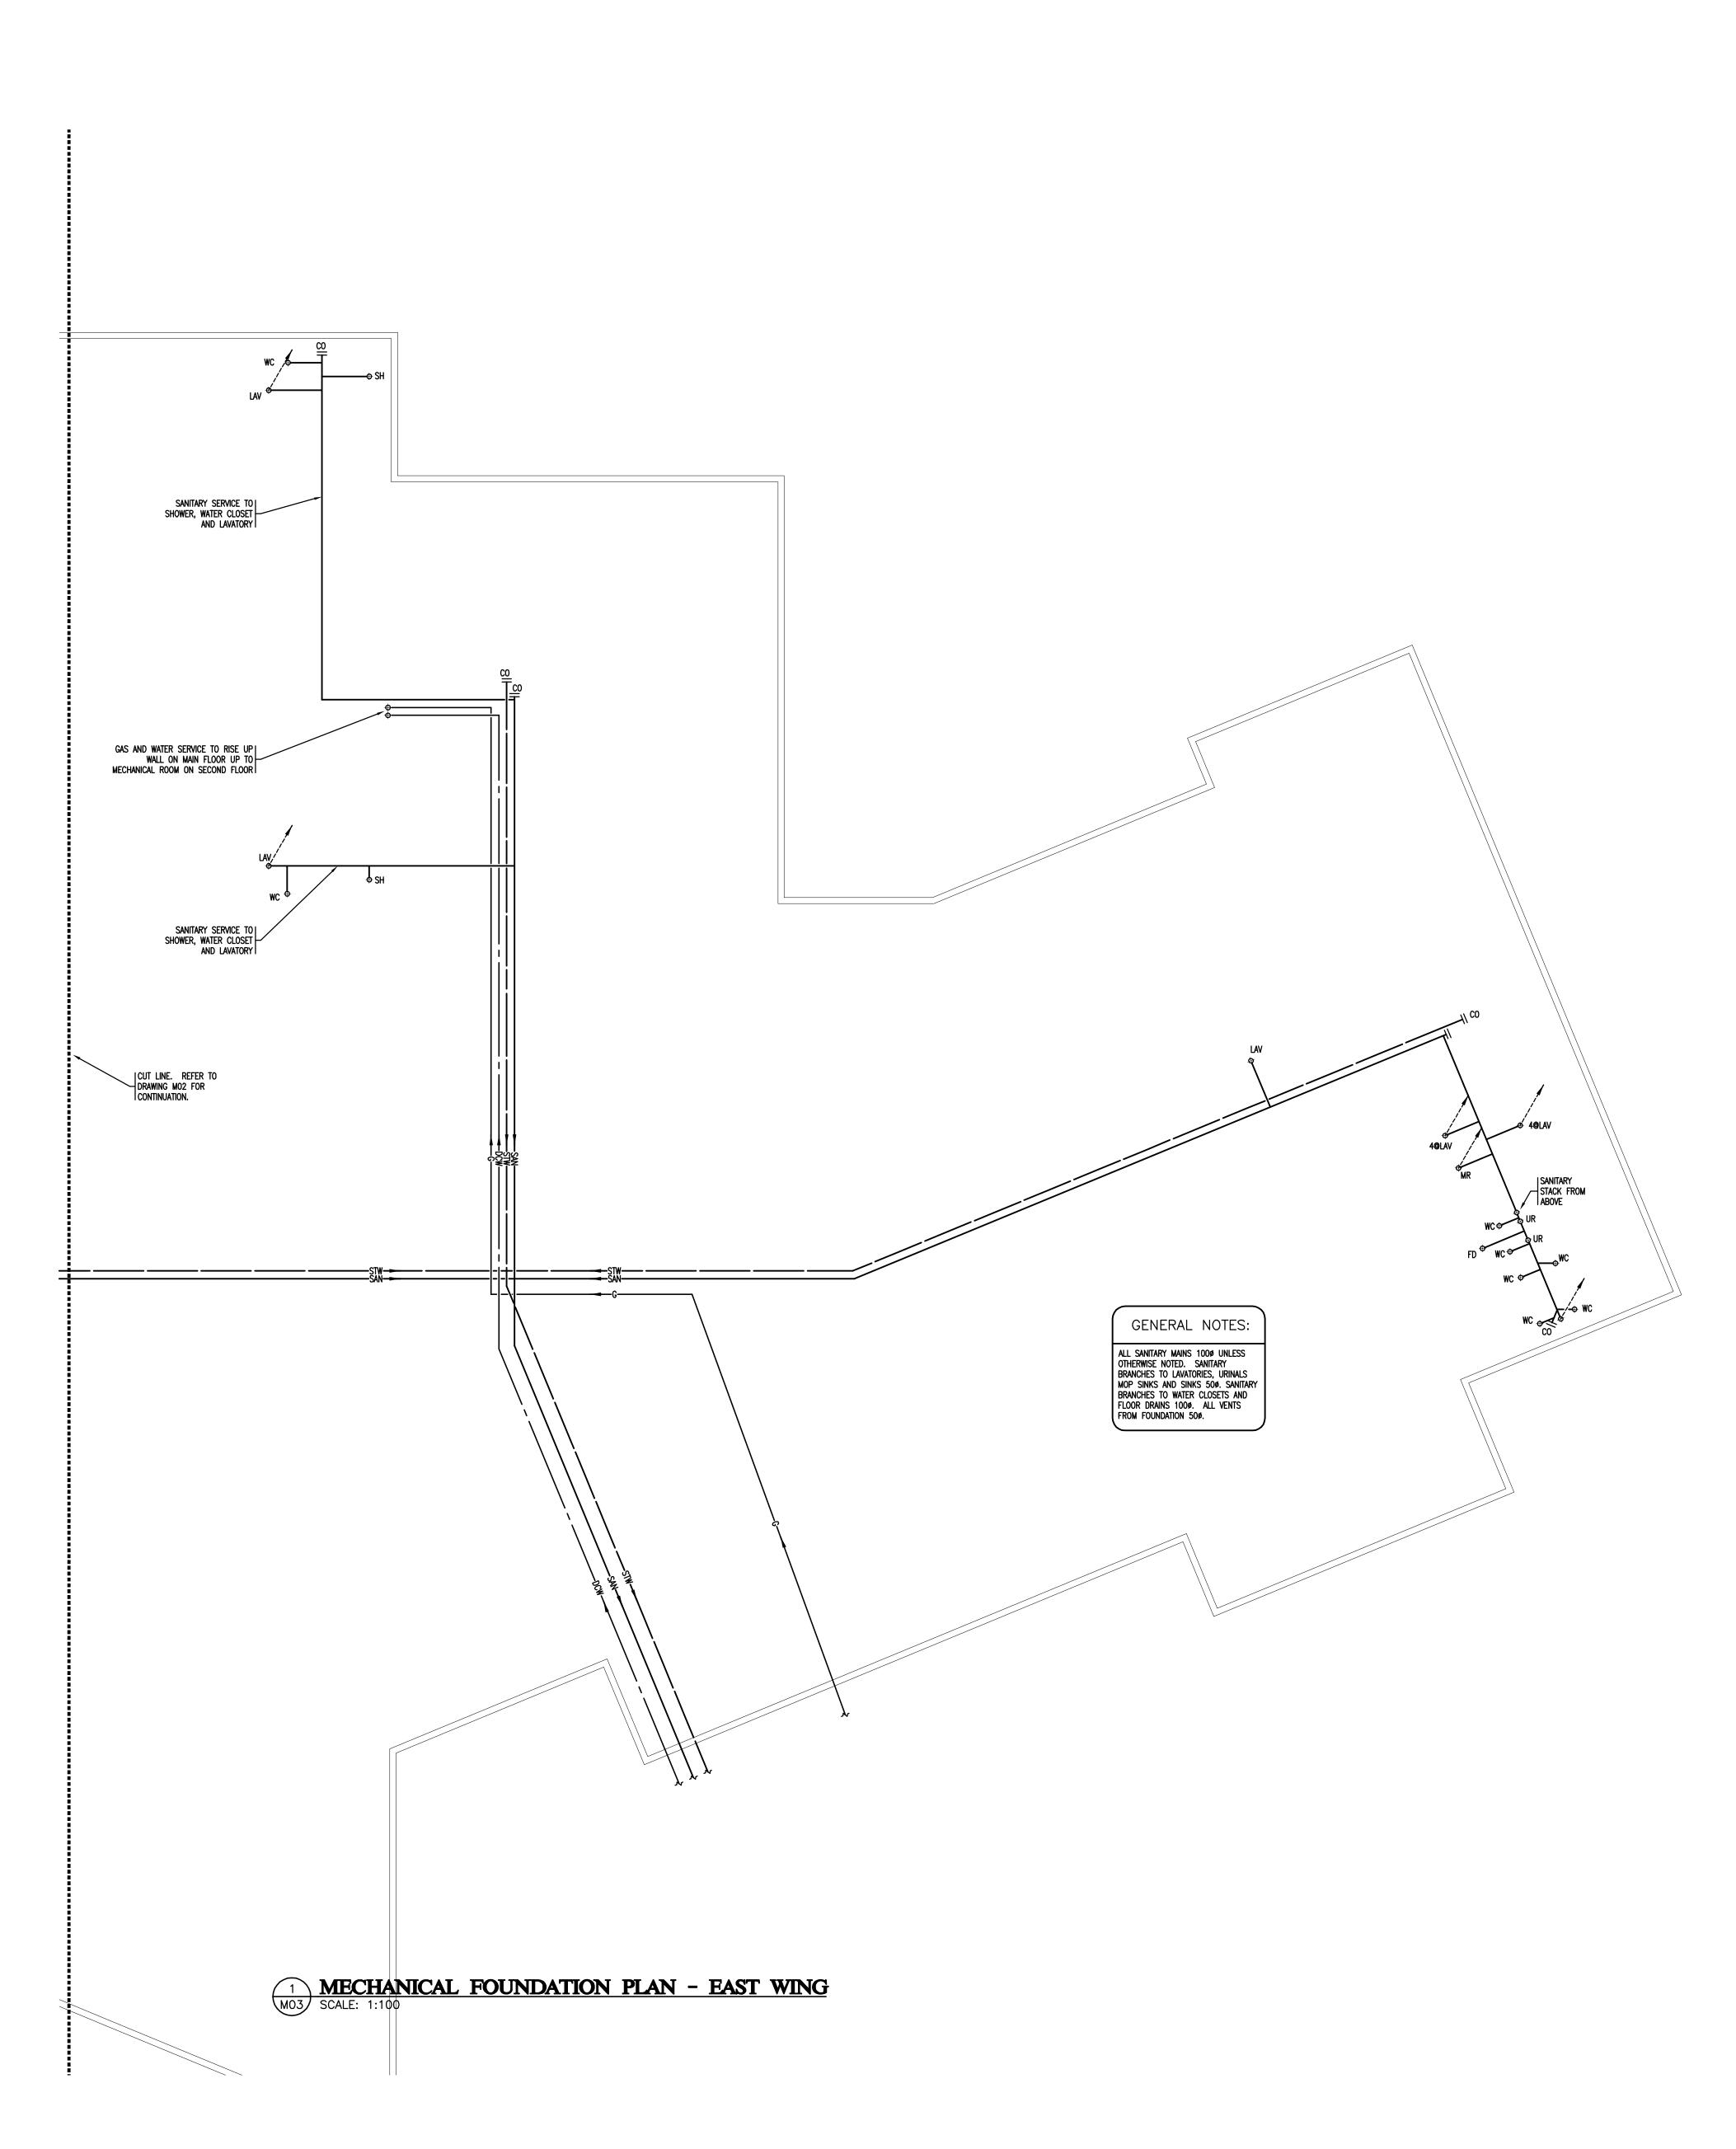



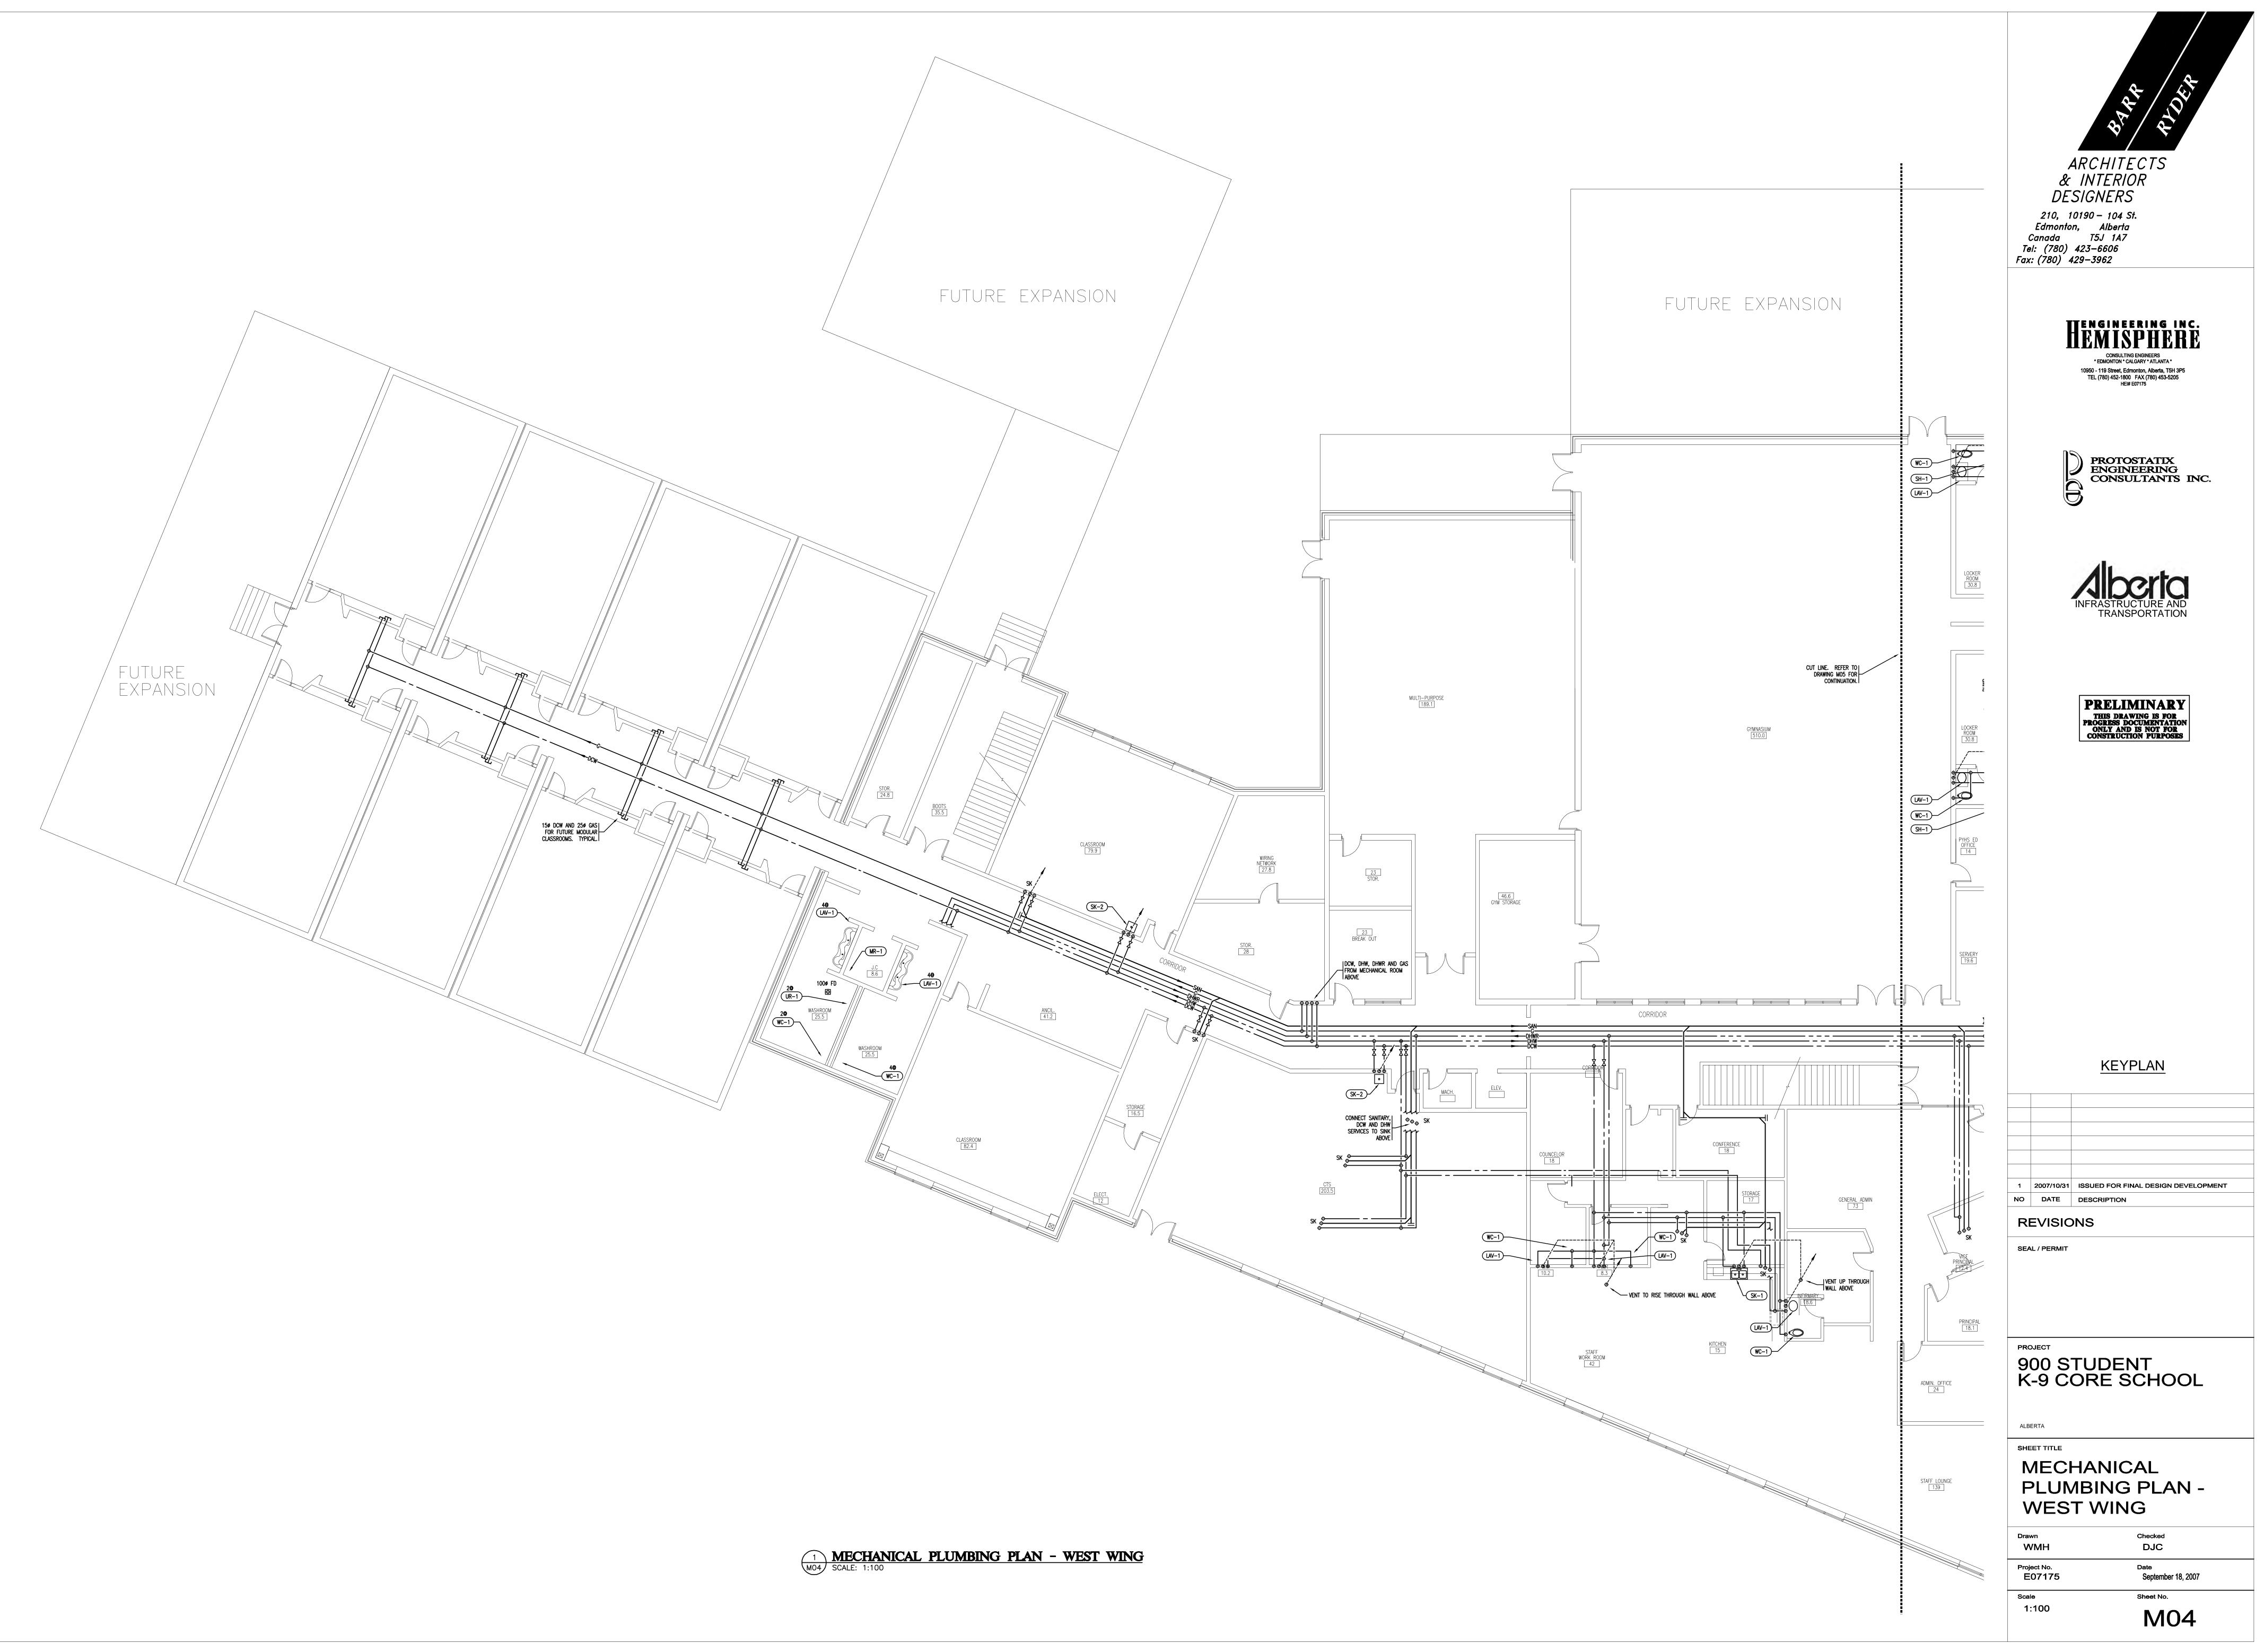







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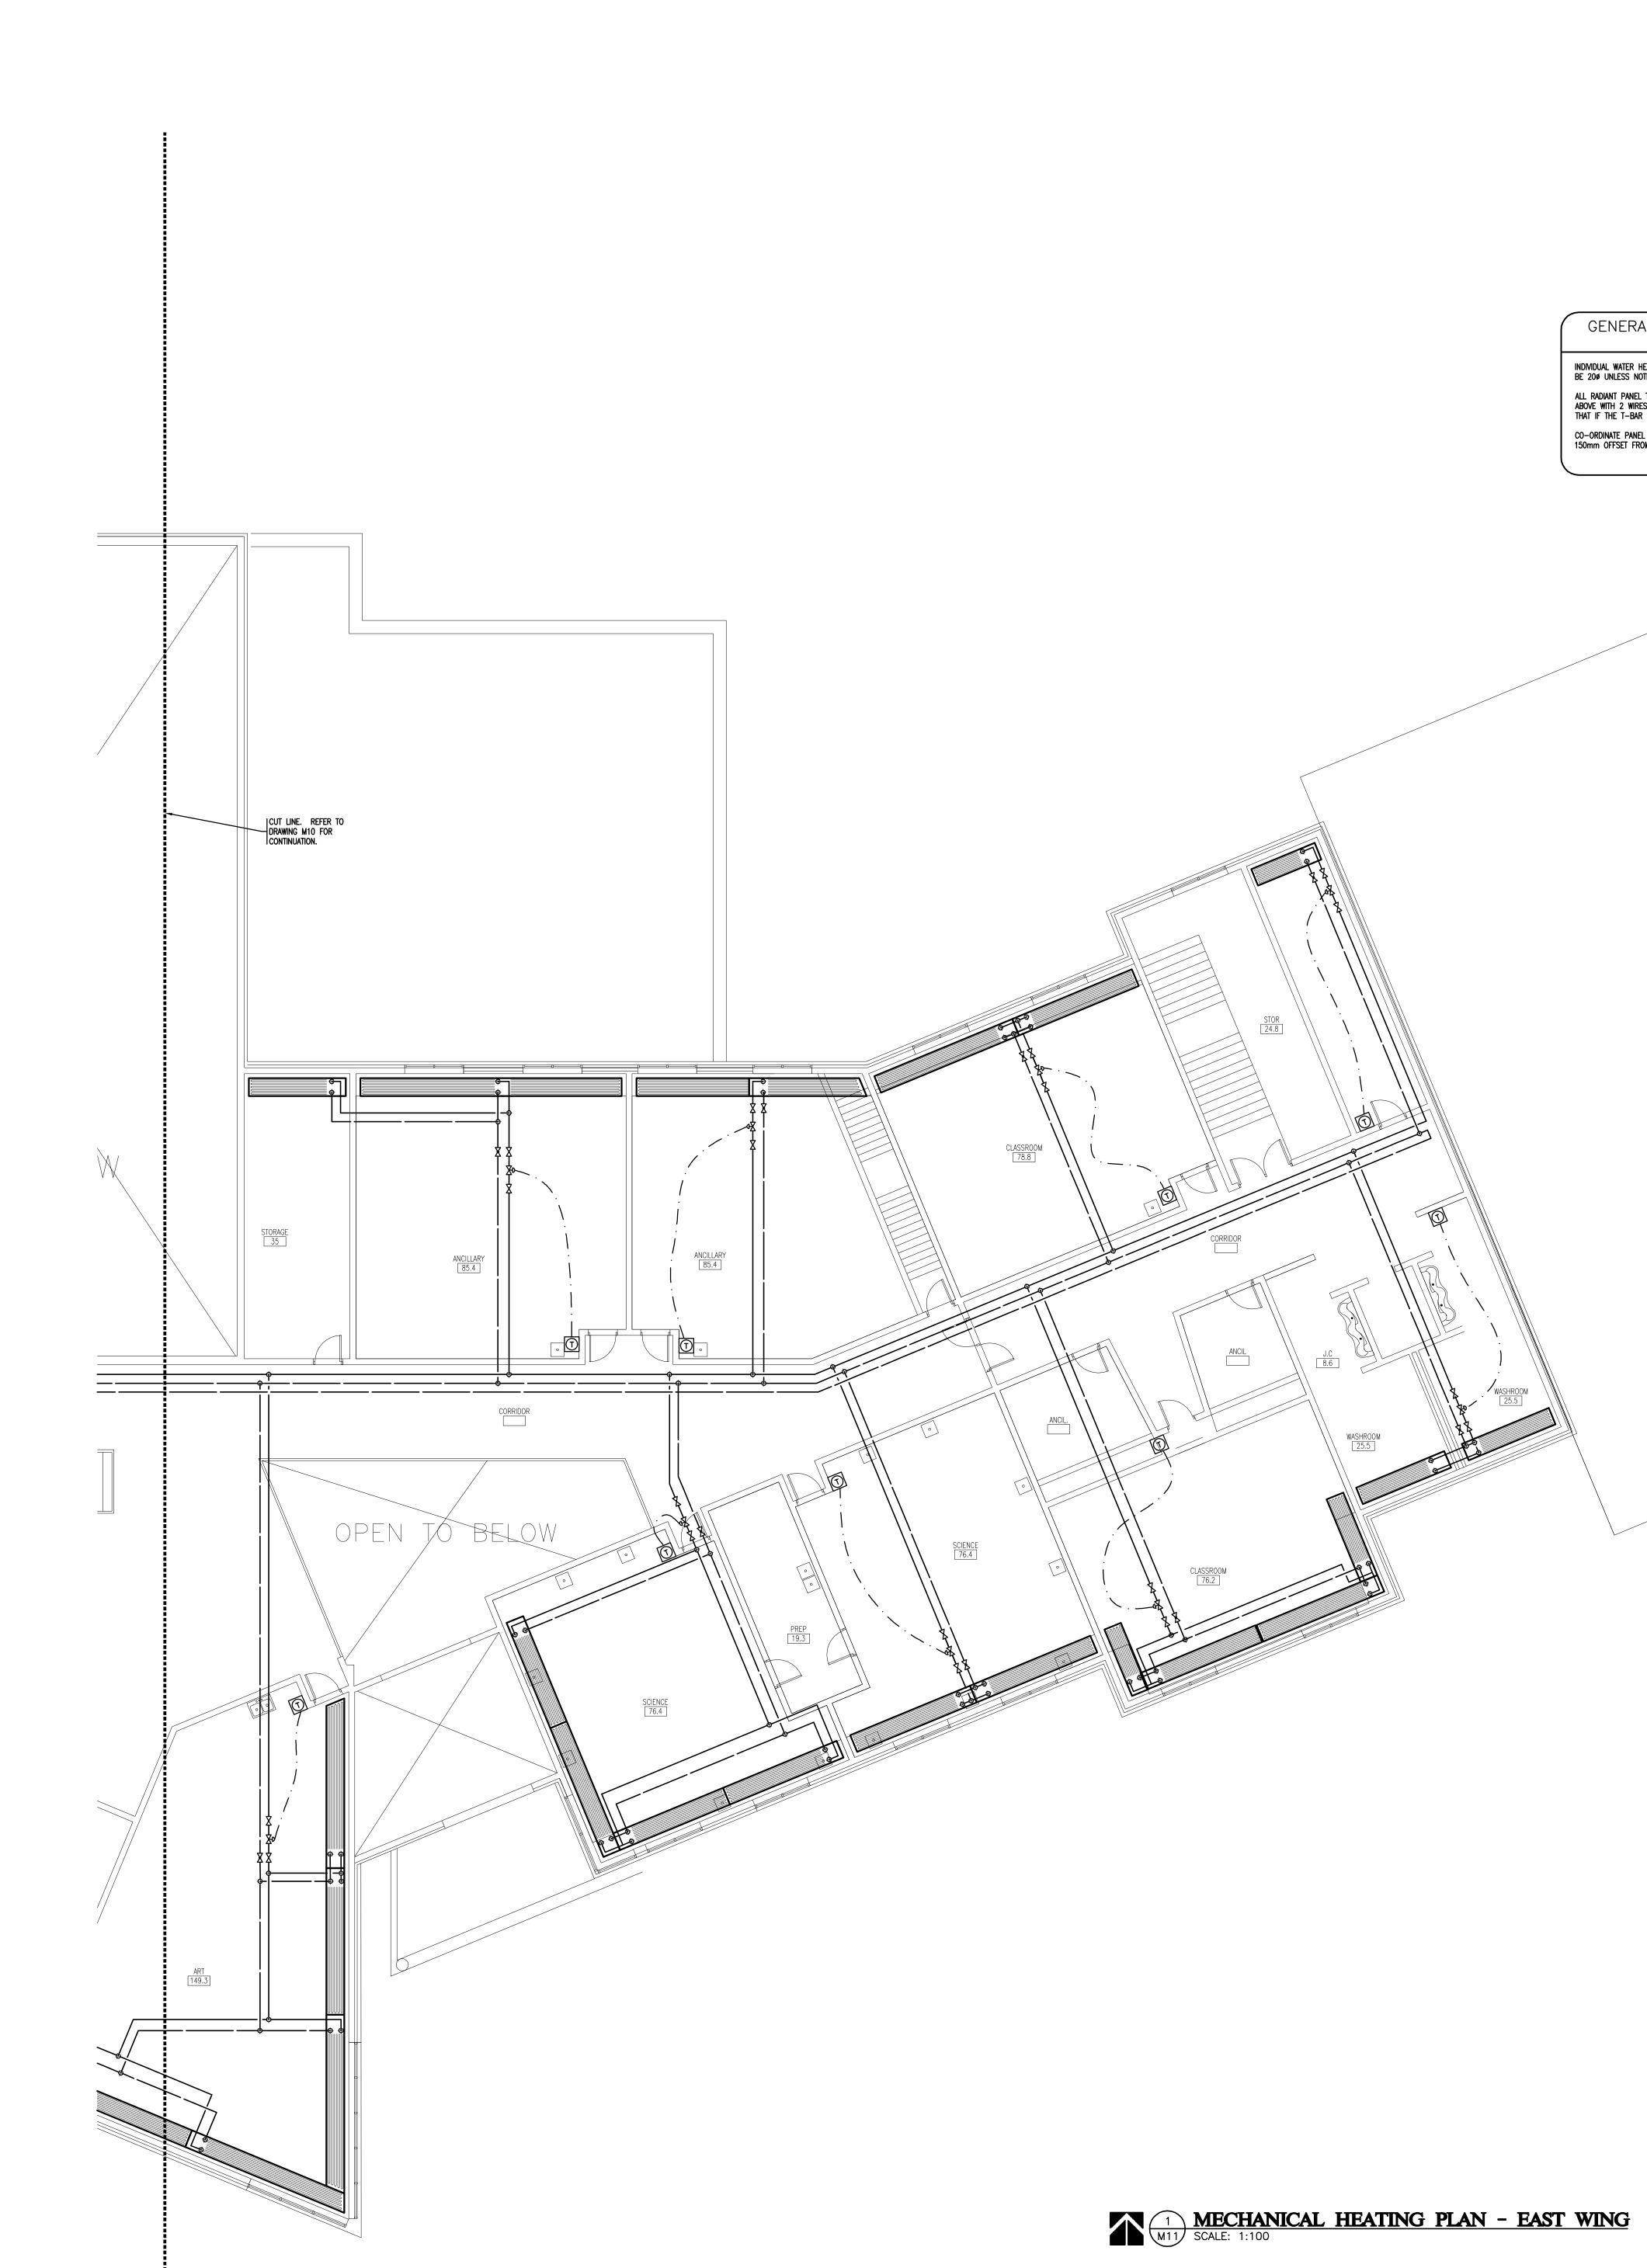
ARCHITECTS & INTERIOR DESIGNERS 210, 10190 - 104 St. Edmonton, Alberta Canada T5J 1A7 Tel: (780) 423-6606 Fax: (780) 429-3962	
<b>EXAMPLE 1</b> CONSULTING ENGINEERS *EDMONTON * CALGARY * ATLANTA * 10950 - 119 Street, Edmonton, Alberta, T5H 3P5 TEL (780) 452-1800 FAX (780) 453-5205 HEI# E07175	
PROTOSTATIX ENGINEERING CONSULTANTS INC.	
<b>Aberta</b> INFRASTRUCTURE AND TRANSPORTATION	
PRELIMINARY THIS DRAWING IS FOR PROGRESS DOCUMENTATION ONLY AND IS NOT FOR CONSTRUCTION PURPOSES	
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1       2007/10/31       ISSUED FOR FINAL DESIGN DEVELOPMENT         NO       DATE       DESCRIPTION         REVISIONS         SEAL / PERMIT	
PROJECT 900 STUDENT K-9 CORE SCHOOL	
ALBERTA SHEET TITLE	)
MECHANICAL SECOND FLOOR PLUMBING PLAN - EAST WING	
FLOOR PLUMBING	








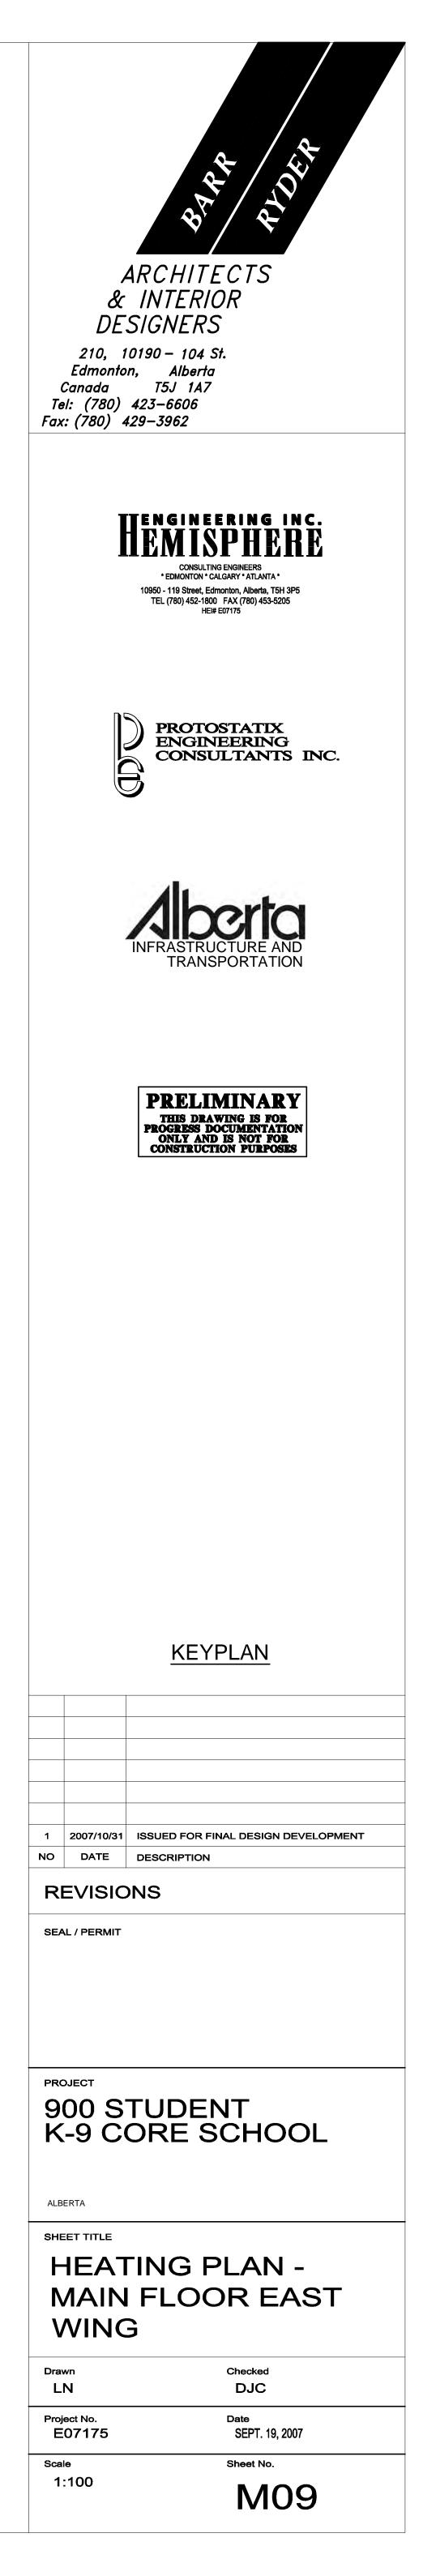

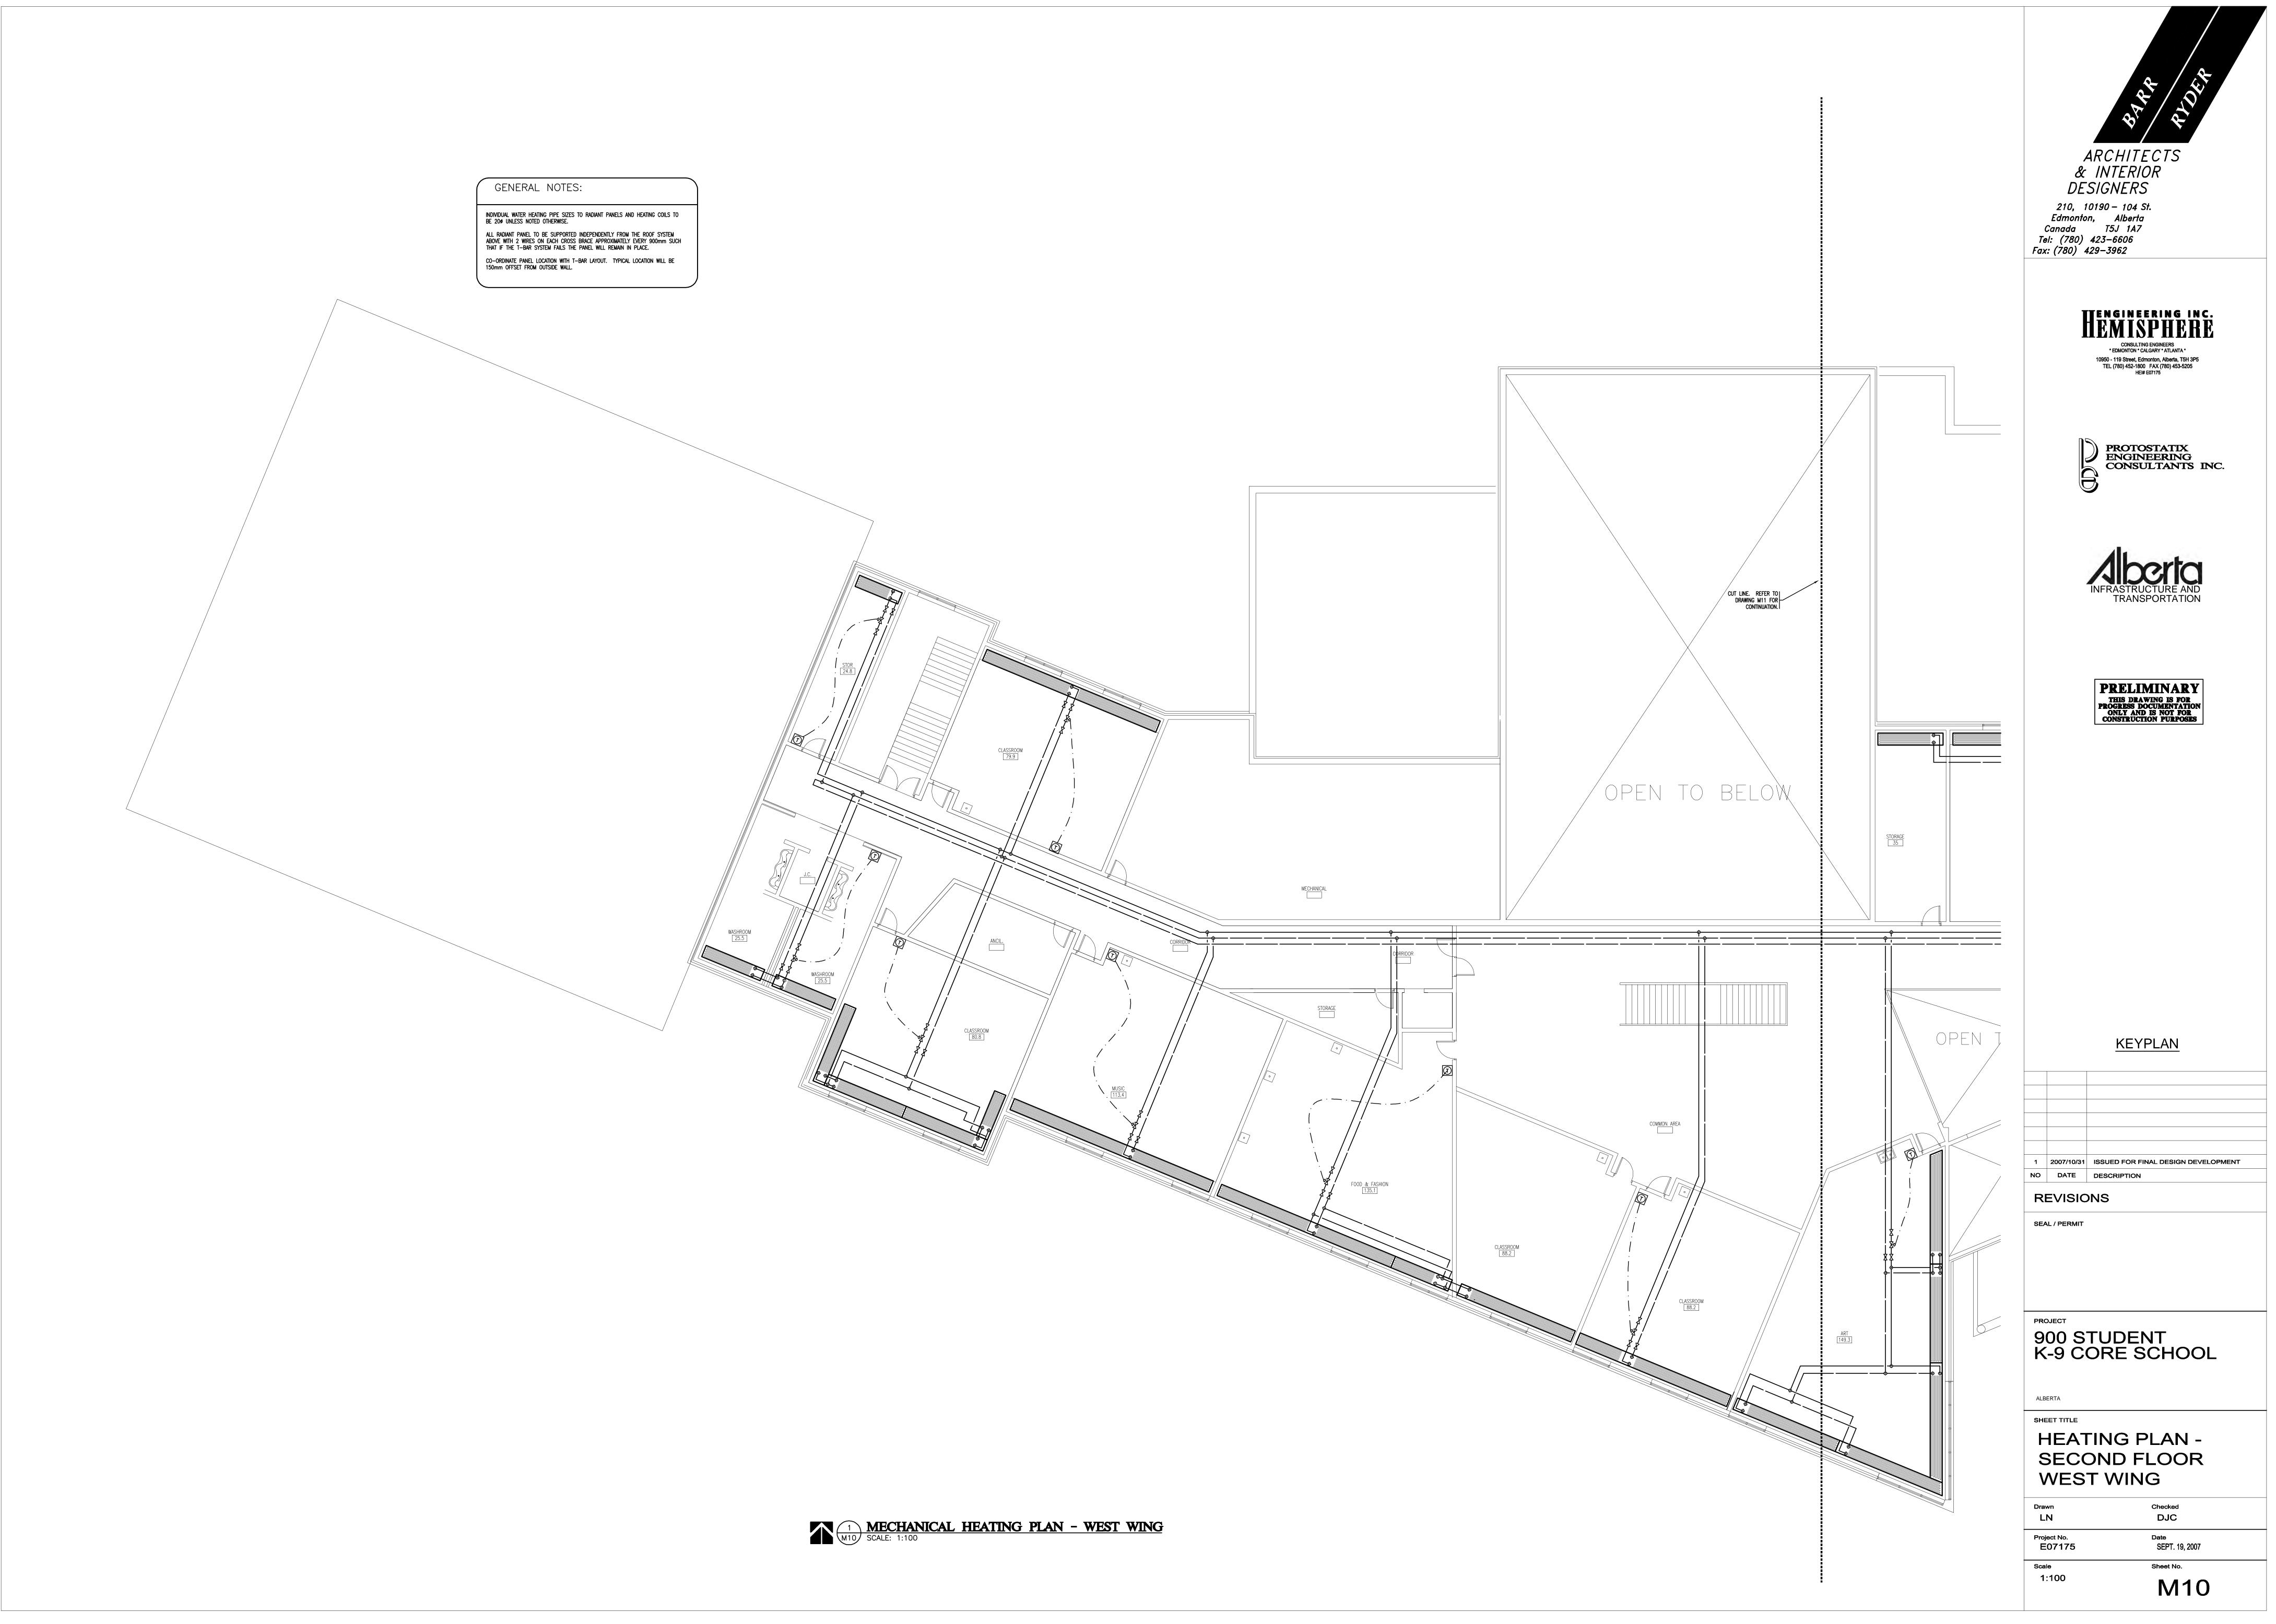


GENERAL NOTES:

INDIVIDUAL WATER HEATING PIPE SIZES TO RADIANT PANELS AND HEATING COILS TO BE 200 UNLESS NOTED OTHERWISE. ALL RADIANT PANEL TO BE SUPPORTED INDEPENDENTLY FROM THE ROOF SYSTEM ABOVE WITH 2 WIRES ON EACH CROSS BRACE APPROXIMATELY EVERY 900mm SUCH THAT IF THE T-BAR SYSTEM FAILS THE PANEL WILL REMAIN IN PLACE. CO-ORDINATE PANEL LOCATION WITH T-BAR LAYOUT. TYPICAL LOCATION WILL BE 150mm OFFSET FROM OUTSIDE WALL.

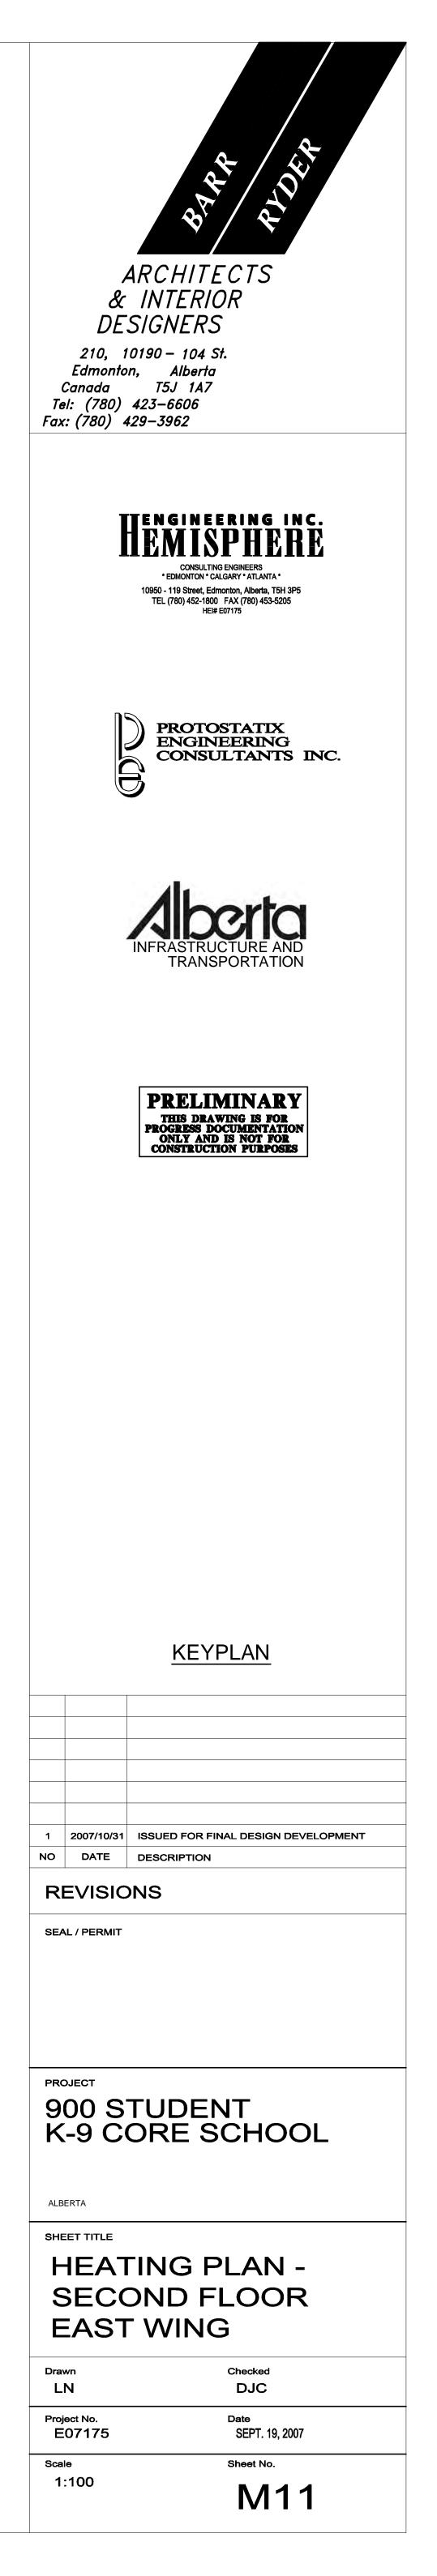





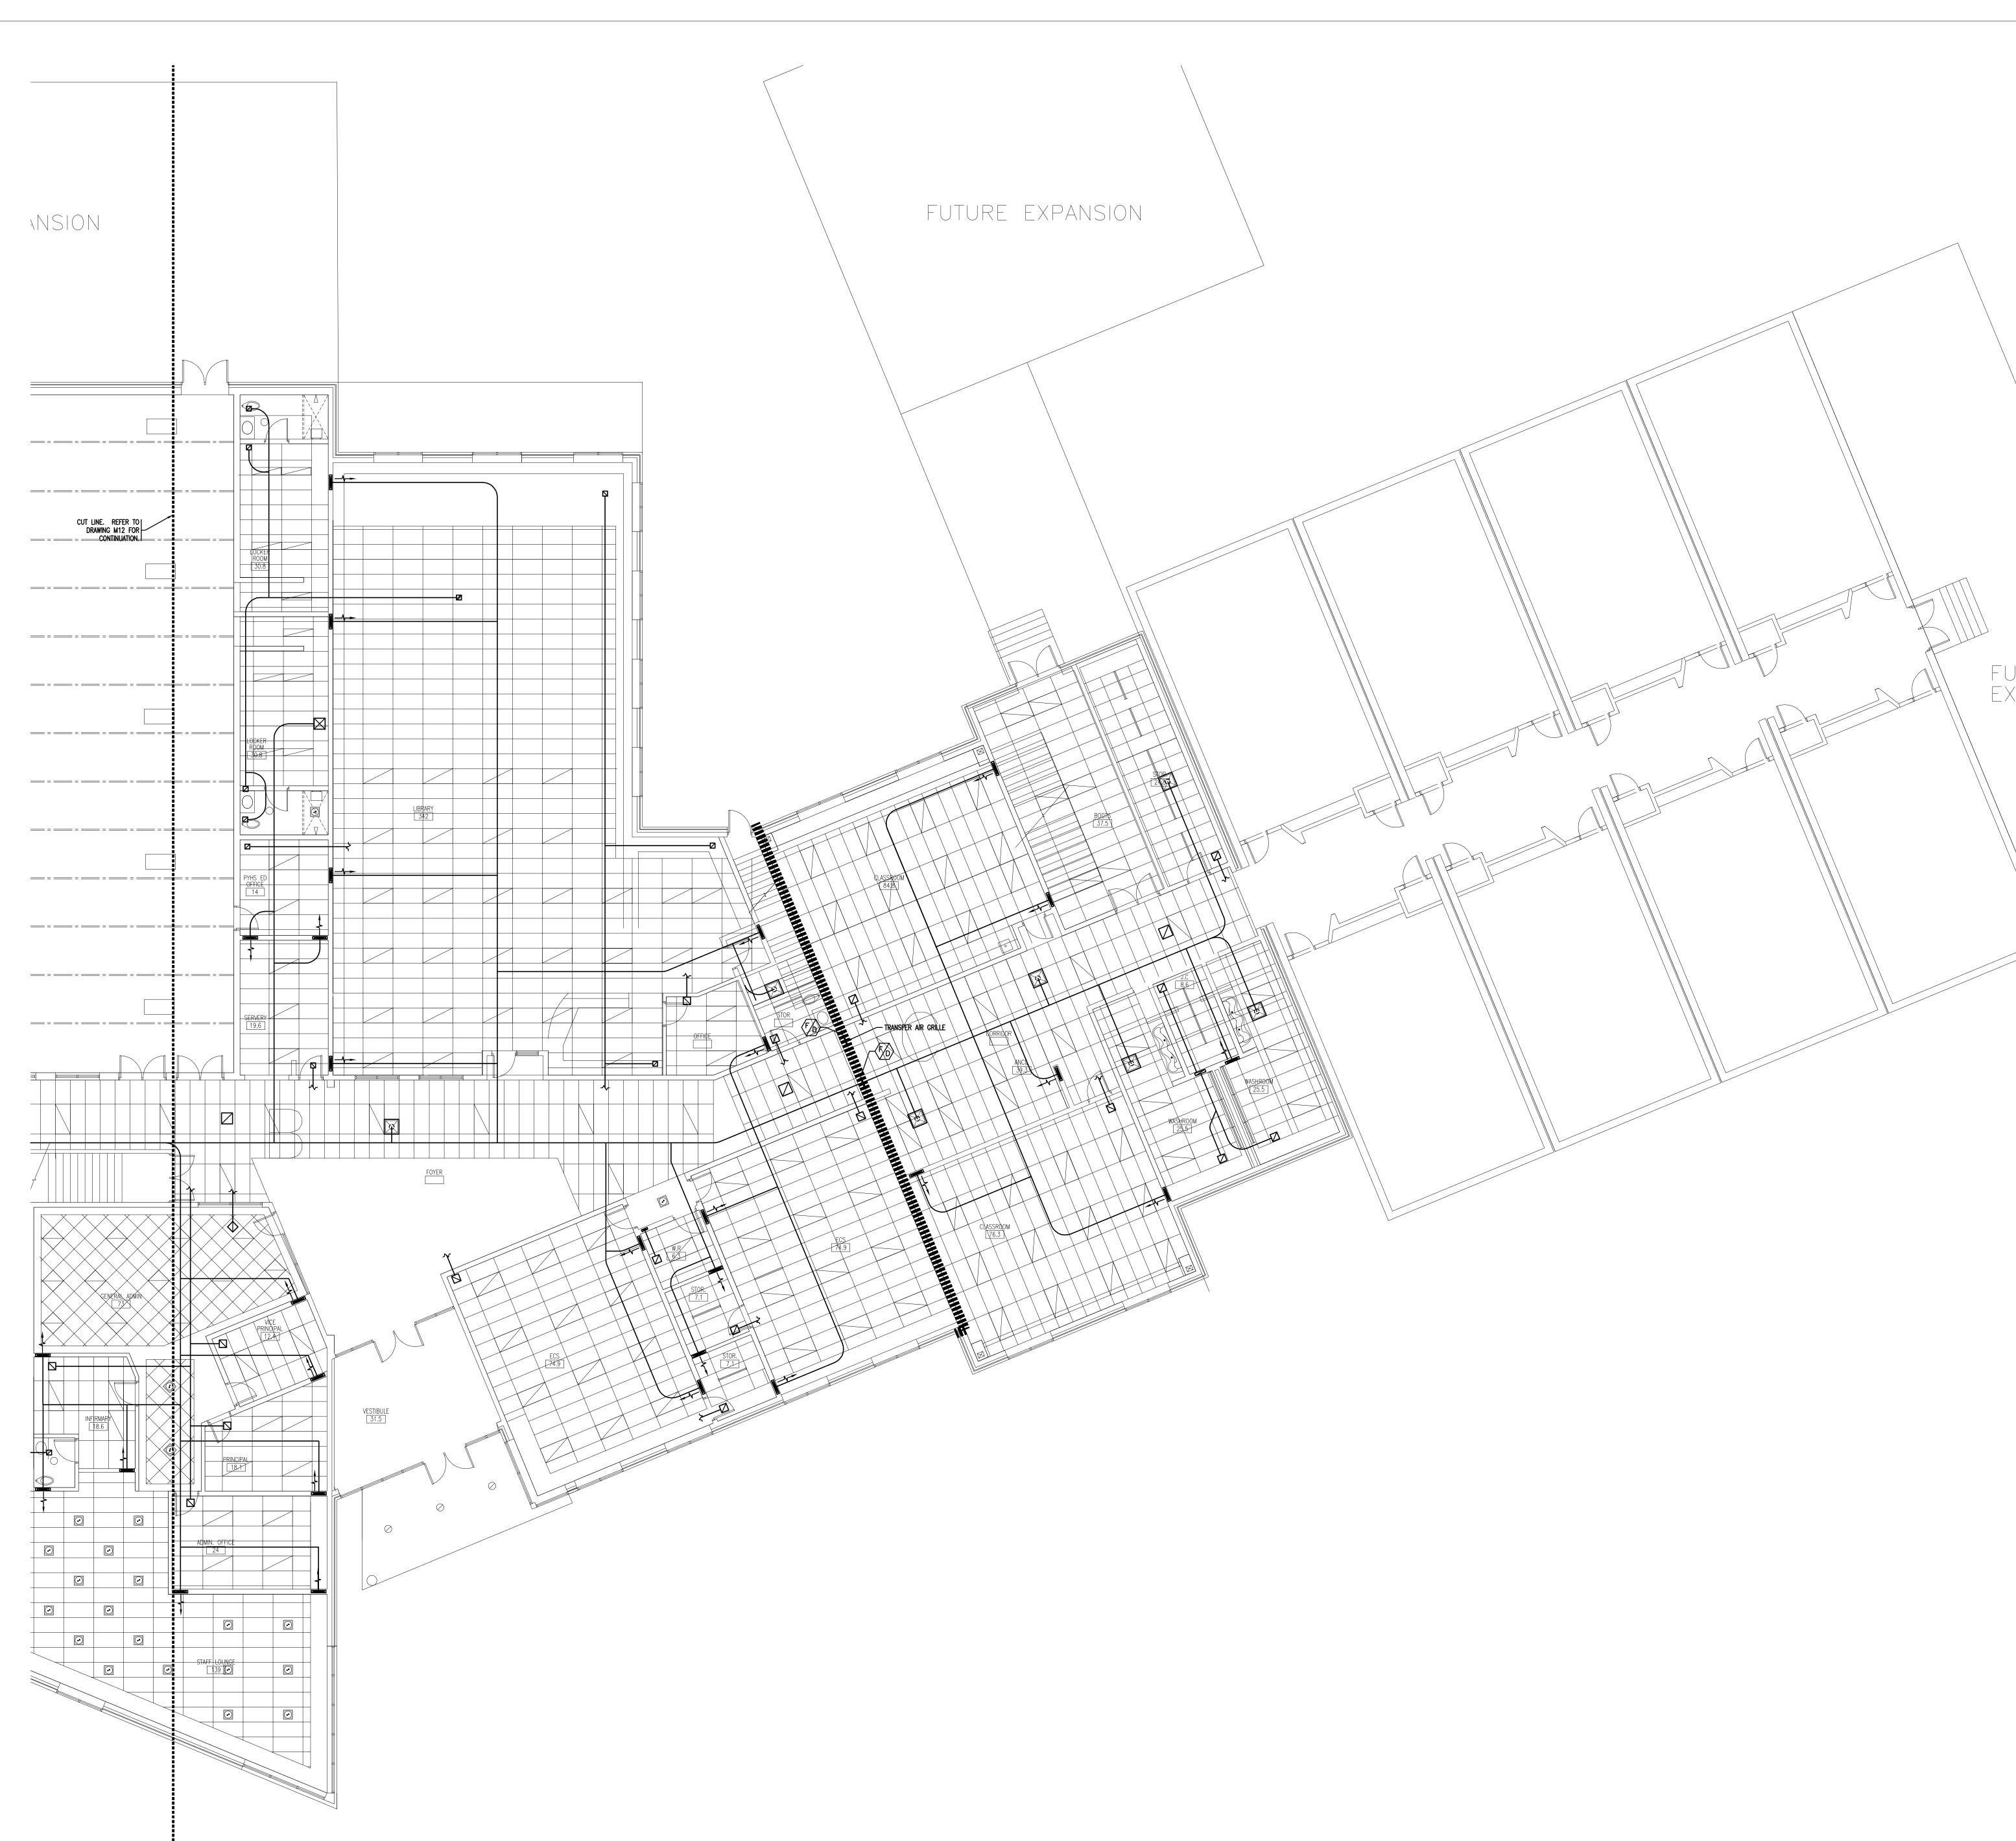


	ARCHITECTS & INTERIOR DESIGNERS 210, 10190 – 104 St. Edmonton, Alberta Canada T5J 1A7 Tel: (780) 423–6606 Fax: (780) 429–3962
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	PROTOSTATIX ENGINEERING CONSULTANTS INC.
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	PROJECT 900 STUDENT K-9 CORE SCHOOL ALBERTA SHEET TITLE VENTILATION PLAN MAIN FLOOR B.M.R. DJC Project No. E07175 Date SCHE Steet No. 1:100 Sheet No. M.13



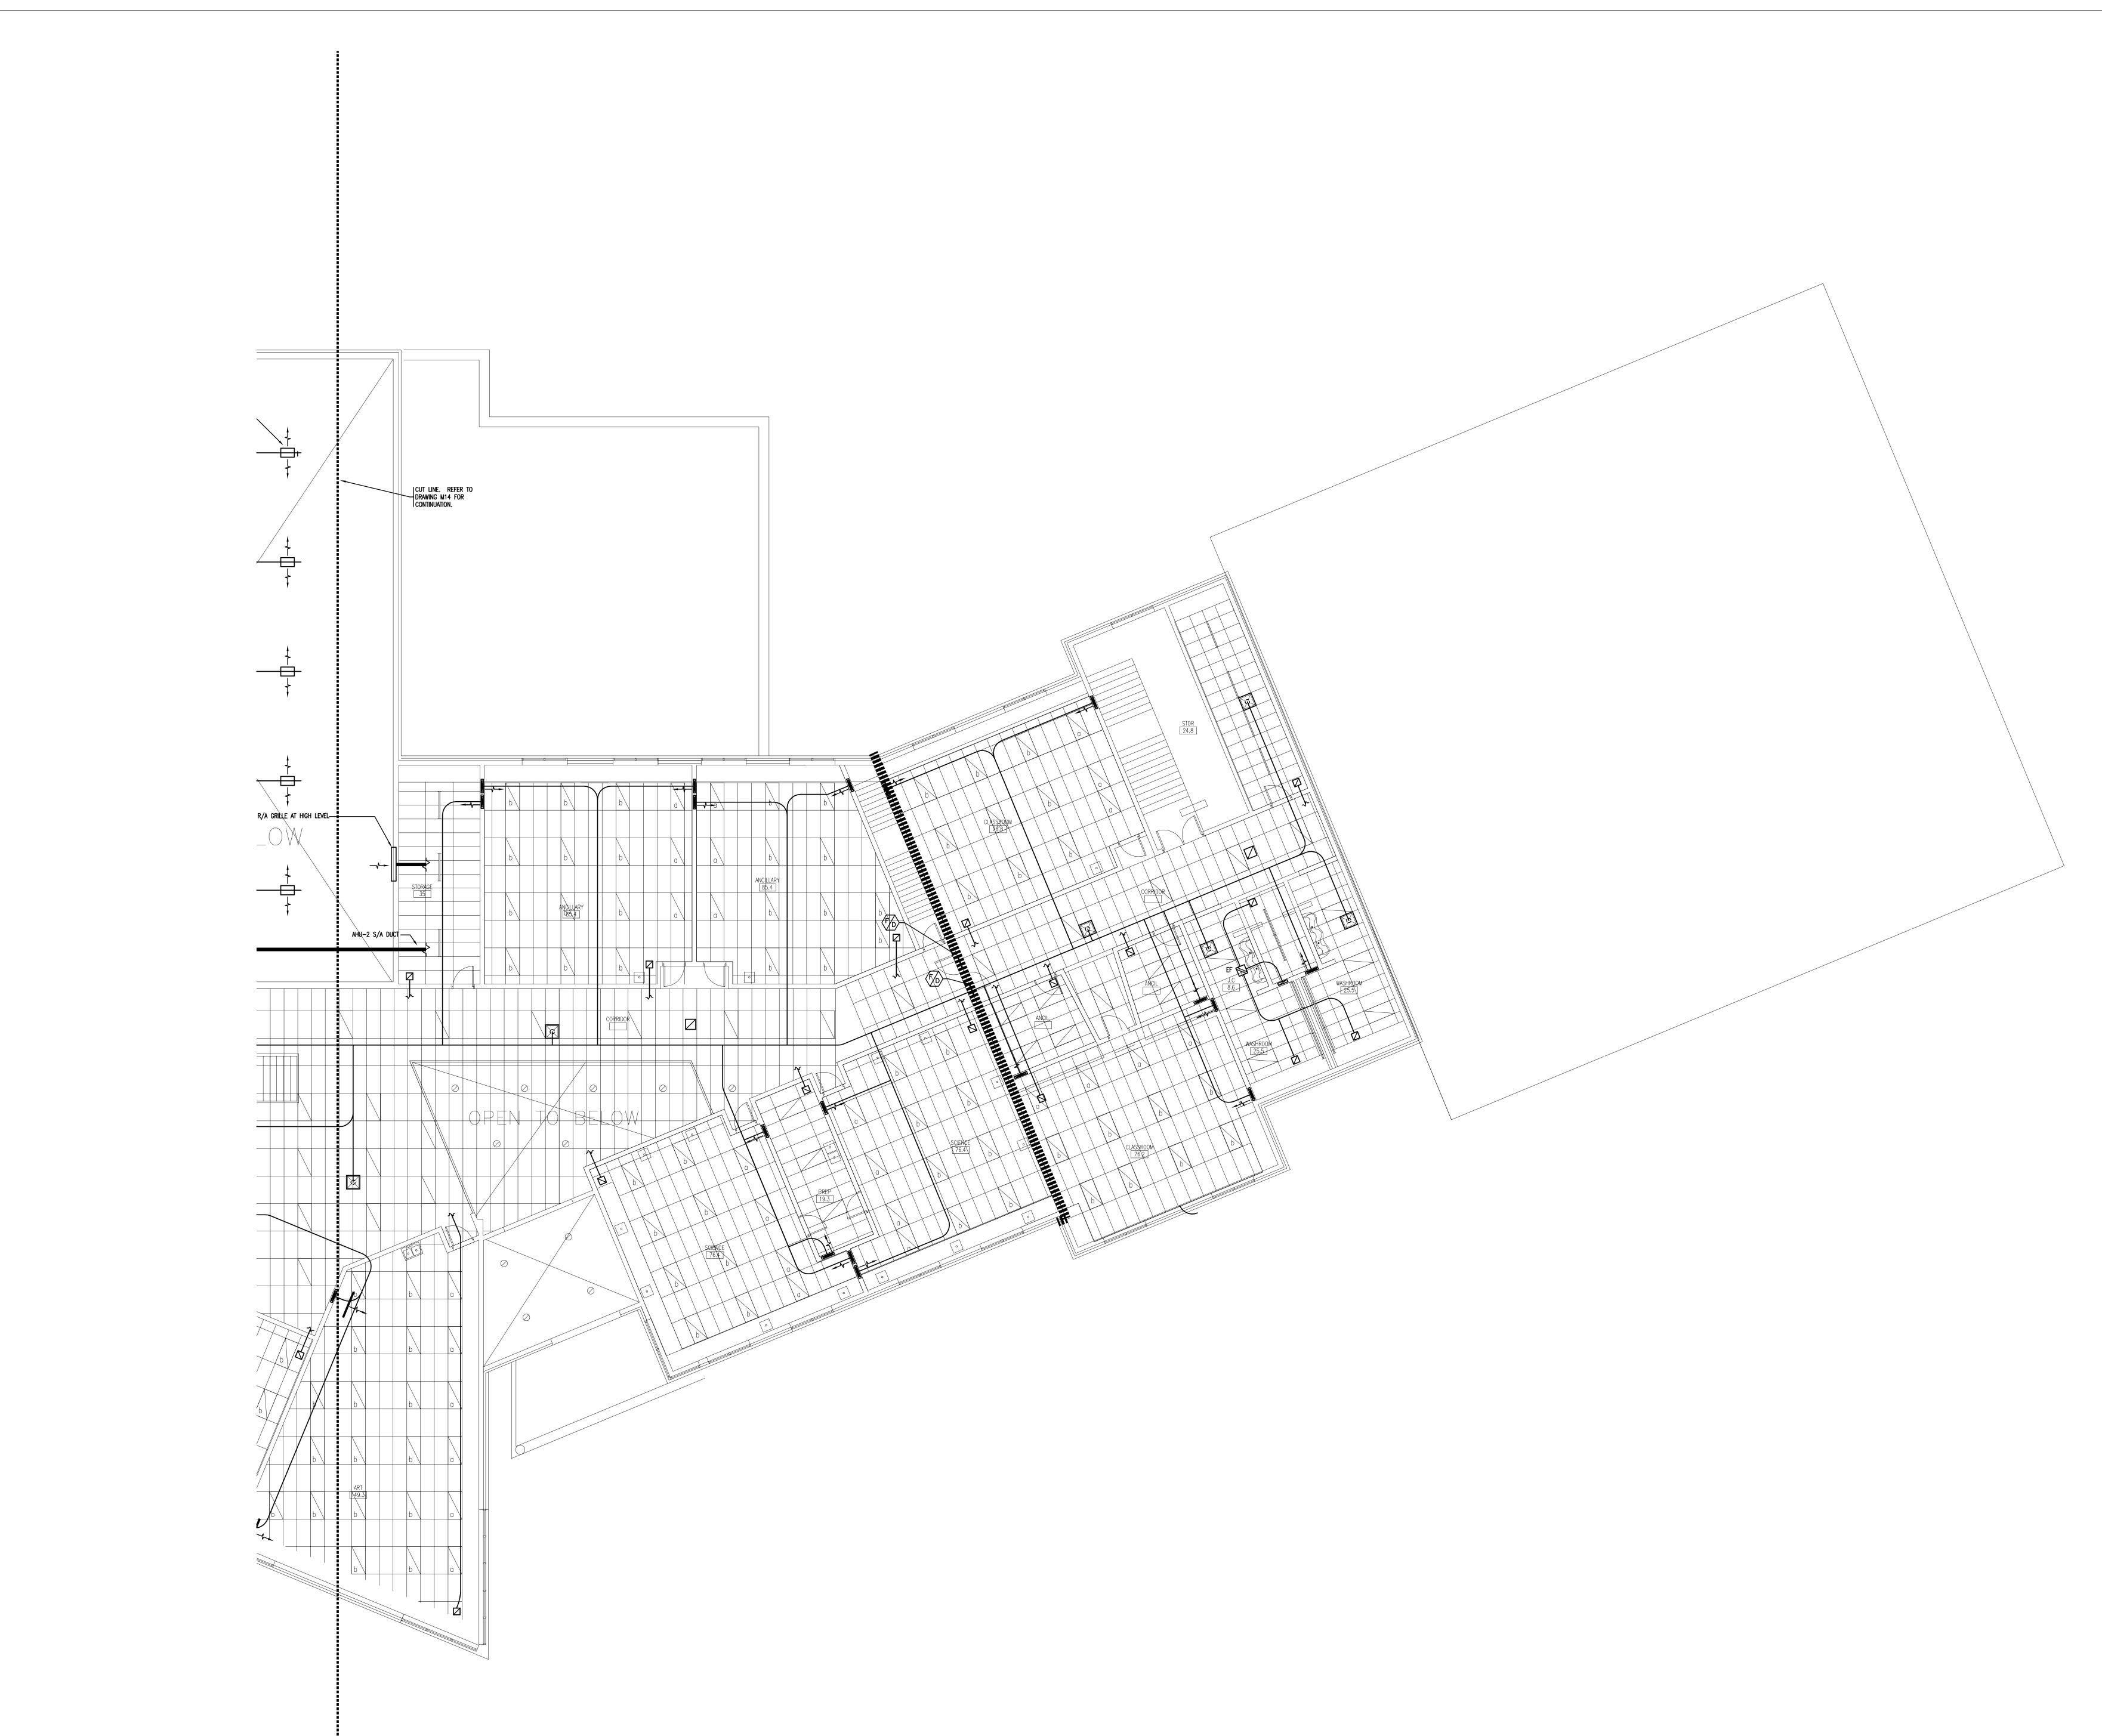

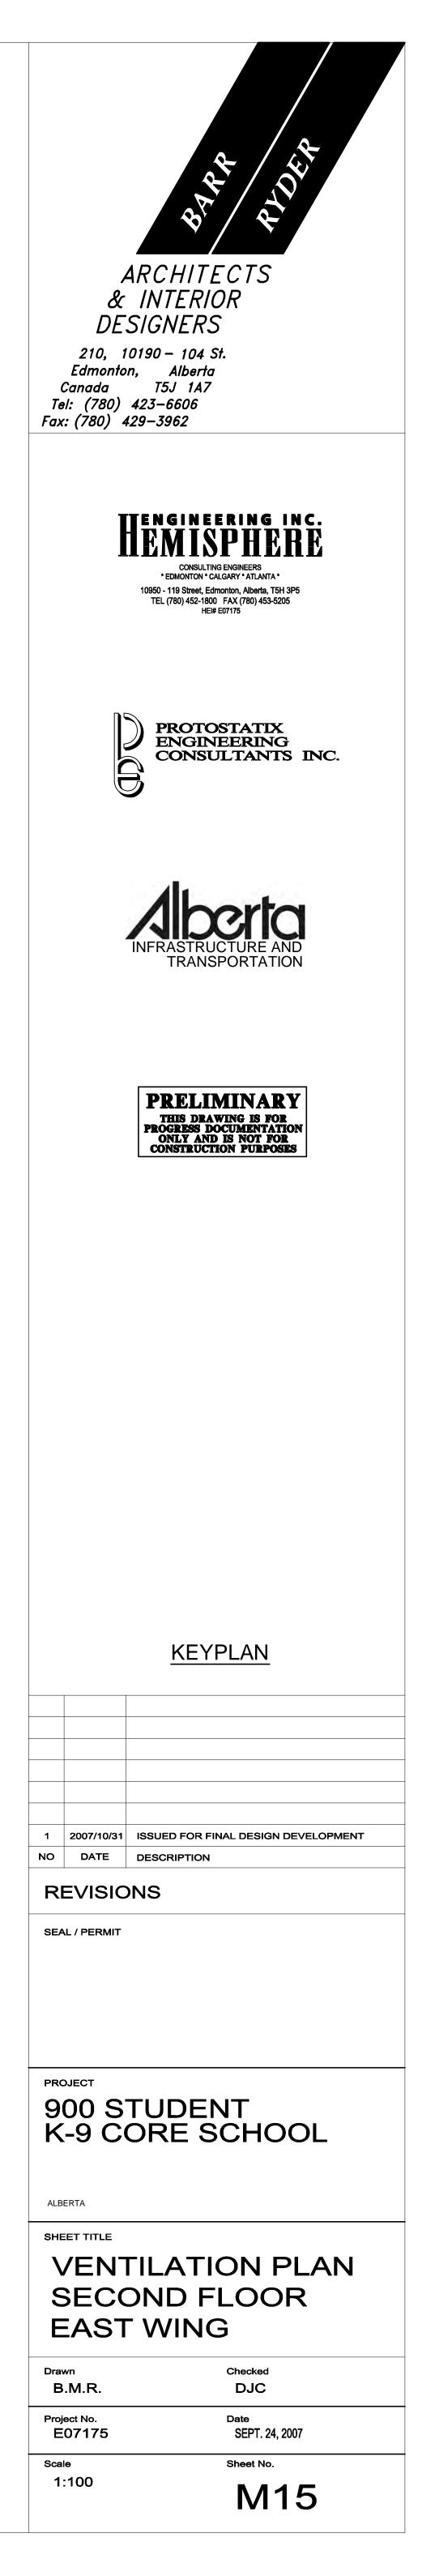




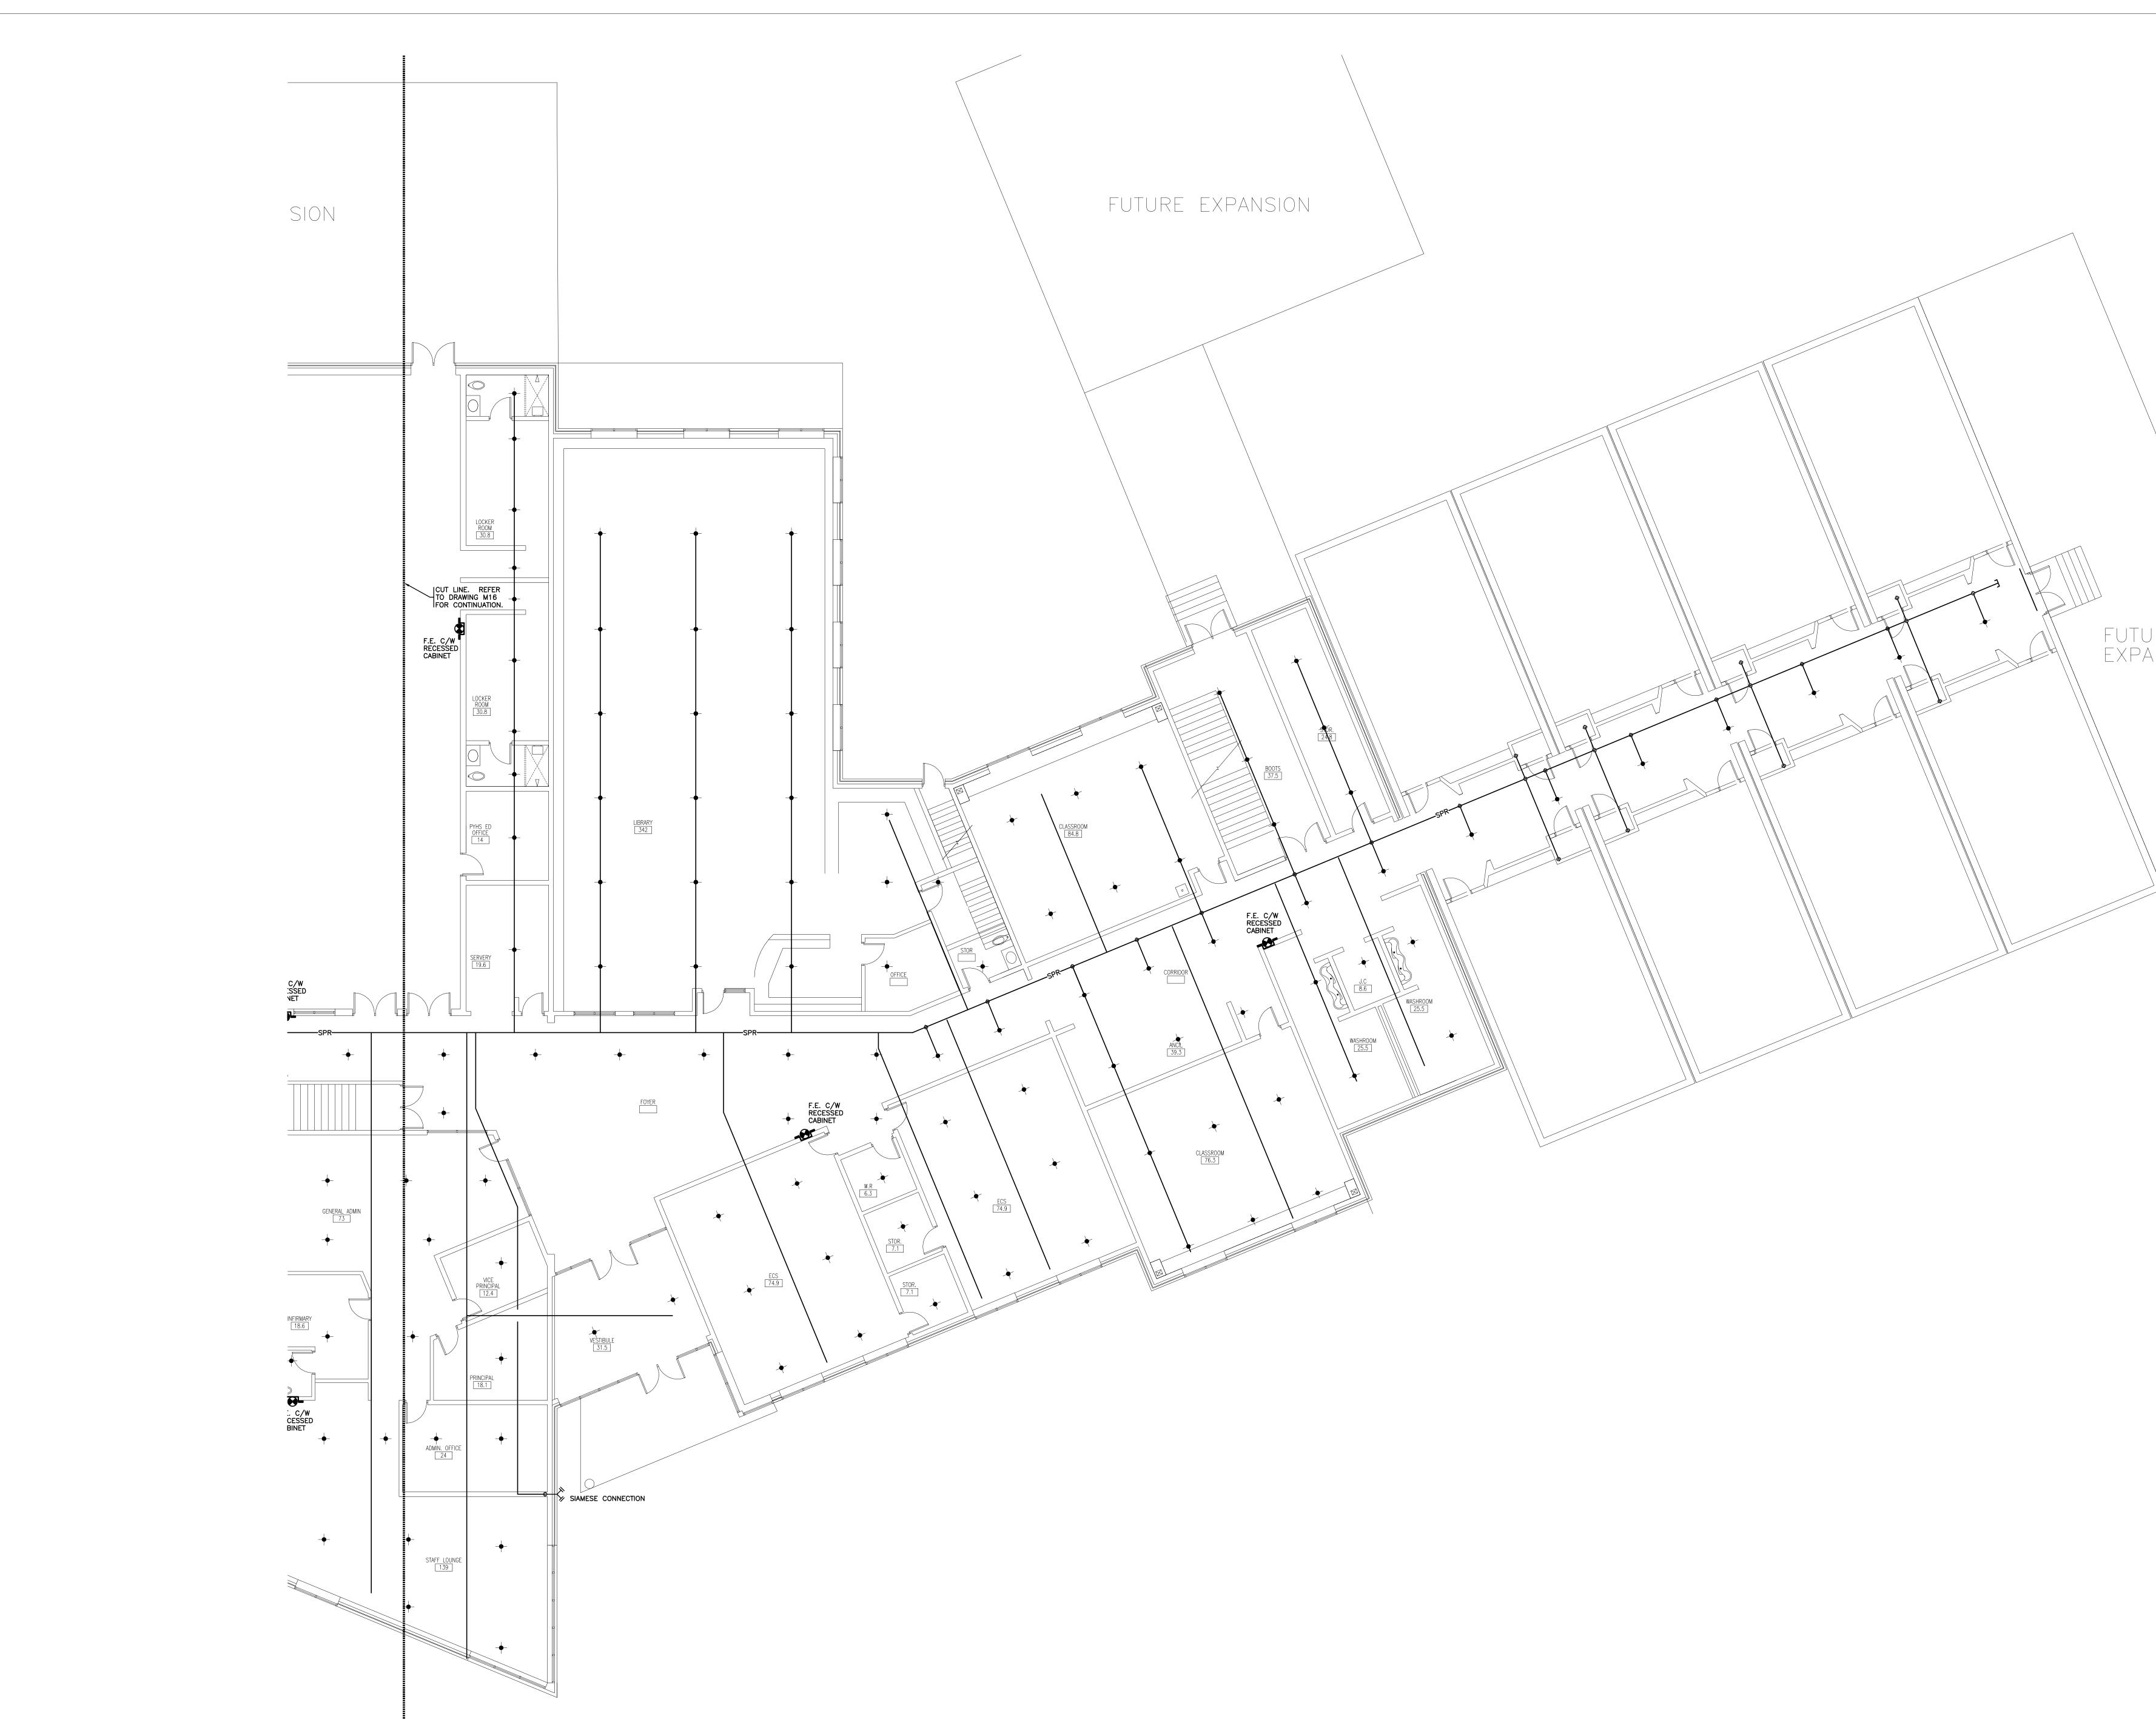


	ARCHITECTS & INTERIOR DESIGNERS 210, 10190 - 104 St. Edmonton, Alberta Canada T5J 1A7 Tel: (780) 423-6606 Fax: (780) 429-3962
	<b>EXAMPLE 1</b> Street, Edmonton, Alberta, T5H 3P5 TEL (780) 452-1800 FAX (780) 453-5205 HEI# E07175
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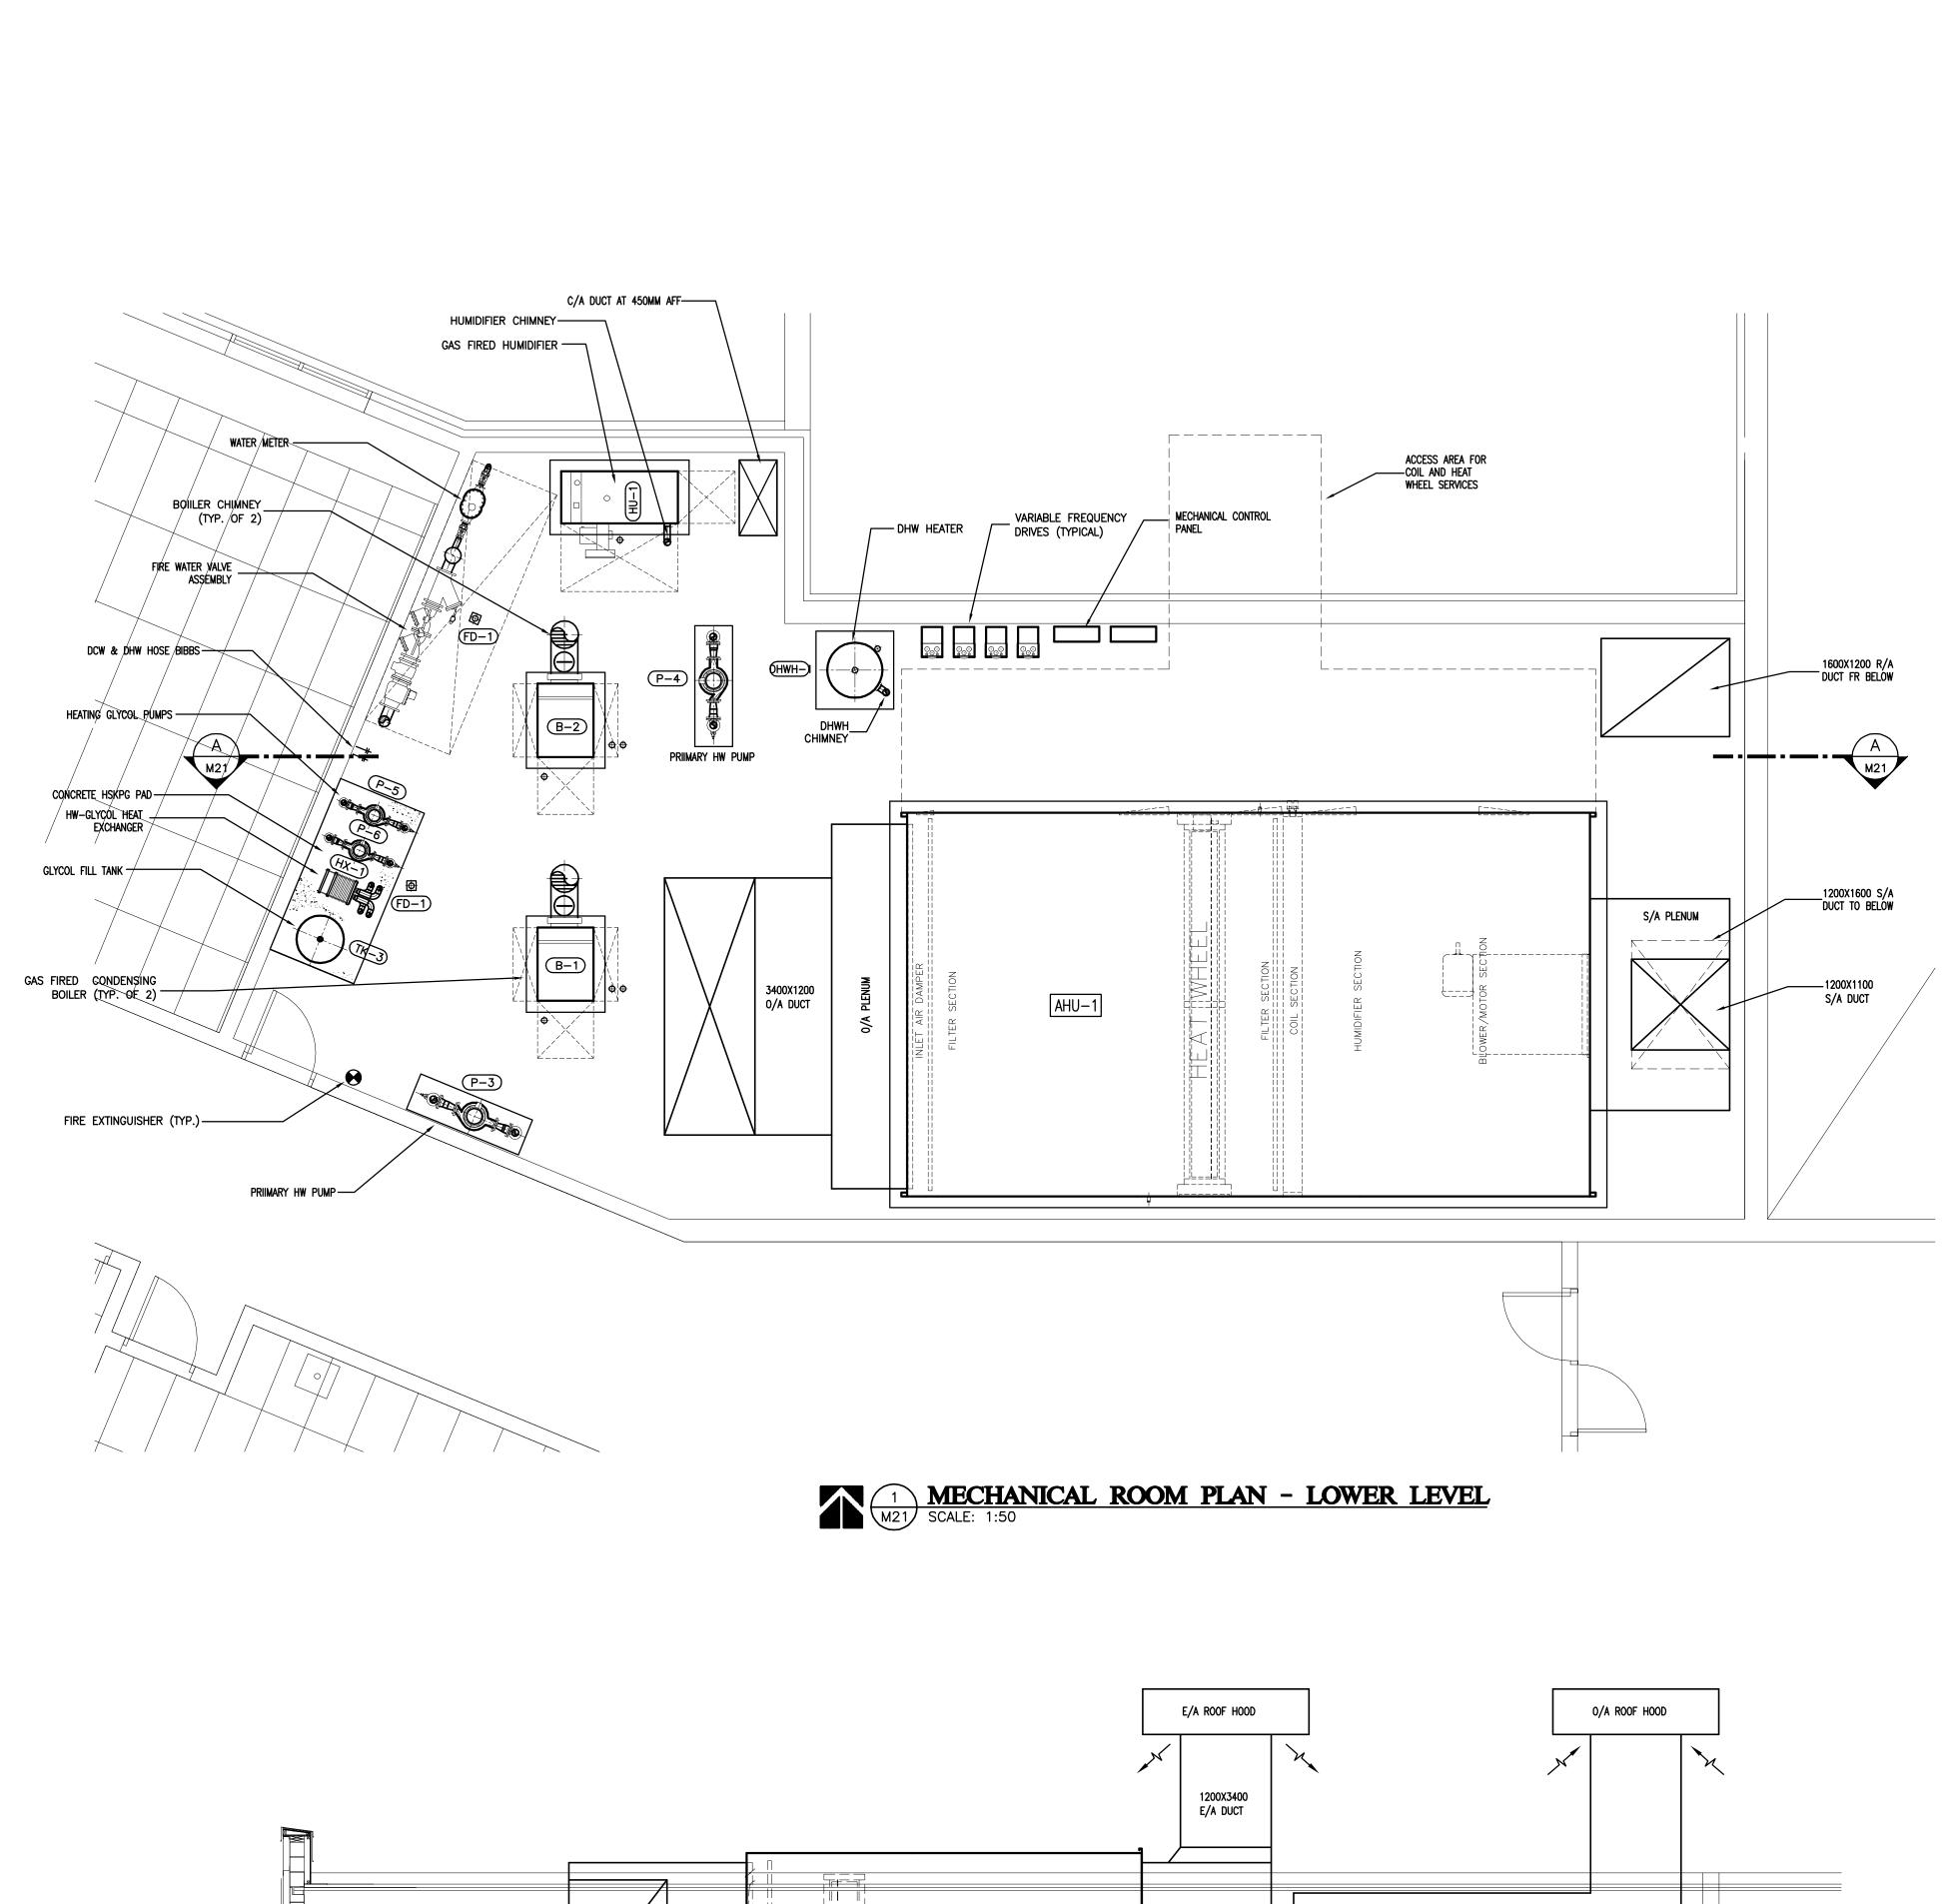





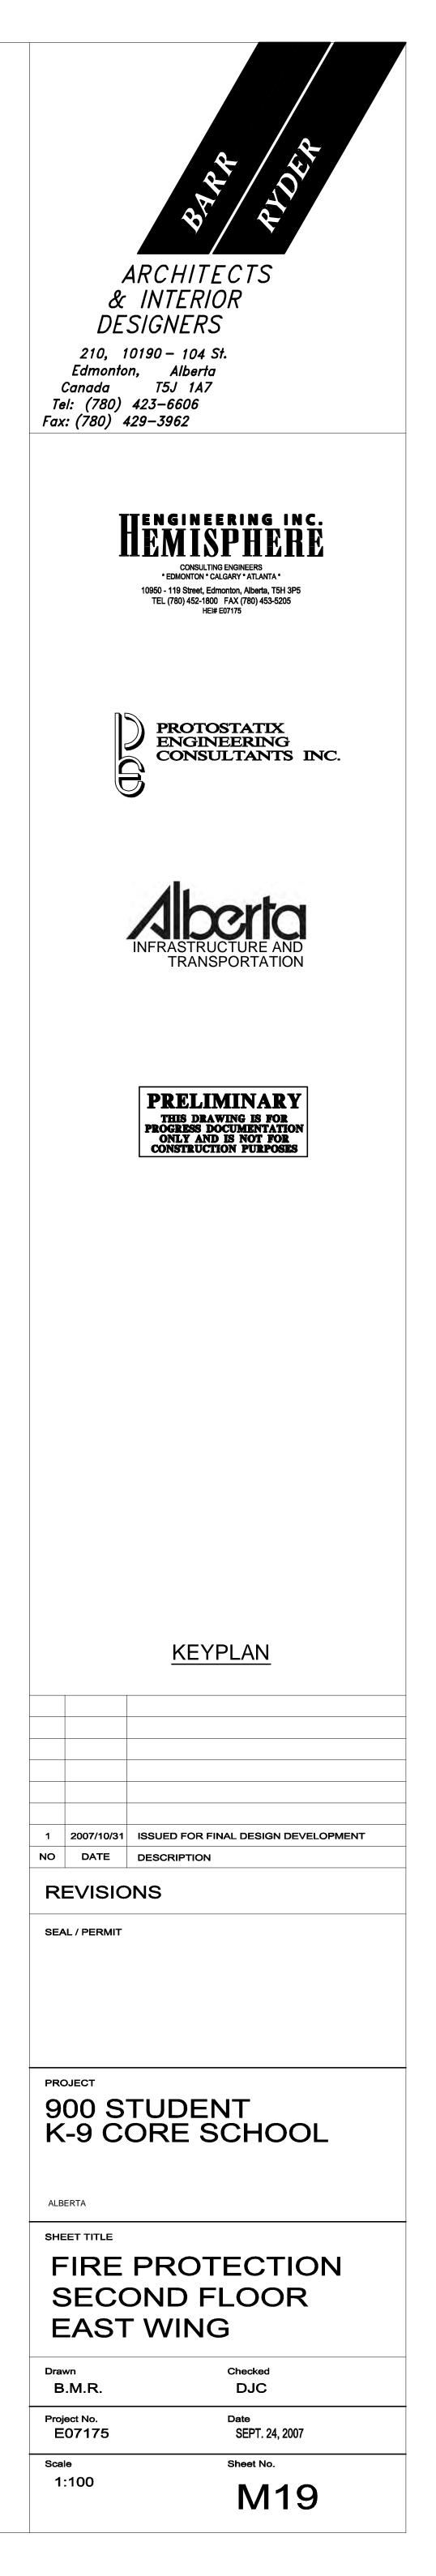


1 TYPICAL PORTABLE CLASSROOM PLAN (BY OTHERS) SCALE: 1:50

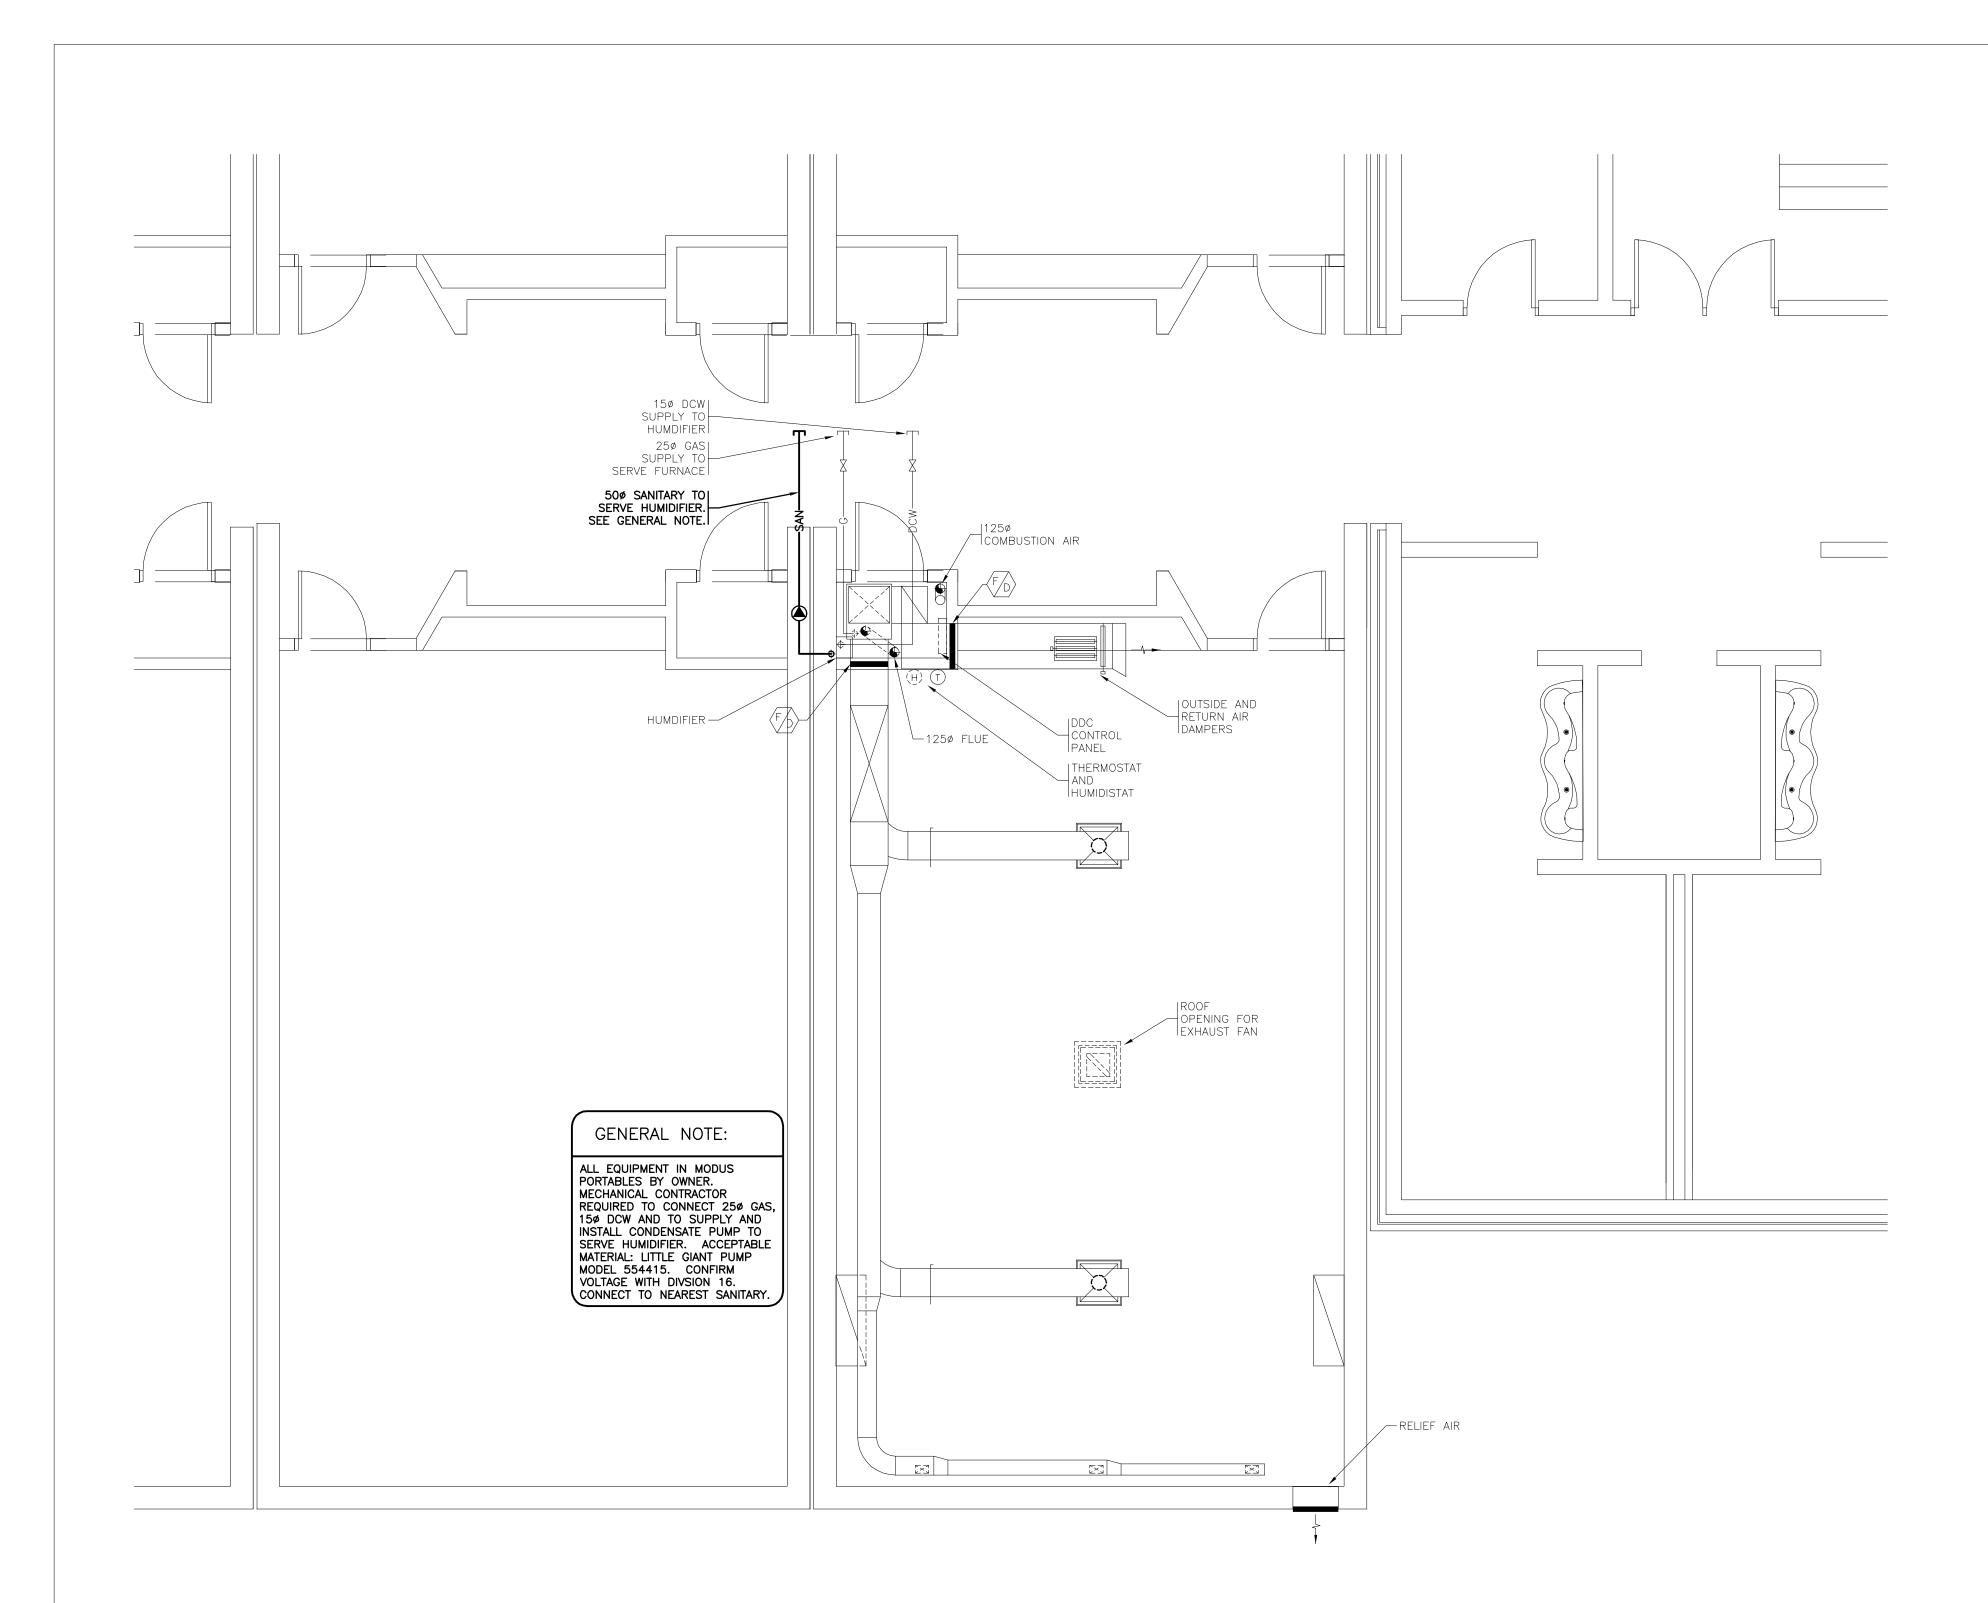
ARCHITECTS & INTERIOR DESIGNERS 210, 10190 – 104 St. Edmonton, Alberta Canada T5J 1A7 Tel: (780) 423–6606 Fax: (780) 429–3962 **EXAMPLE 1** CONSULTING ENGINEERS \* CONSULTING \* CALGARY \* ATLANTA \* PROTOSTATIX ENGINEERING CONSULTANTS INC. B RASTRUCTURE AND TRANSPORTATION PRELIMINARY THIS DRAWING IS FOR PROGRESS DOCUMENTATION ONLY AND IS NOT FOR CONSTRUCTION PURPOSES KEYPLAN 1 2007/10/31 ISSUED FOR FINAL DESIGN DEVELOPMENT NO DATE DESCRIPTION REVISIONS SEAL / PERMIT PROJECT 900 STUDENT K-9 CORE SCHOOL ALBERTA SHEET TITLE TYPICAL PORTABLE CLASSROOM PLAN Checked Drawn WMH Project No. E07175 Date September 18, 2007 Scale Sheet No. 1:50 M20




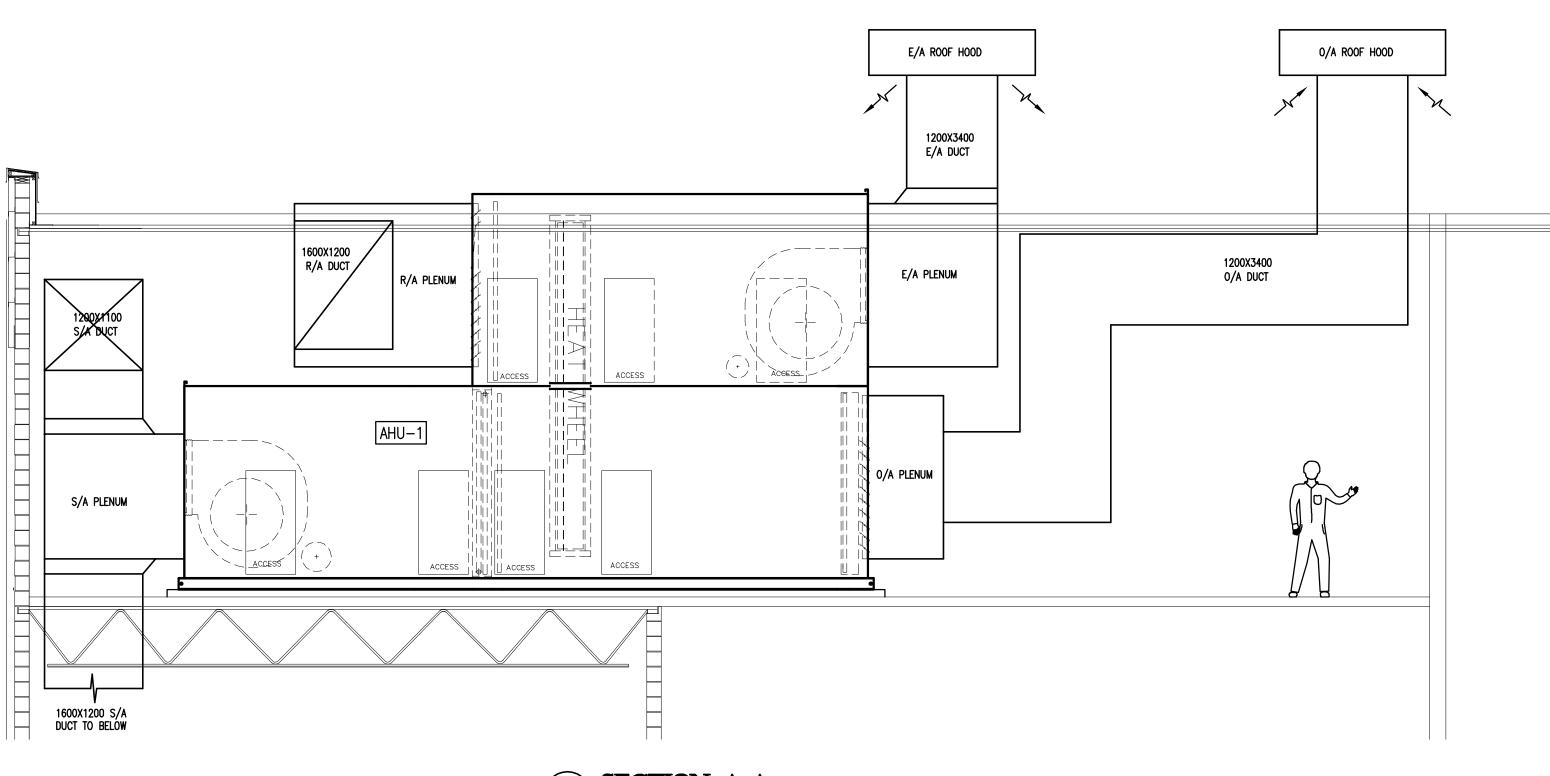



A SECTION A-A M21 SCALE: 1:50

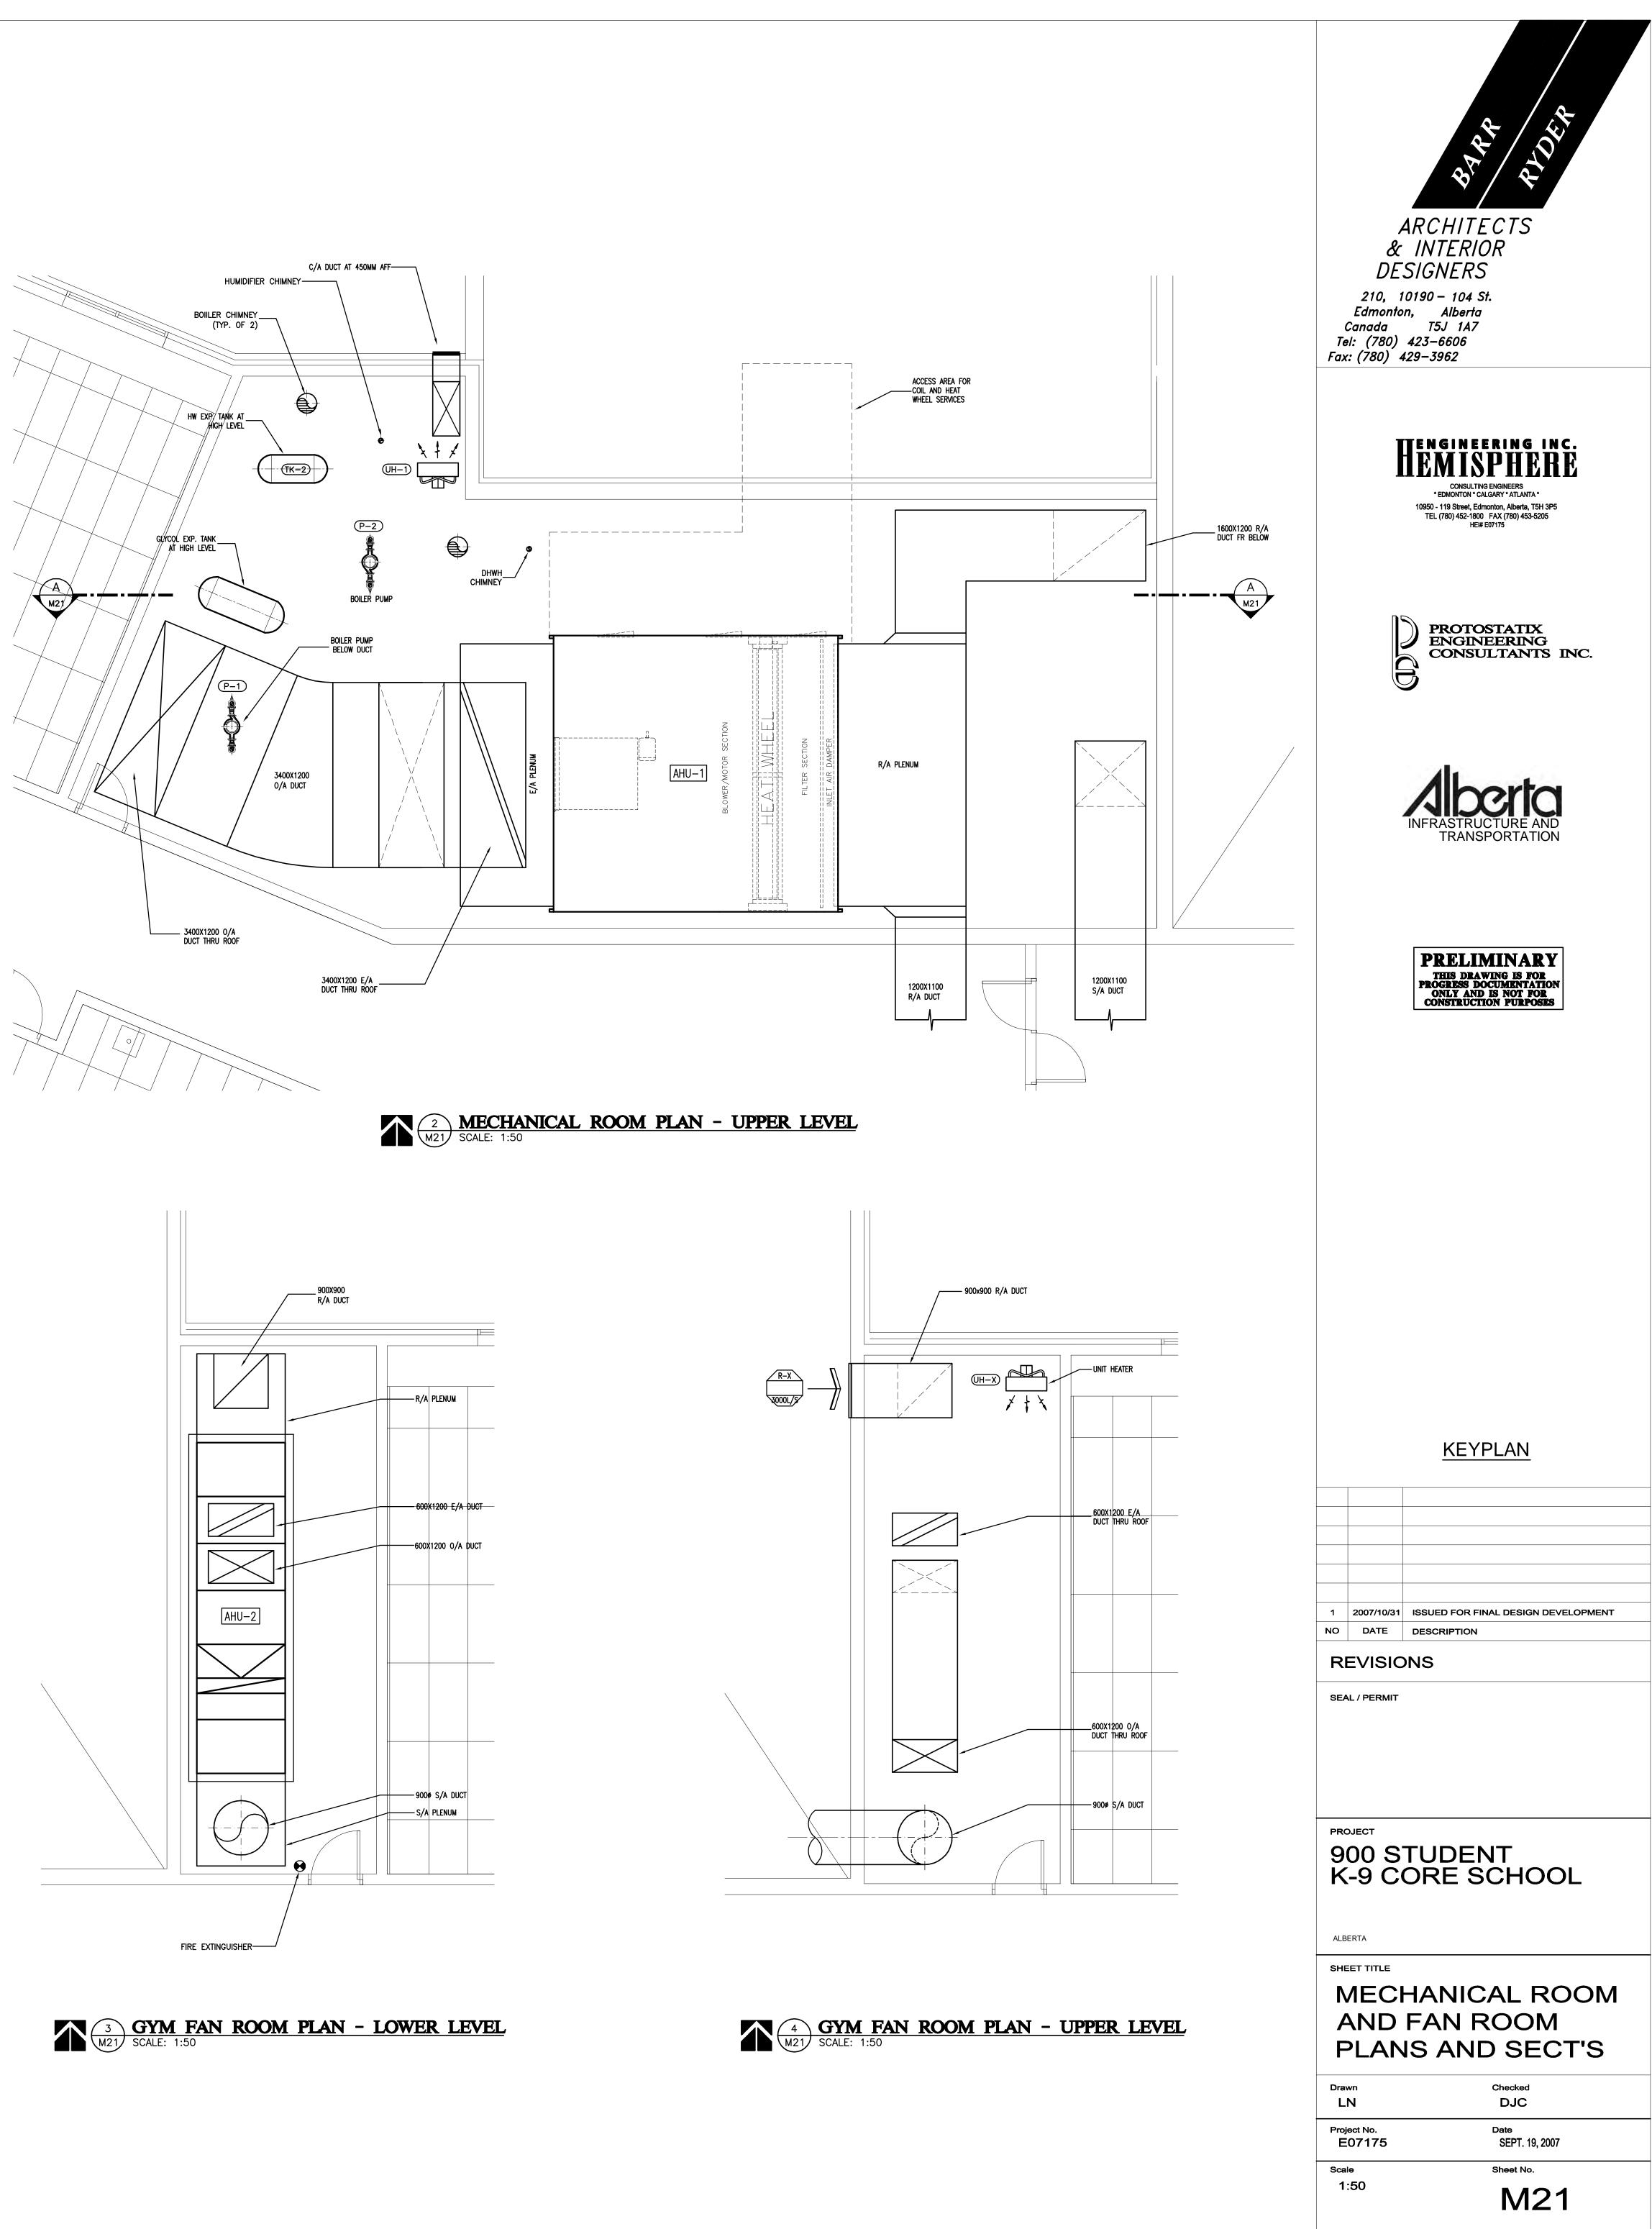

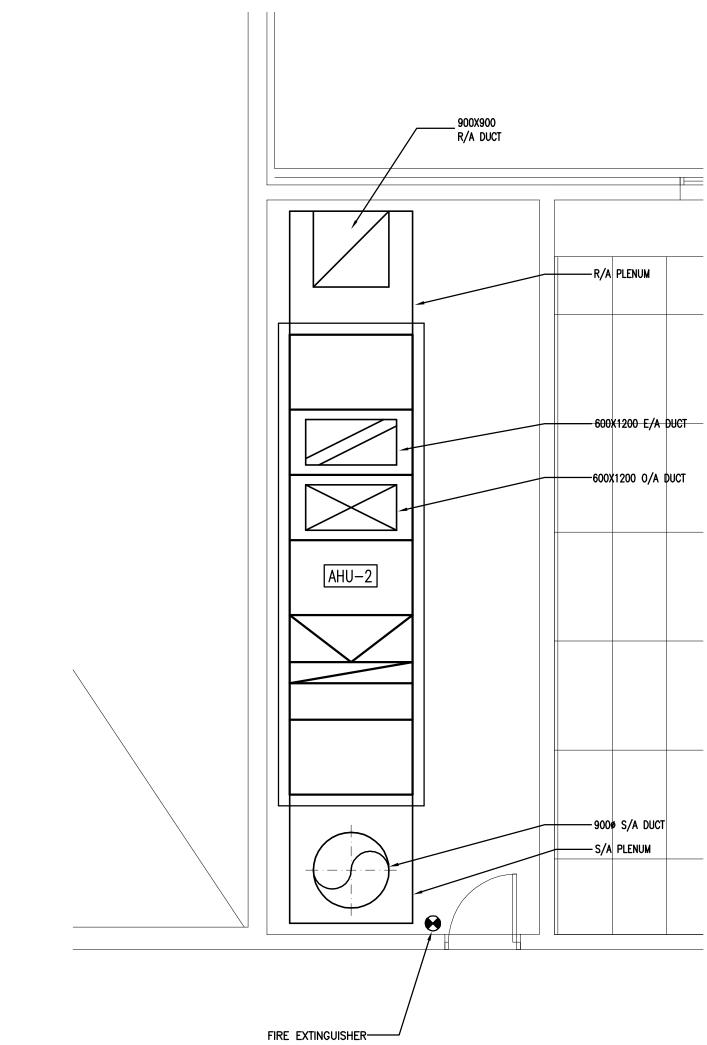

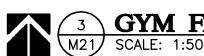


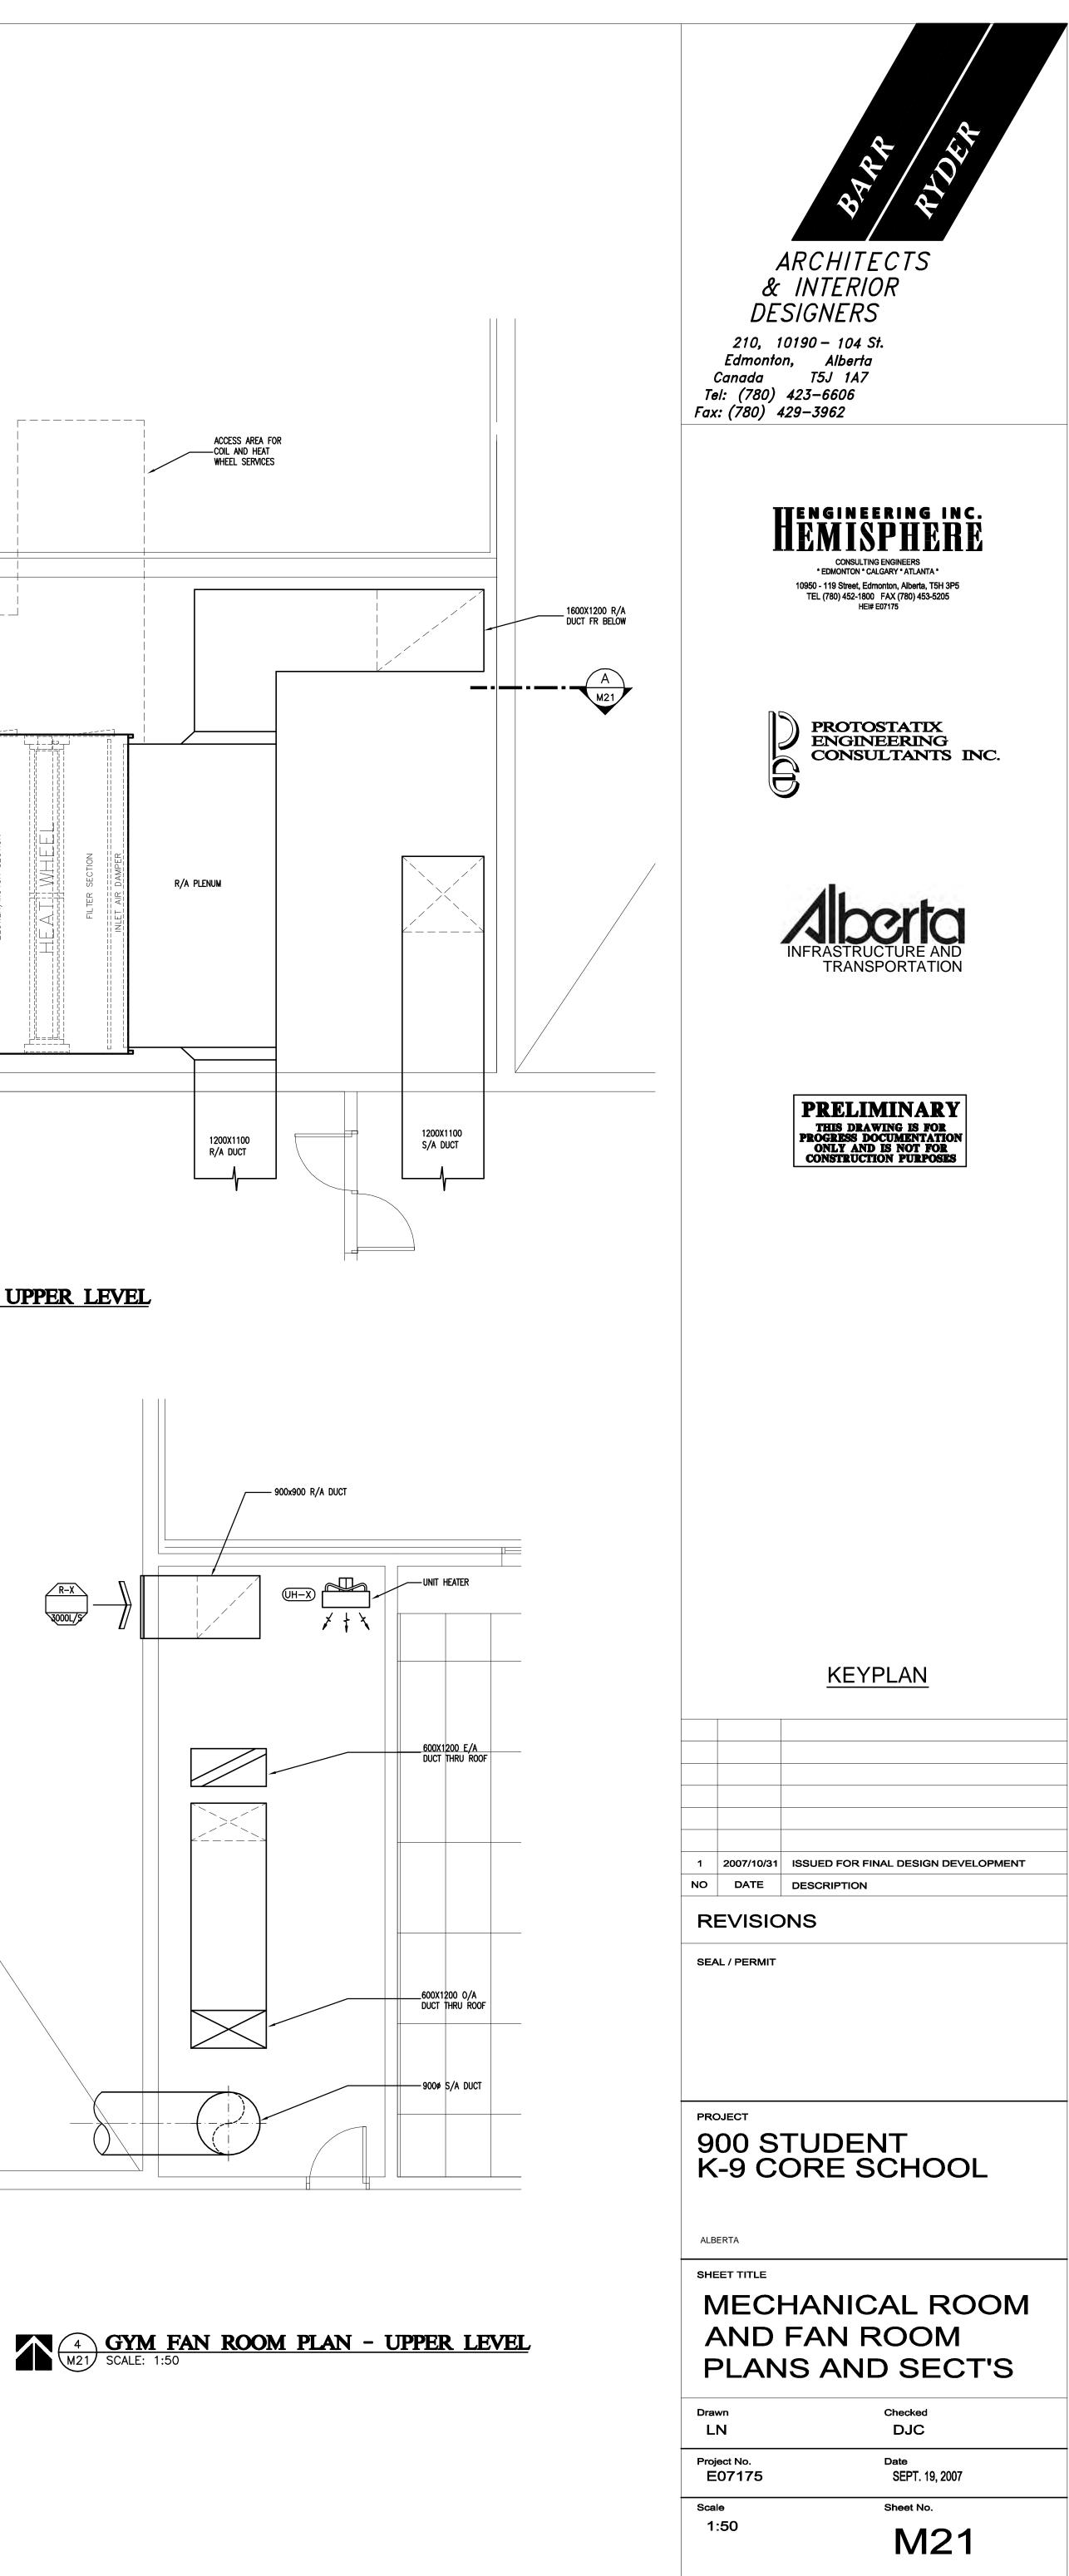

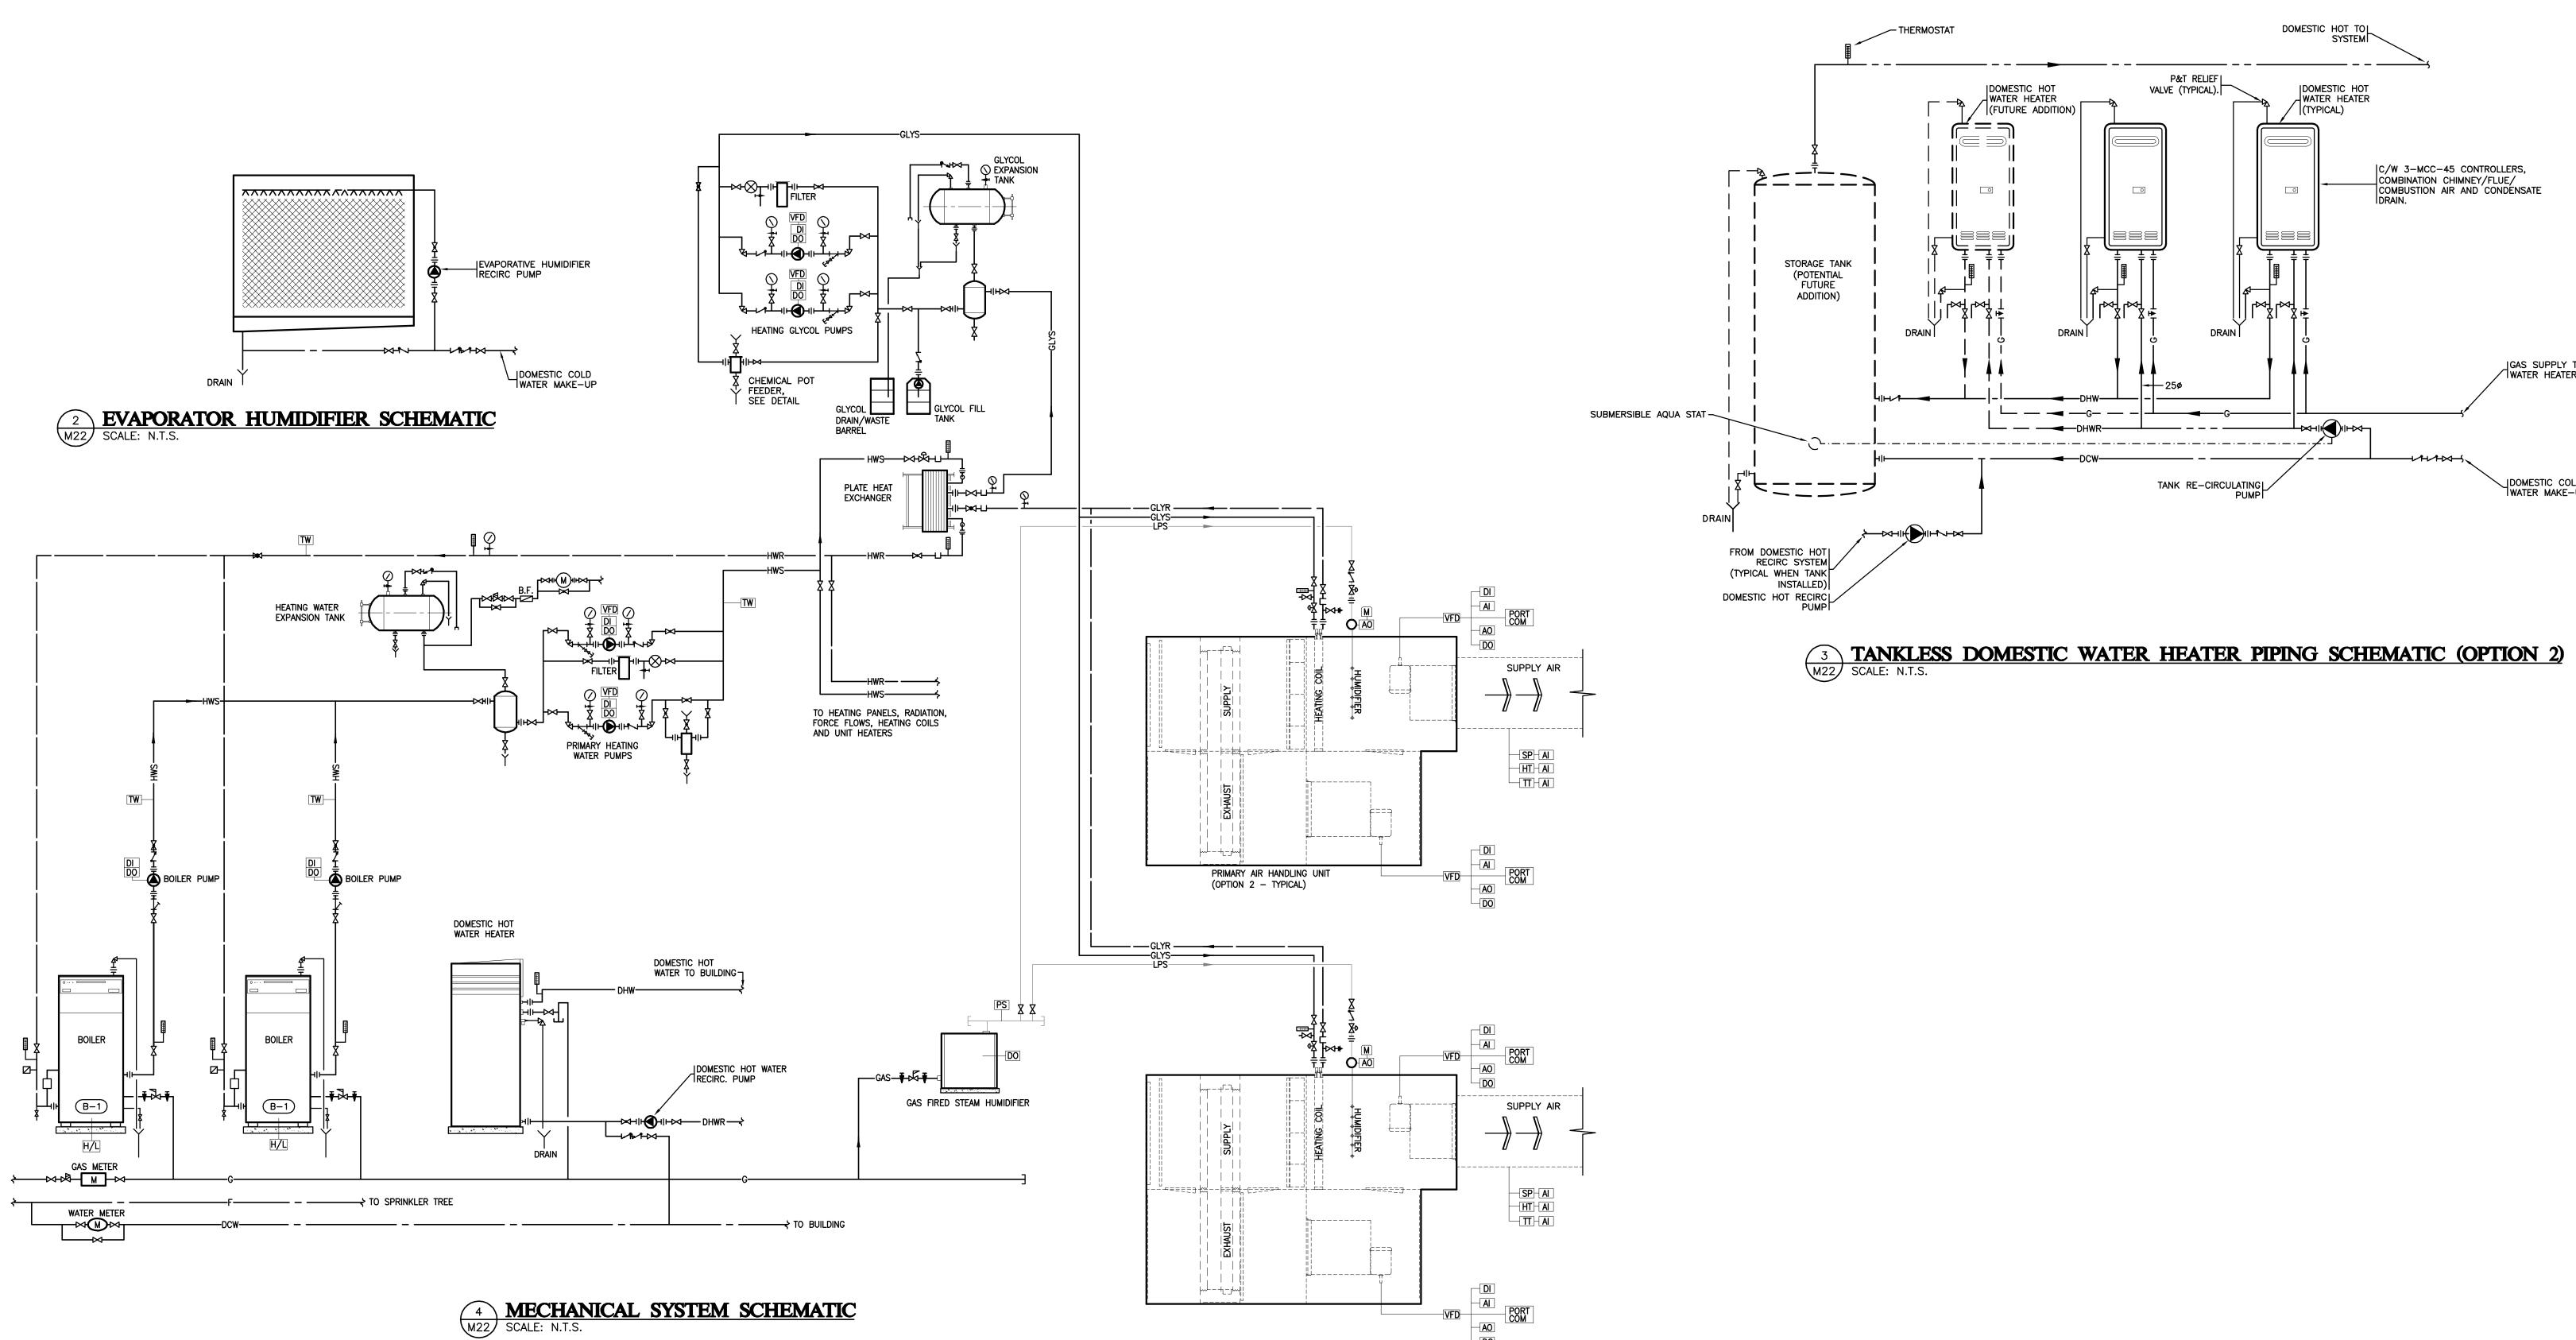


GYM AIR HANDLING UNIT (TYPICAL)




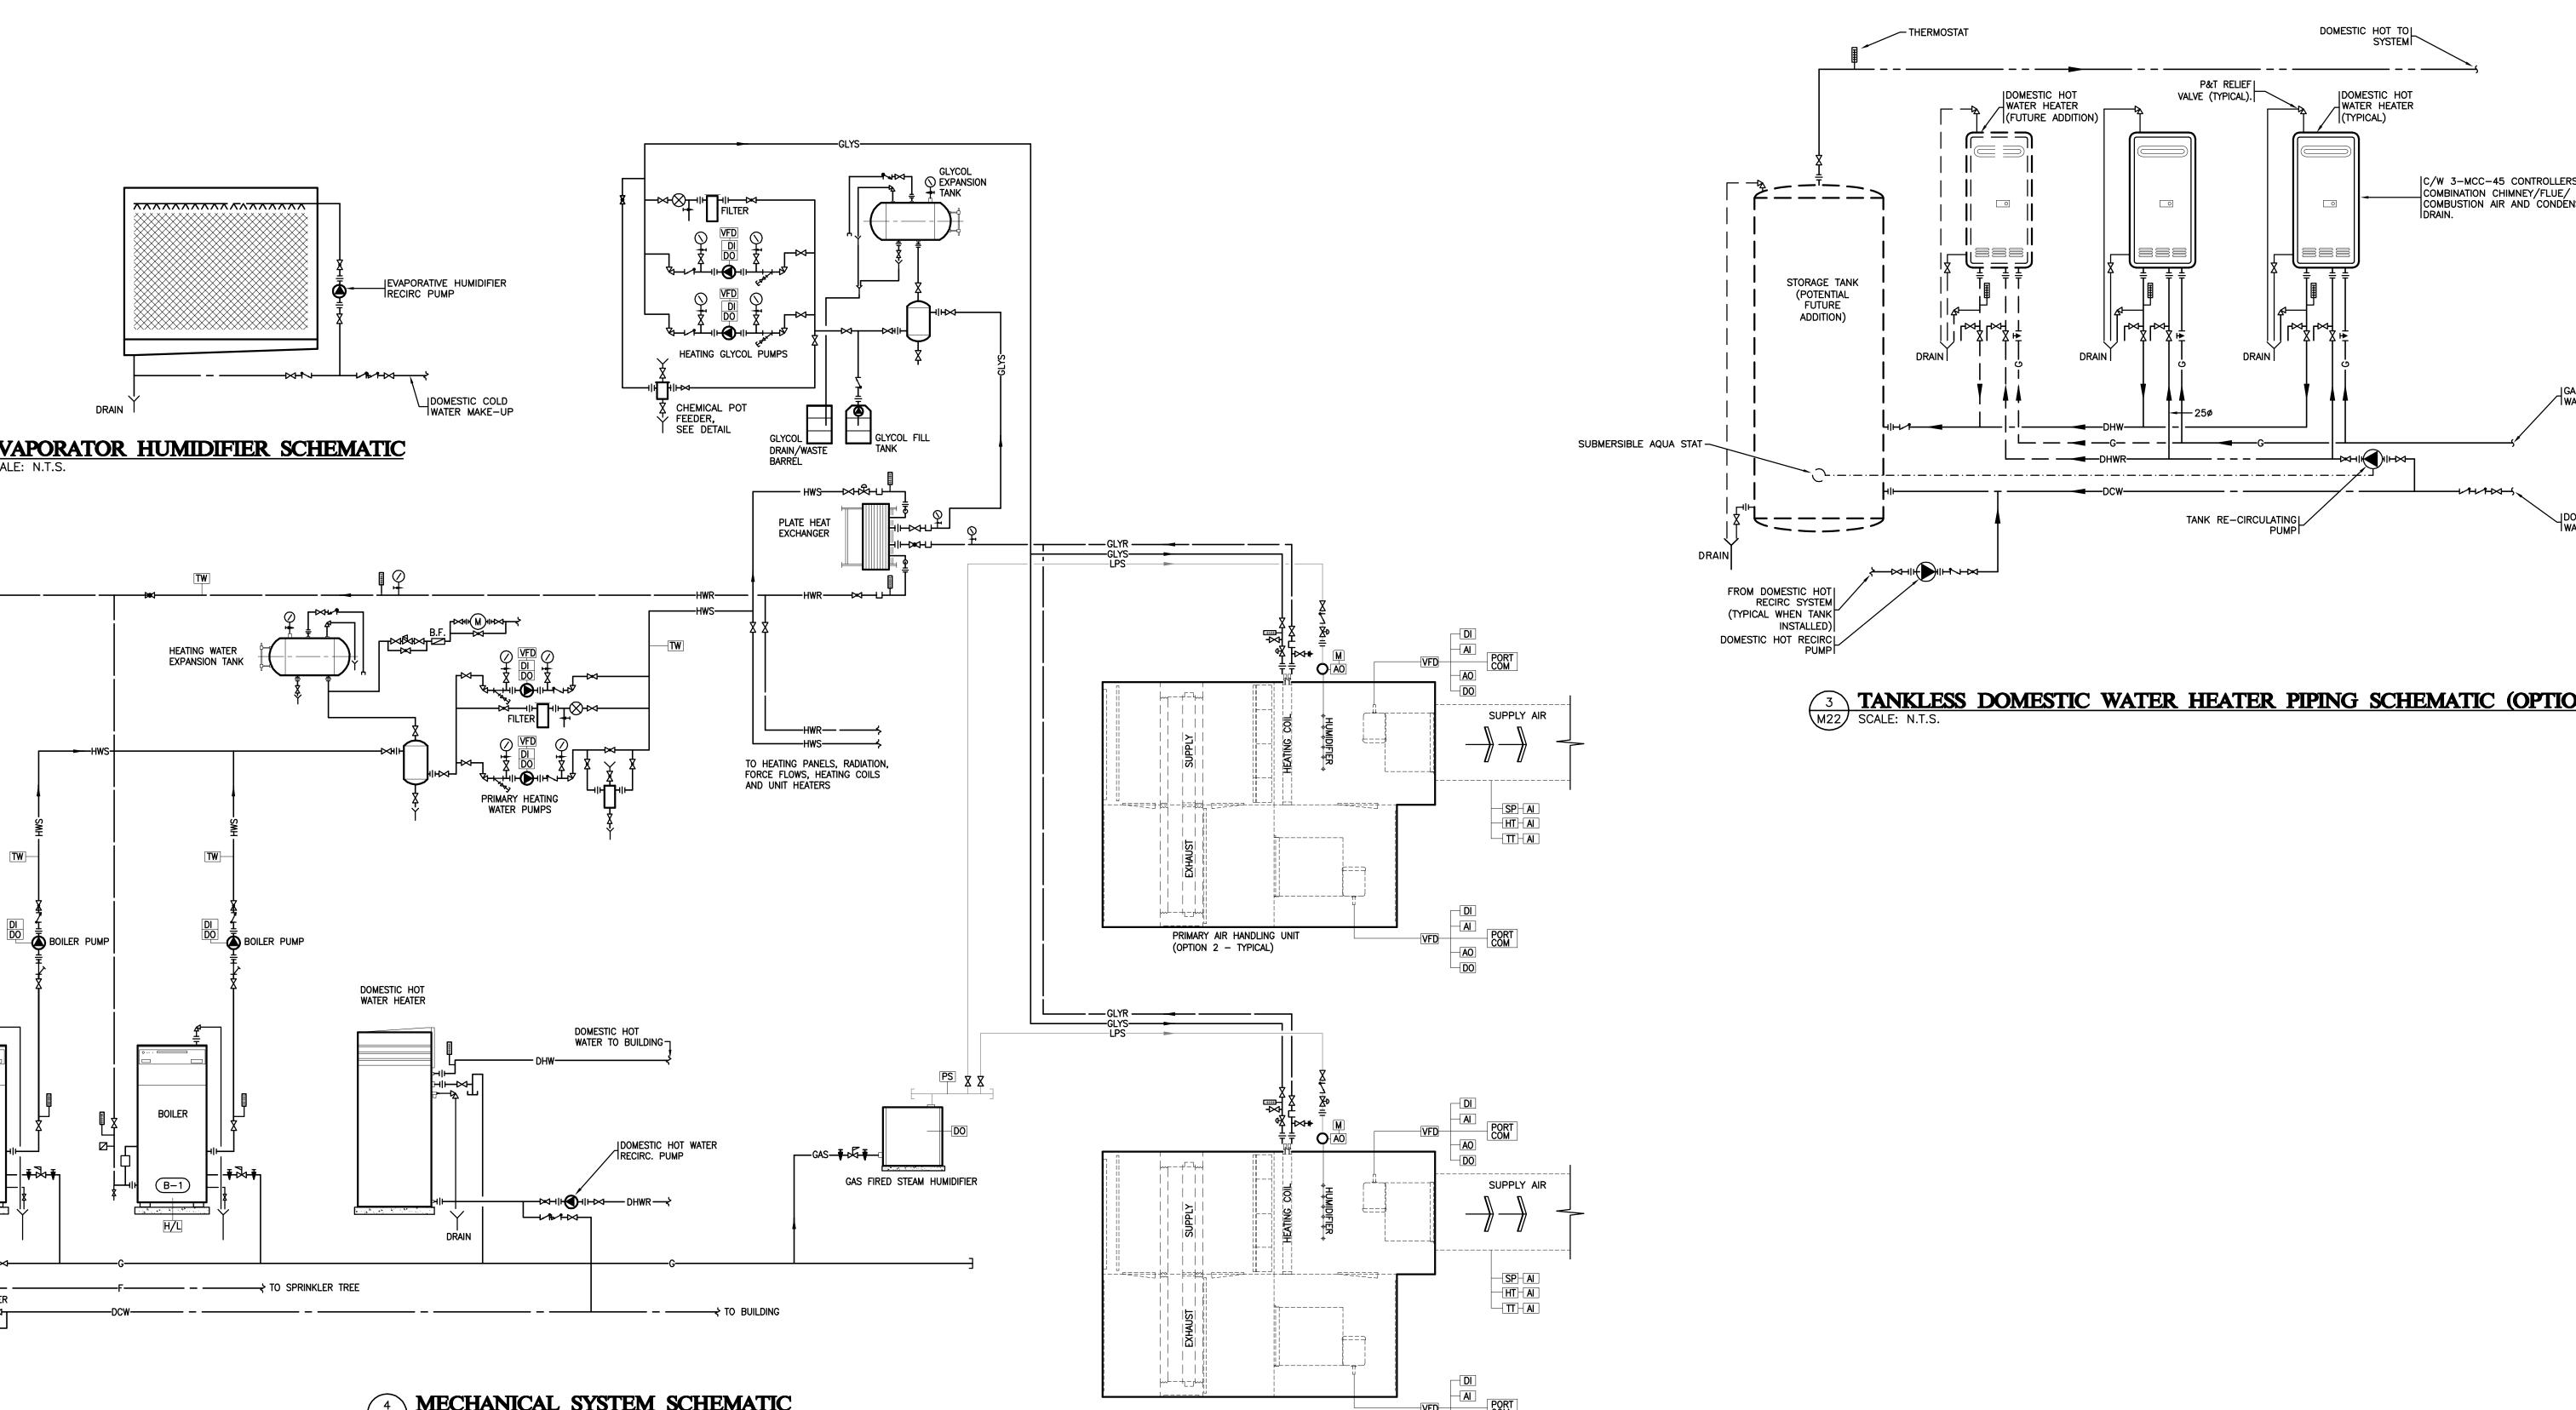


-AO DO

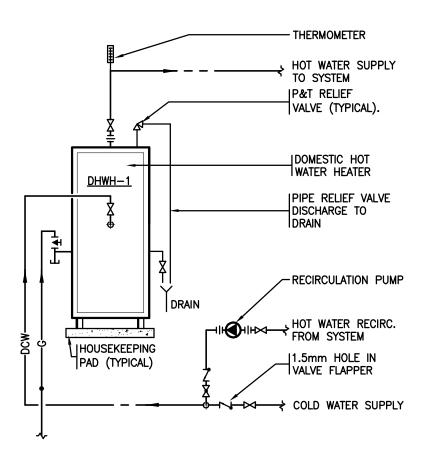


1 DOMESTIC WATER HEATER PIPING SCHEMATIC (OPTION 1) M22 SCALE: N.T.S.

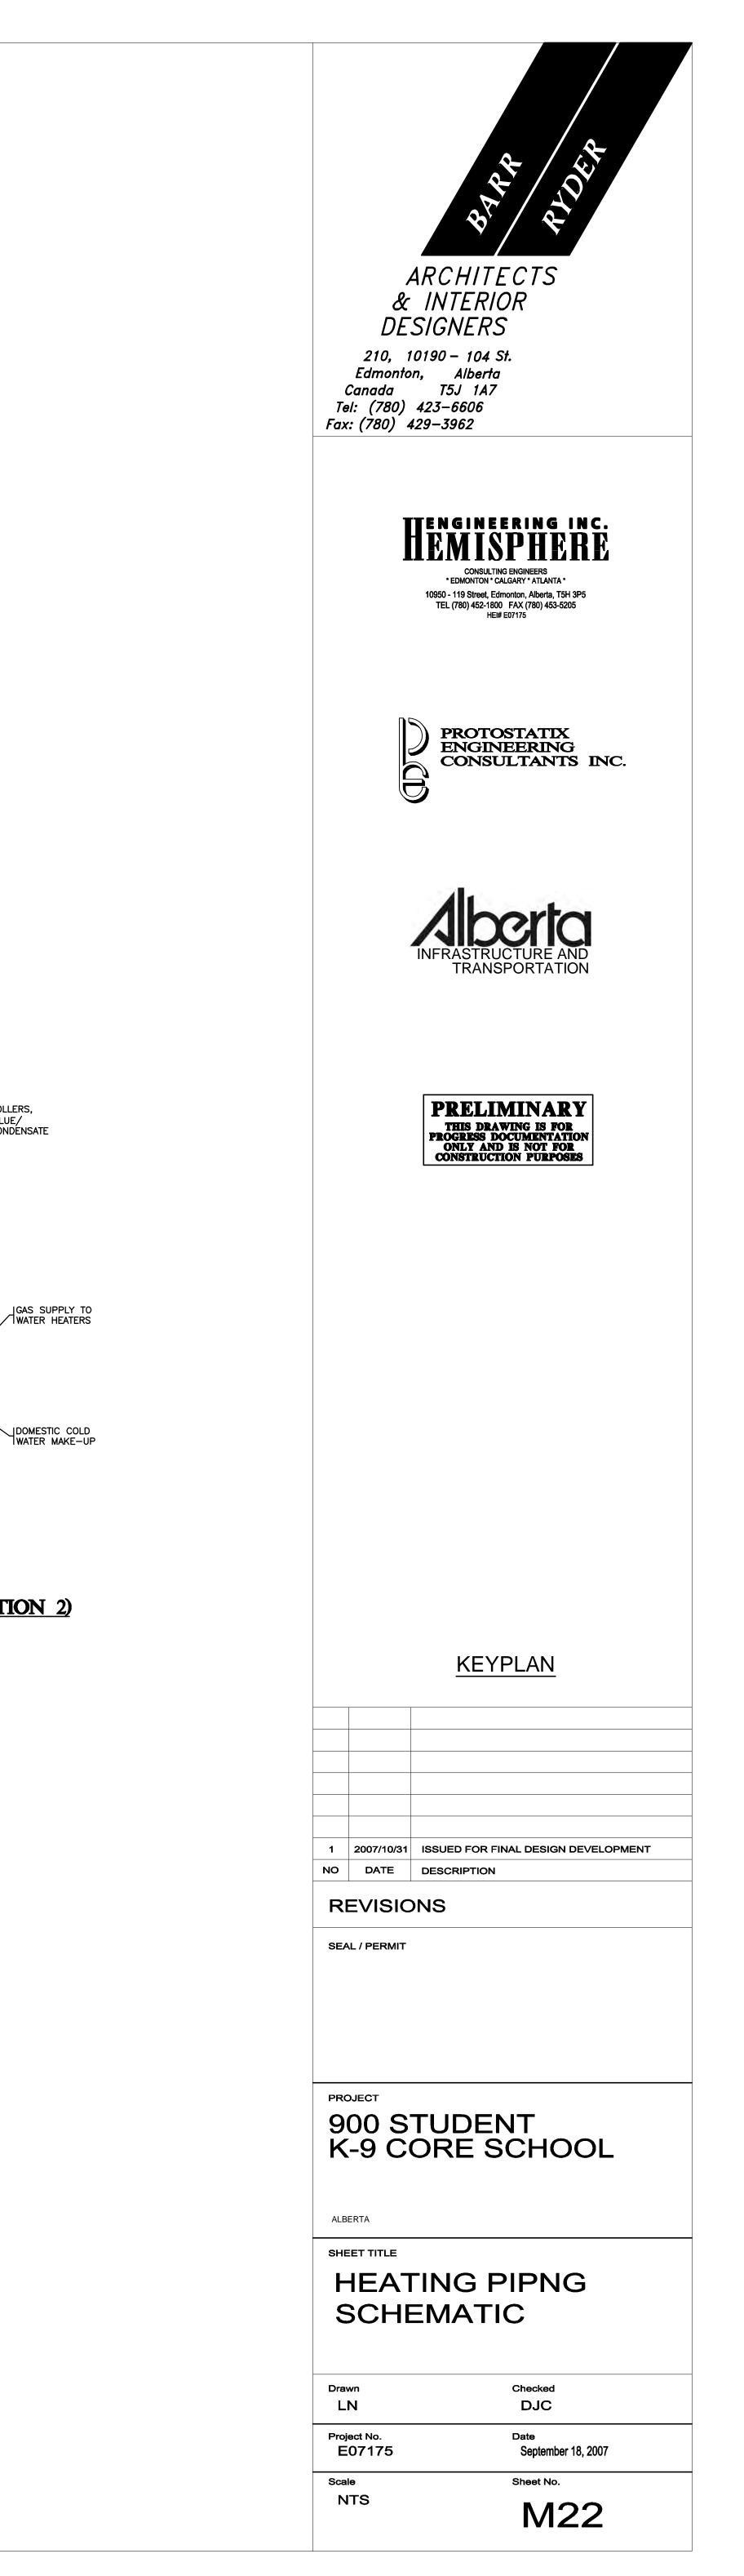

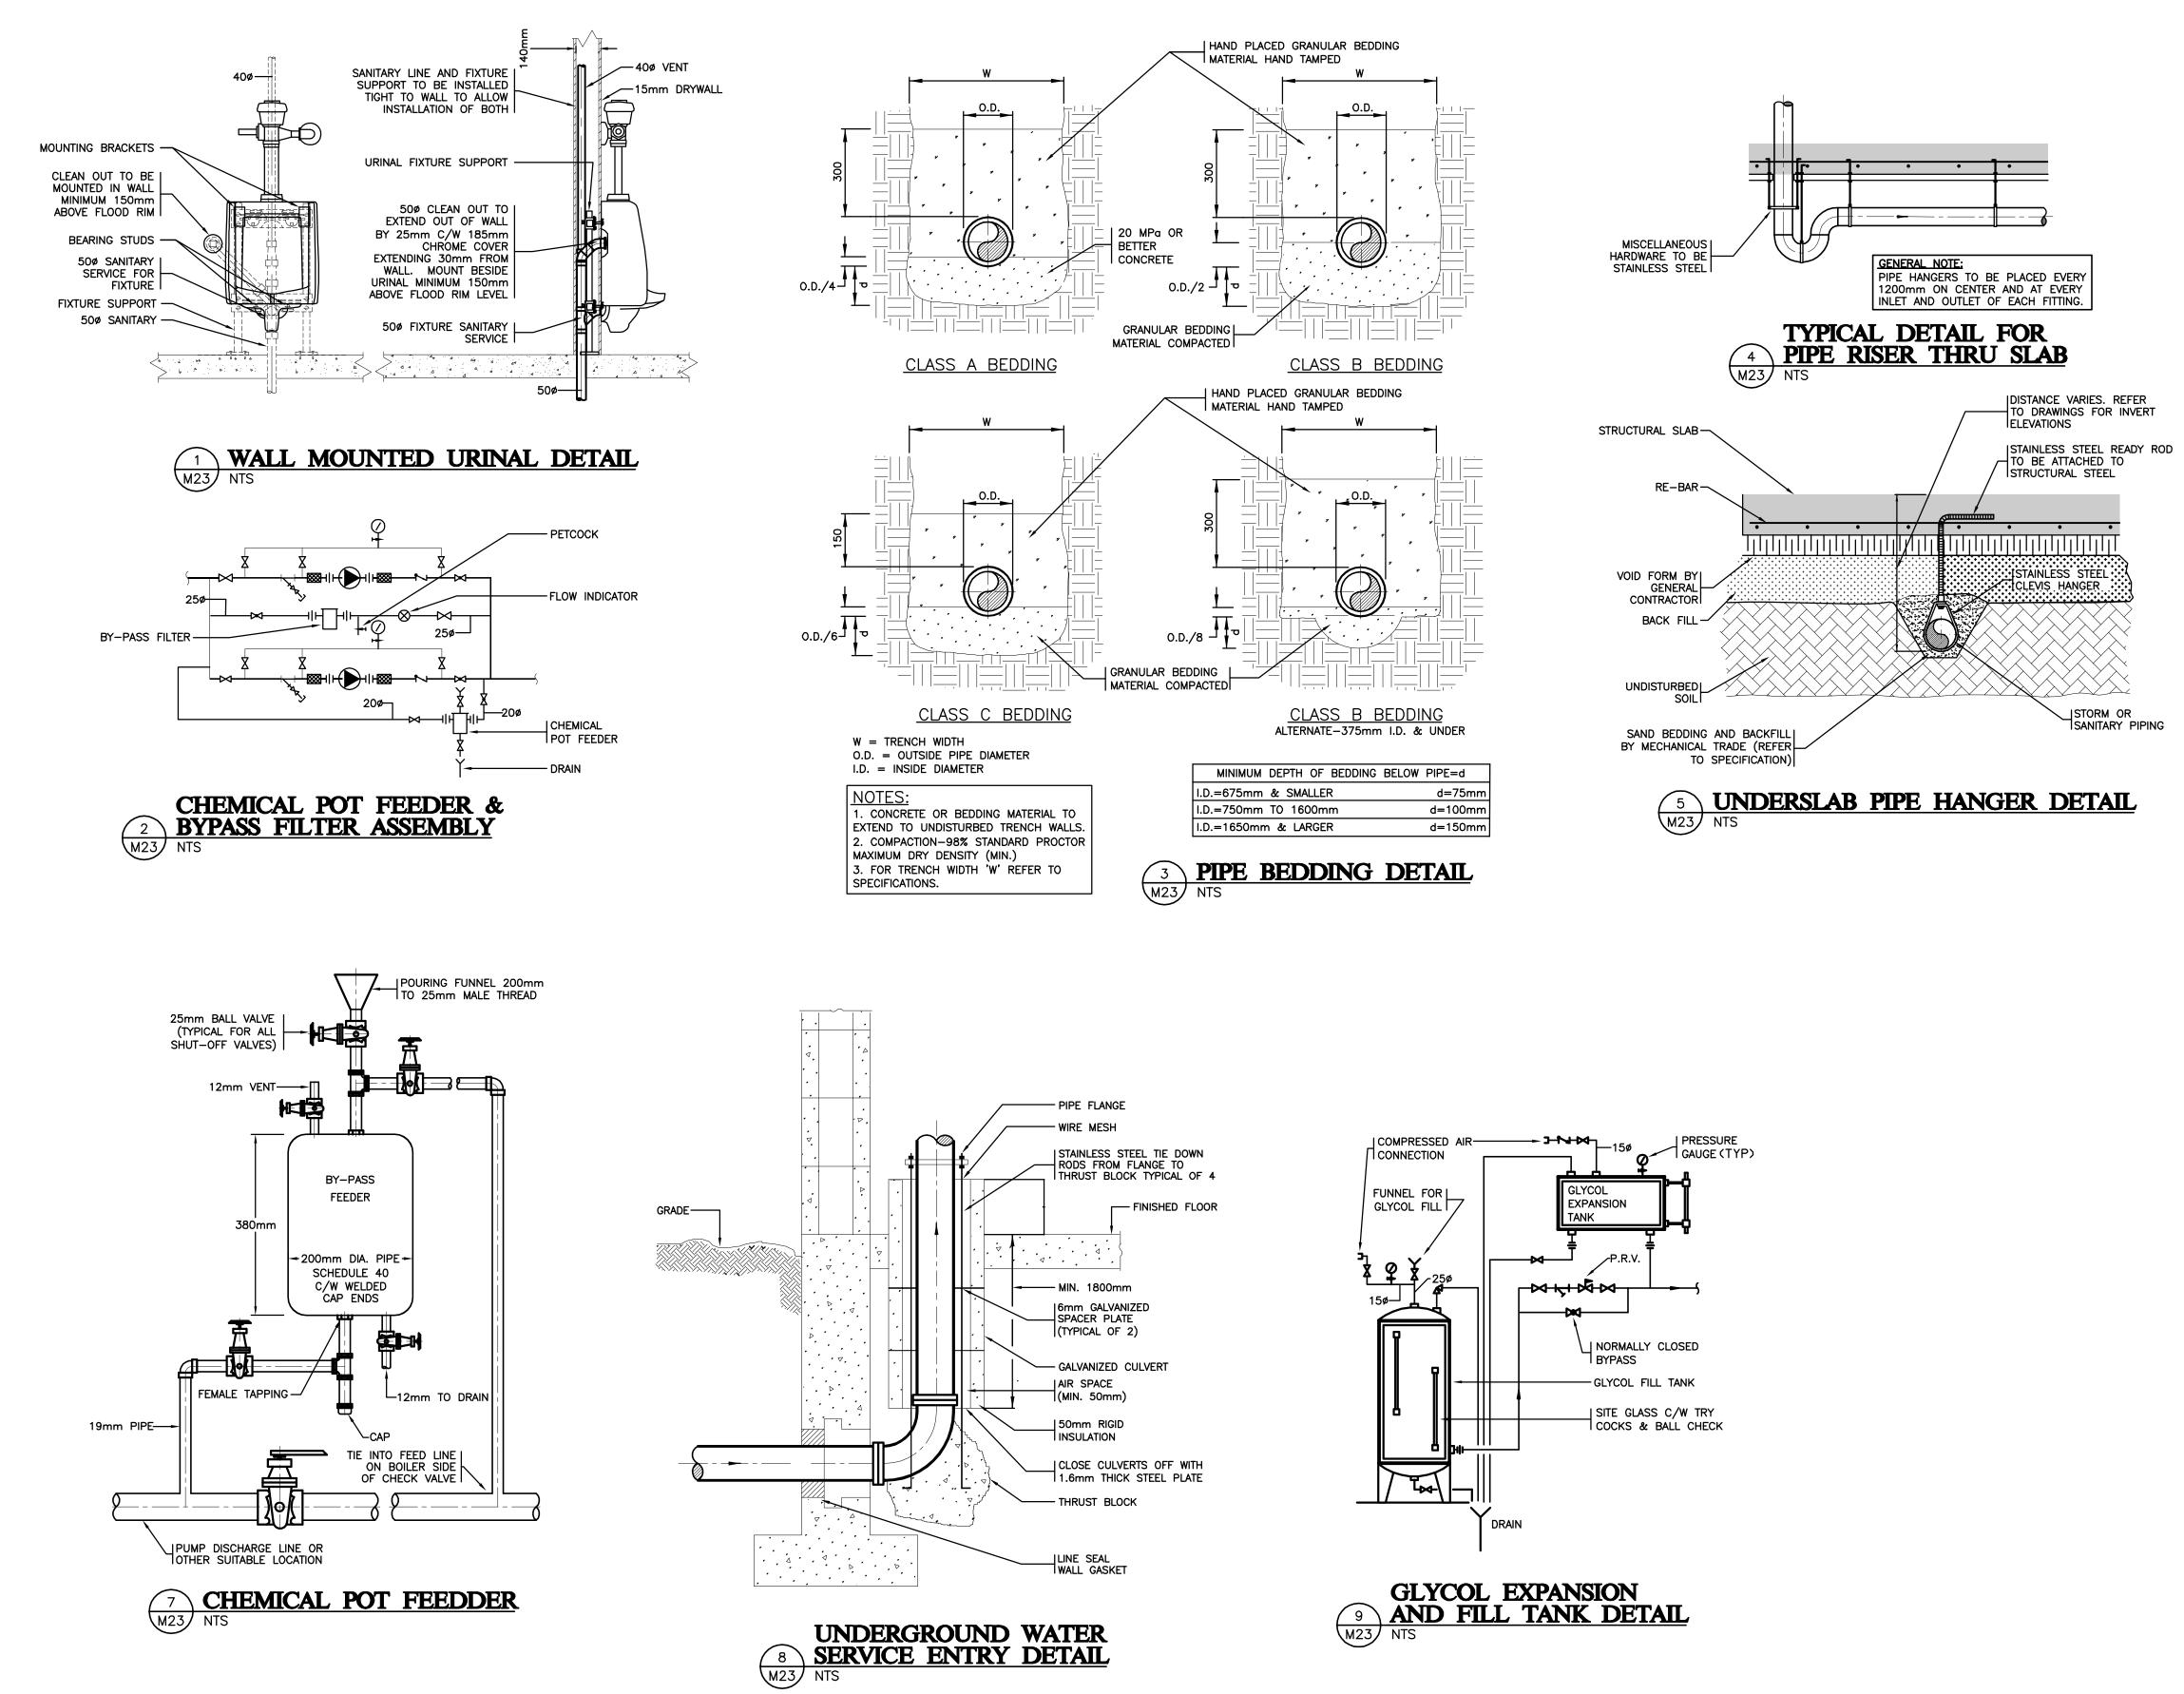

PIPE SIZE		MAXIMUM FLOOR AREA REQUIRED						
INCHES	mm	LENGTH	WIDTH	AREA	LENGTH	WIDTH	AREA	
		ft.	ft.	sq. ft.	m	m	sq. m	
2	50	5	4.5	22.5	1.5	1.4	2.1	
3	75	7	4.5	31.5	2.1	1.4	2.9	
4	100	7	4.5	31.5	2.1	1.4	2.9	
6	150	8	4.5	31.5	2.4	1.4	3.4	

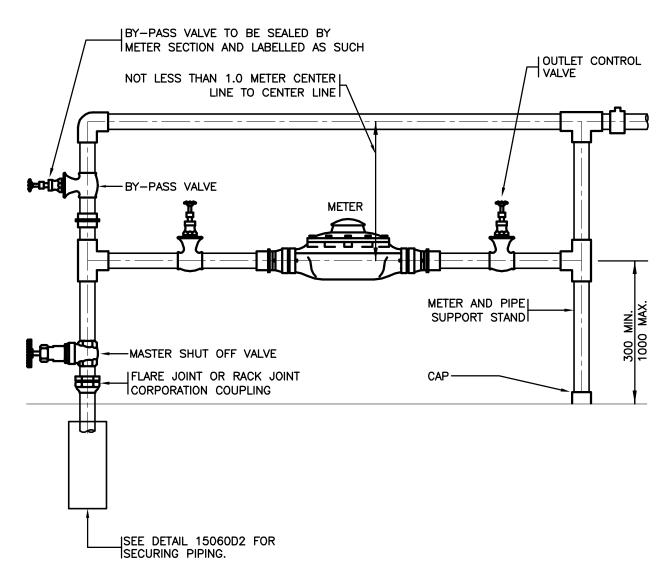


6 WATER METER DETAIL M23 NTS


ARCHITECTS & INTERIOR DESIGNERS 210, 10190 – 104 St. Edmonton, Alberta Canada T5J 1A7 Tel: (780) 423–6606 Fax: (780) 429–3962 HEMISPHERE CONSULTING ENGINEERS \* EDMONTON \* CALGARY \* ATLANTA \* 10950 - 119 Street, Edmonton, Alberta, T5H 3P5 TEL (780) 452-1800 FAX (780) 453-5205 HE# E07175 PROTOSTATIX ENGINEERING CONSULTANTS INC. G TRANSPORTATION PRELIMINARY THIS DRAWING IS FOR PROGRESS DOCUMENTATION ONLY AND IS NOT FOR CONSTRUCTION PURPOSES KEYPLAN 1 2007/10/31 ISSUED FOR FINAL DESIGN DEVELOPMENT NO DATE DESCRIPTION REVISIONS SEAL / PERMIT PROJECT 900 STUDENT K-9 CORE SCHOOL ALBERTA SHEET TITLE DETAILS Checked DJC Drawn LN Project No. E07175 Date September 18, 2007 Scale Sheet No. NTS M23




SYMBOL SCHEDULE				
LIGHTING				
RECESSED 1'x4' FLOURESCENT LUMINAIRE				
RECESSED 2'x4' FLOURESCENT LUMINAIRE				
RECESSED 2'x2' FLOURESCENT LUMINAIRE				
SURFACE MOUNTED 2'x4' FLOURESCENT LUMINAIRE				
SURFACE MOUNTED 1'x4' FLOURESCENT LUMINAIRE				
SURFACE MOUNTED STRIP LIGHT				
SURFACE MOUNTED INCANDESCENT LUMINAIRE				
RECESSED INCANDESCENT DOWNLIGHT				
RECESSED COMPACT FLUORESCENT DOWNLIGHT				
WALL MOUNTED HID LUMINAIRE				
WALL MOUNTED COMPACT FLUORESCENT				
LINE VOLTAGE WALL SWITCH ('VC' = VOLUME CONTROL)				
INDICATES LUMINAIRE TYPE 'XX'				
OCCUPANCY SENSOR SWITCH				
POWER				
CEILING MOUNTED JUNCTION BOX				
SURFACE MOUNTED PANELBOARD				
WALL MOUNTED DUPLEX RECEPTACLE ('WP' = WEATHERPROOF)				
WALL MOUNTED FOURPLEX RECEPTACLE				
WALL MOUNTED G.F.I. DUPLEX RECEPTACLE				
ELECTRIC MOTOR				
ELECTRICAL DISCONNECT SWITCH				
WALL MOUNTED PUSH BUTTON				
FIRE ALARM				
FIRE ALARM CONTROL PANEL				
WALL MOUNTED EXIT LIGHT				
EMERGENCY LIGHT BATTERY PACK WITH DUAL HEAD				
EMERGENCY LIGHT DOUBLE REMOTE HEAD				
FIRE ALARM PULL STATION				
FIRE ALARM HORN/STROBE				
FIRE ALARM SMOKE DETECTOR				
SYSTEMS				
CEILING MOUNTED SPEAKER				
RECESSED CEILING MOUNTED SPEAKER				
WALL MOUNTED MICROPHONE OUTLET				
WALL MOUNTED SPEAKER HORN				
COMPUTER OUTLET				
TELEPHONE OUTLET				
DATA/VOICE OUTLET (1 DATA, 1 VOICE)				
SECURITY				
SECURITY DOOR CONTACT				
SECURITY KEYPAD				

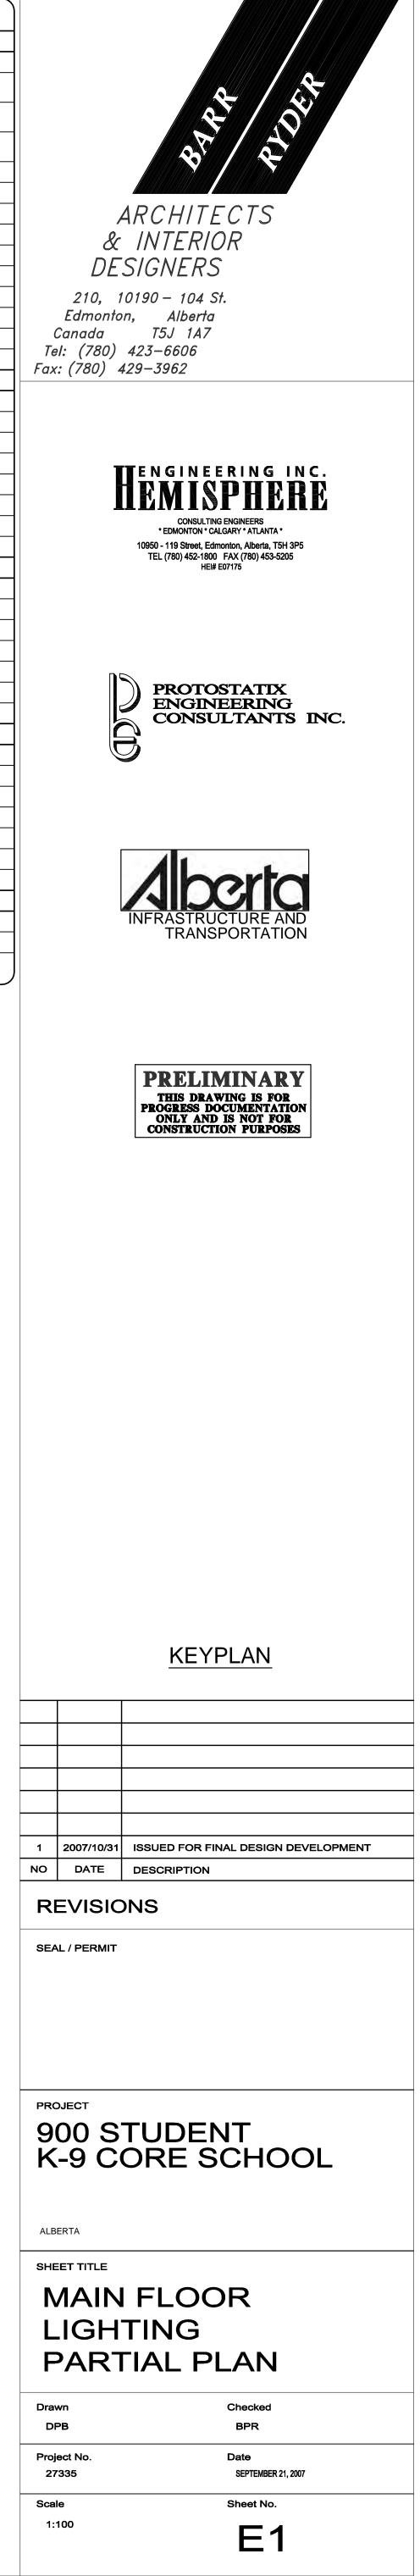





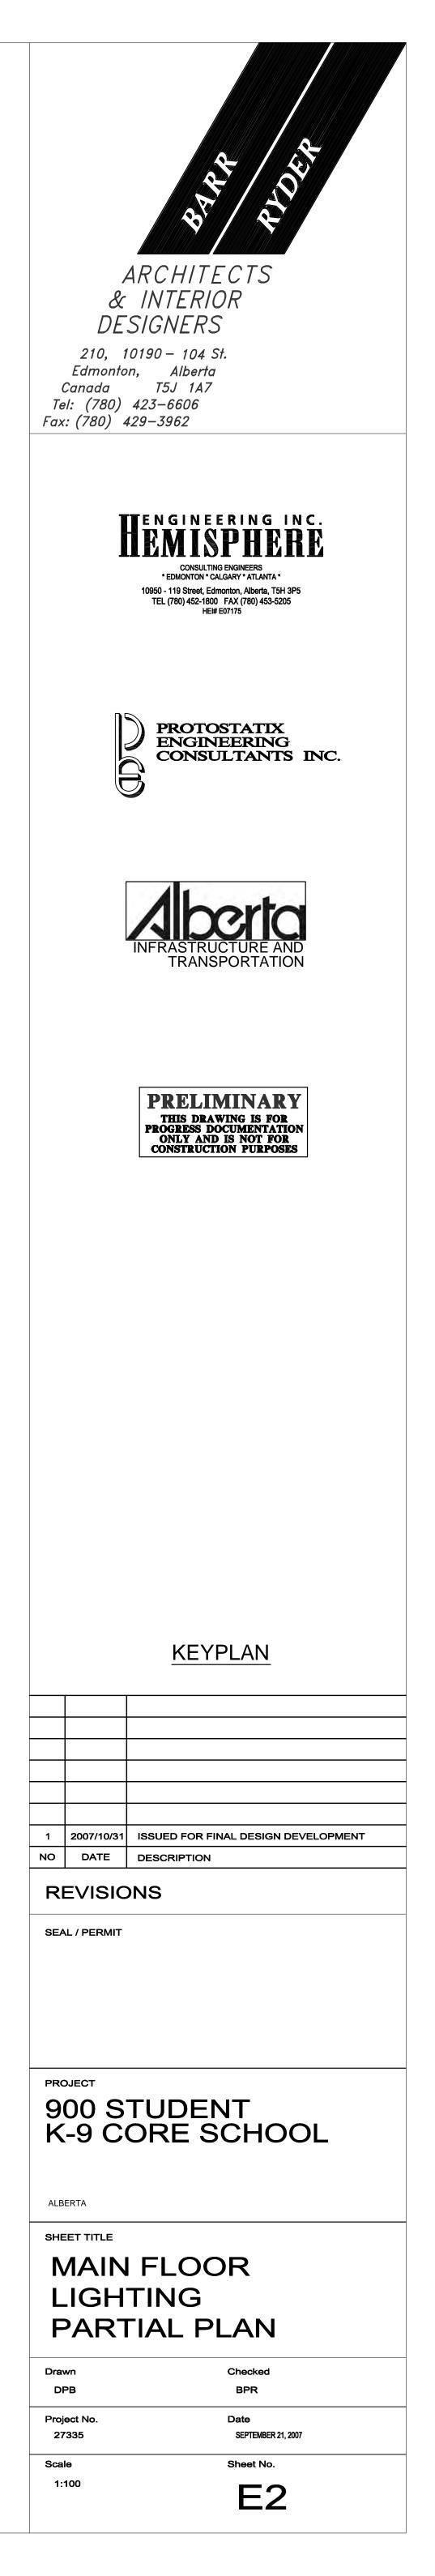



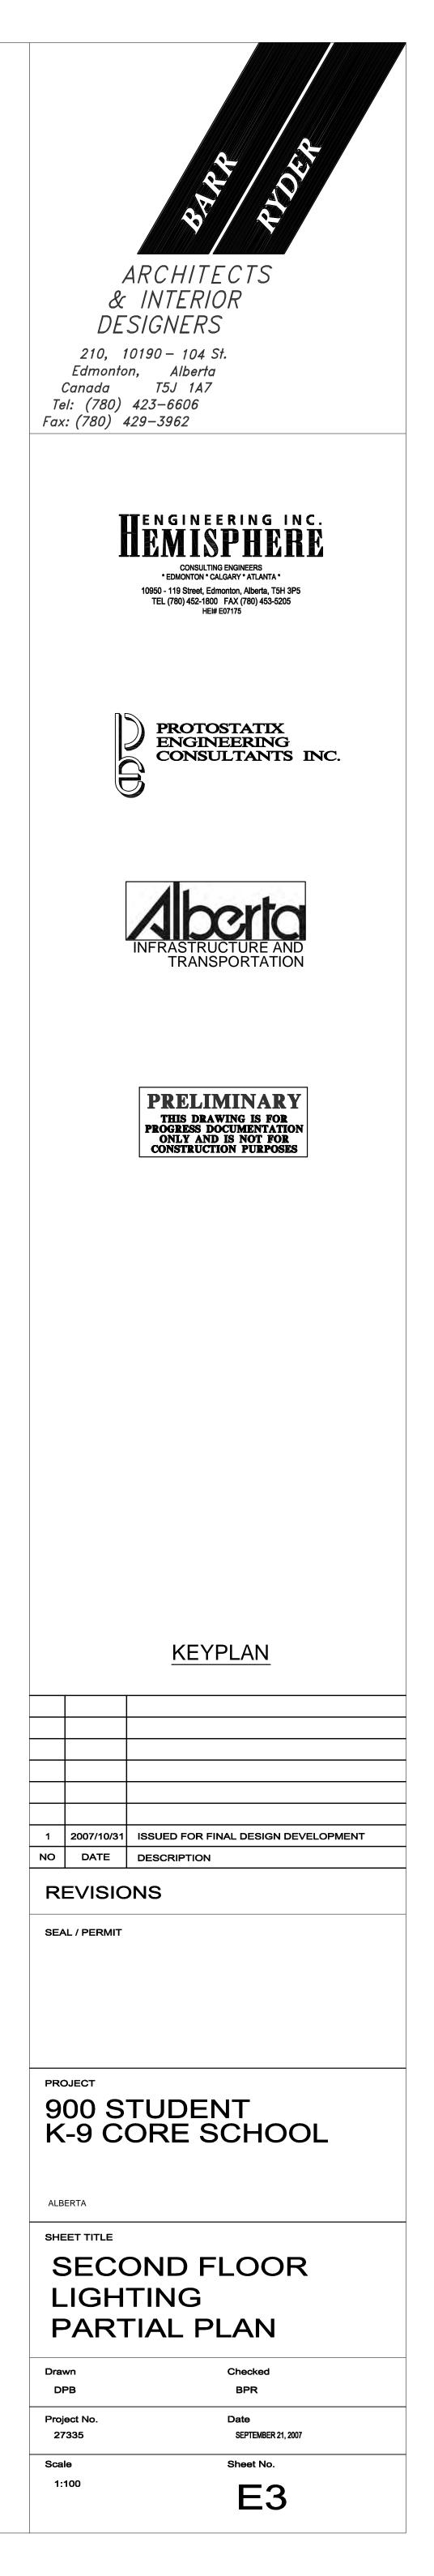

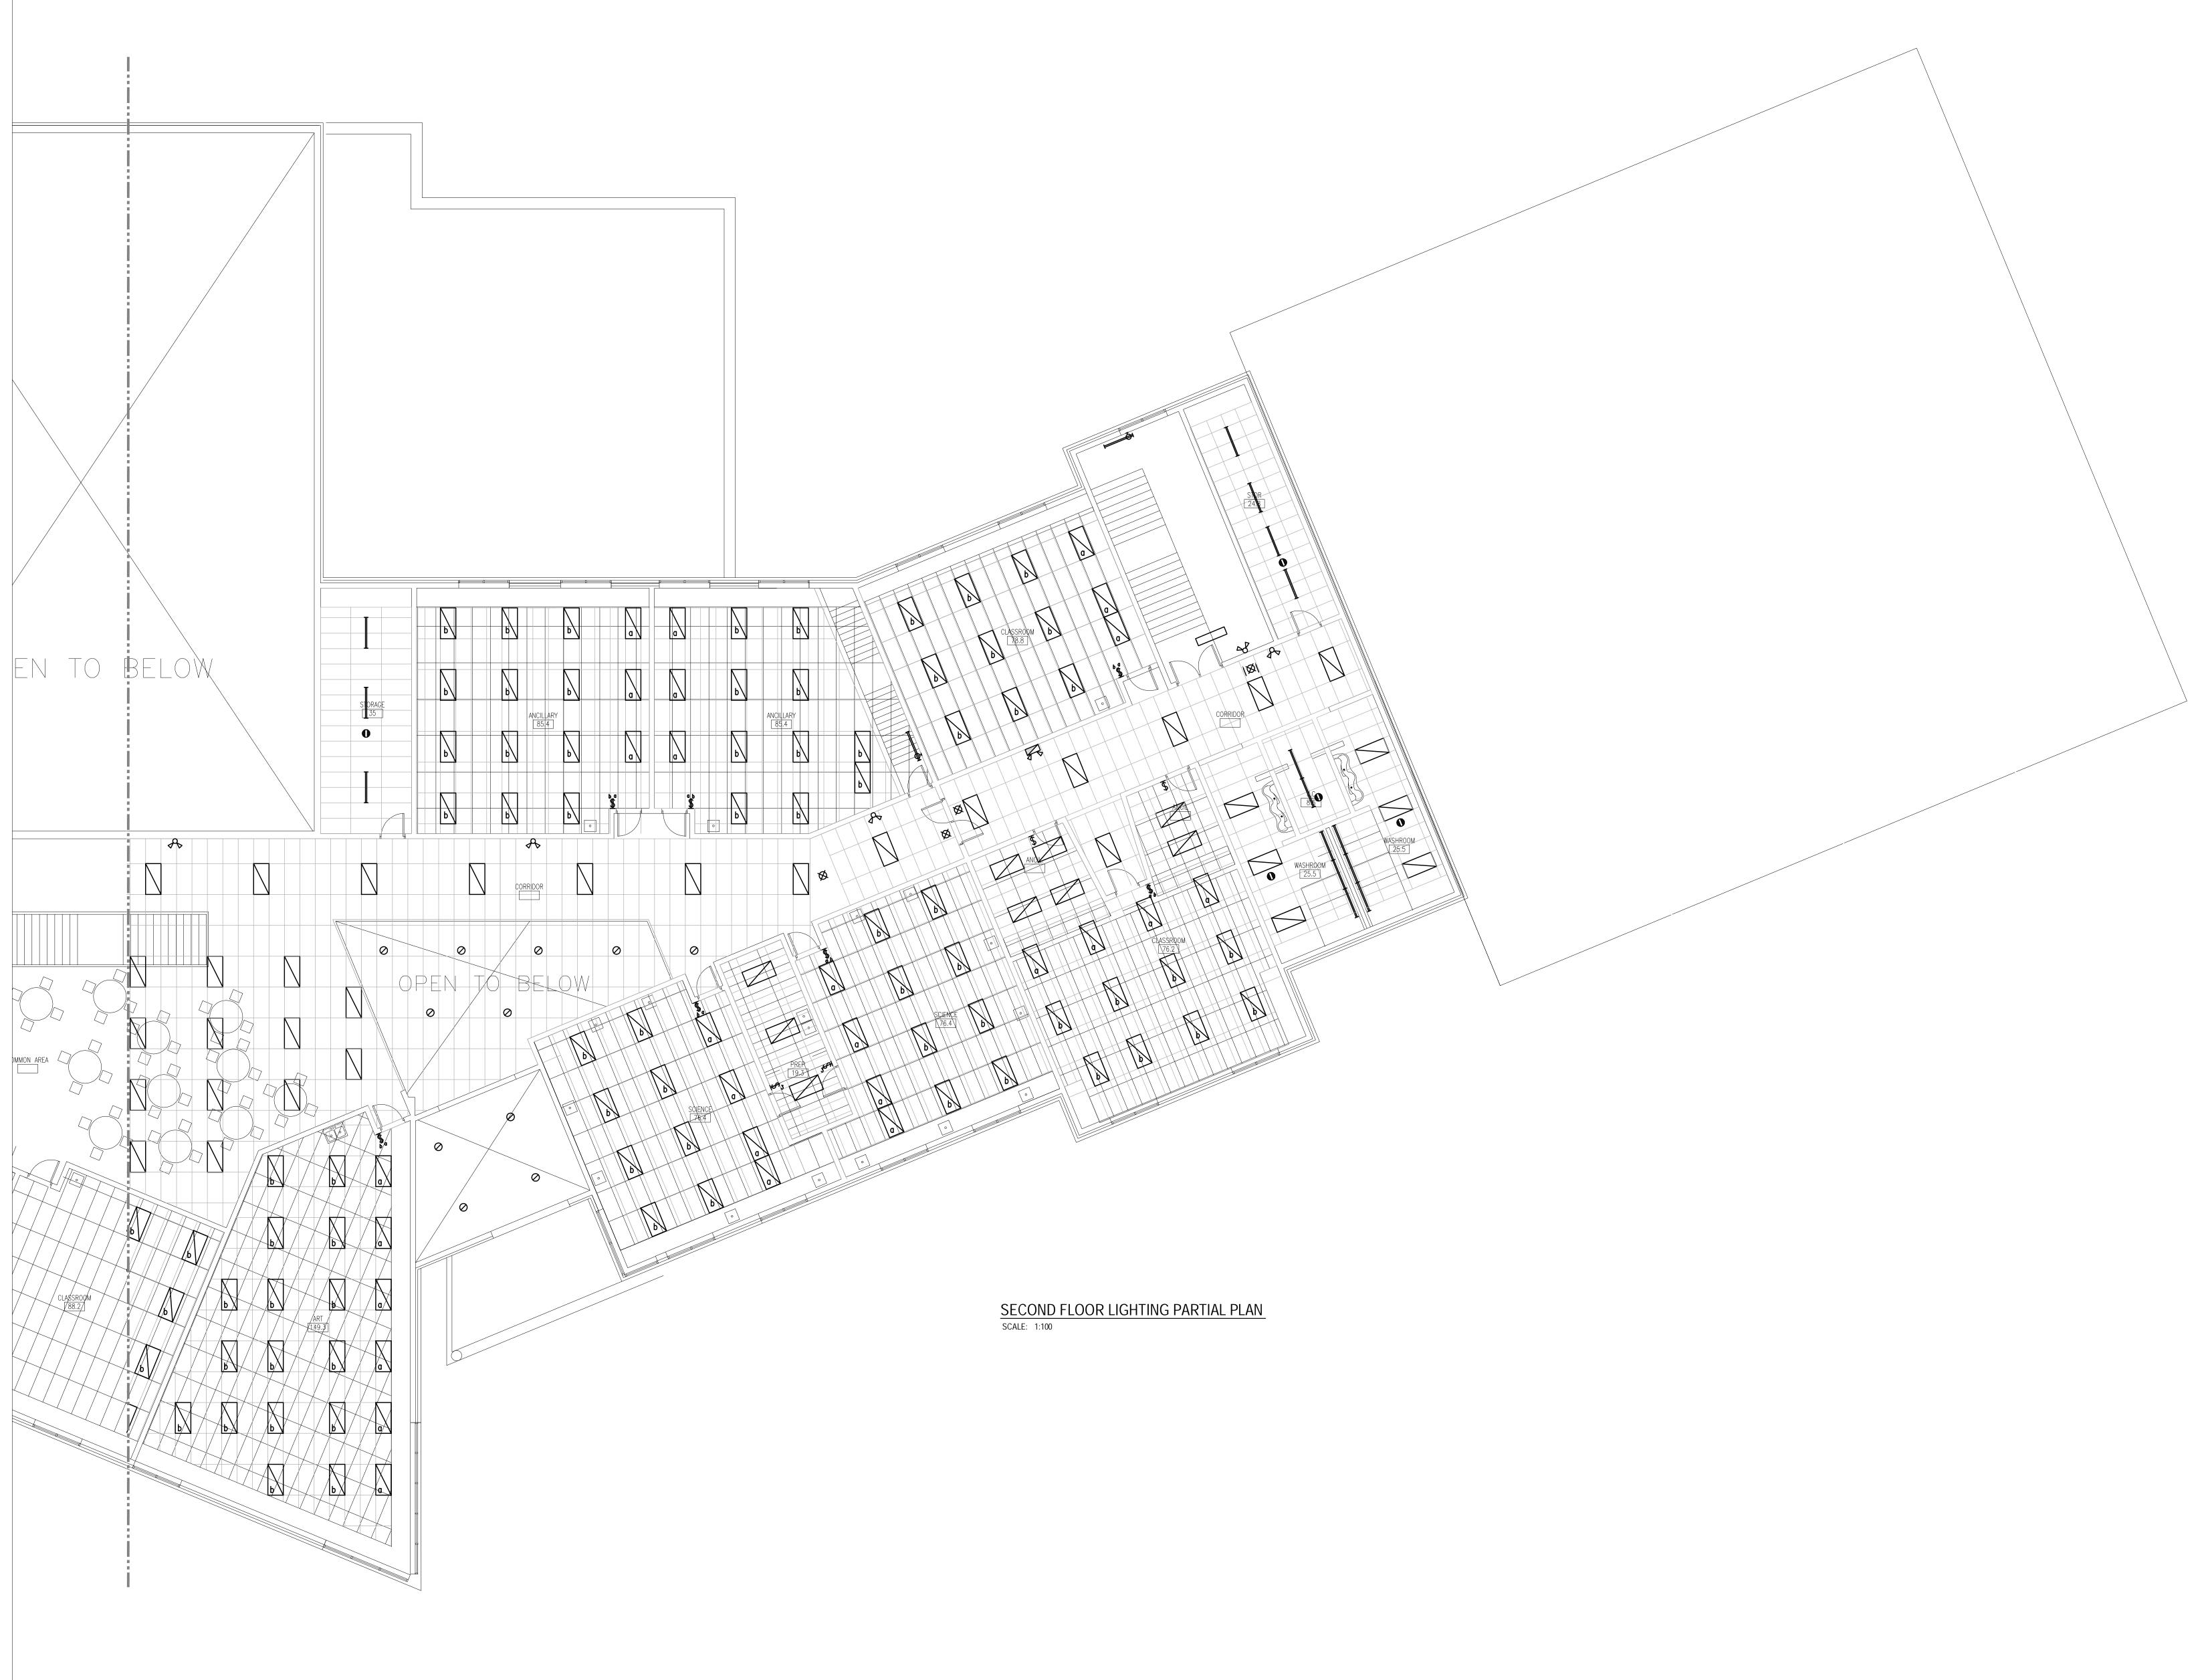

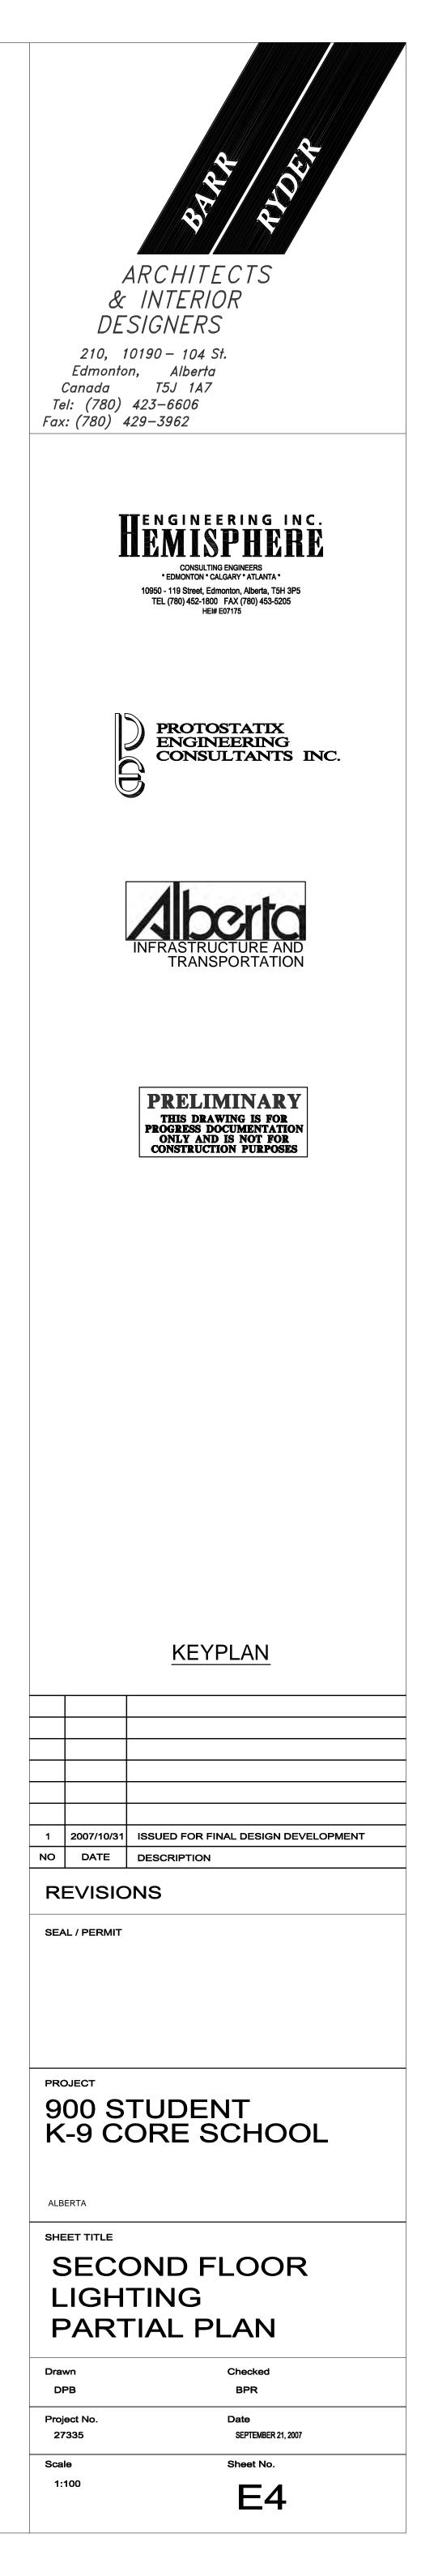





<ol> <li>OVERHEAD PROJECTOR DATA AND POWER CONNECTION. COORDINATE AND CONFIRM EXACT LOCATION OF PROJECTOR WITH GENERAL CONTRACTOR PRIOR TO ROUGH-IN.</li> <li>LADDER TYPE CABLE TRAY ACCESSIBLE FROM CEILING SPACE.</li> <li>JUNCTION BOX FOR POWER CONNECTION TO MODULAR CLASSROOMS.</li> <li>MOTORIZED BACKBOARDS.</li> <li>CONTROLLERS: UP, DOWN AND STOP FOR MOTORIZED BACKBOARDS.</li> <li>CONTROLLERS: UP, DOWN AND STOP FOR MOTORIZED BACKBOARDS.</li> <li>JUNCTION BOX FOR CONTROL OF SCOREBOARD.</li> <li>JUNCTION BOX FOR CONTROL OF SHOT CLOCK MOUNTED AT 2400mm AFF.</li> <li>JUNCTION BOX FOR POWER TO SHOT CLOCK.</li> <li>JUNCTION BOX FOR POWER TO SHOT CLOCK.</li> <li>JUNCTION BOX FOR POWER TO SCOREBOARD MOUNTED AT 3300mm AFF.</li> <li>JUNCTION BOX FOR POWER TO SCOREBOARD MOUNTED AT 3300mm AFF.</li> <li>JUNCTION BOX FOR POWER TO SCOREBOARD MOUNTED AT 3300mm AFF.</li> <li>JUNCTION BOX FOR POWER TO SCOREBOARD MOUNTED AT 3300mm AFF.</li> <li>JUNCTION BOX FOR POWER TO SCOREBOARD MOUNTED AT 3300mm AFF.</li> <li>JUNCTION BOX FOR POWER TO SCOREBOARD MOUNTED AT 3300mm AFF.</li> <li>JUNCTION BOX FOR POWER TO SCOREBOARD MOUNTED AT 3300mm AFF.</li> <li>RUN 21mmC TO AMPLIFIER IN PHYS-ED OFFICE.</li> <li>TWISTLOCK RECEPTACLES FOR FORESTAGE LIGHTING - REFER TO DETAIL.</li> <li>RUN TO SUB DISTRIBUTION PANEL 'A'.</li> </ol>	ARCHITECTS & INTERIOR DESIGNERS 210, 10190 - 104 St. Edmonton, Alberta Canada T5J 1A7 Tel: (780) 423-6606 Fax: (780) 429-3962
<ul> <li>(14) RUN TO SUB DISTRIBUTION PANEL 'B'.</li> <li>(15) BRANCH CIRCUIT PANEL.</li> <li>(16) MAIN DISTRIBUTION CENTRE.</li> <li>(17) JUNCTION BOX FOR DOOR SENTRONICS. TIE INTO FIRE ALARM SYSTEM.</li> </ul>	<b>THE NGINEERING INC.</b> <b>CONSULTING ENGINEERS</b> * EDMONTON * CALGARY * ATLANTA * 10950 - 119 Street, Edmonton, Alberta, T5H 3P5 THE STREET, Edmonton, Alberta, T5H 3P5 THE STREET, Edmonton, Alberta, T5H 3P5
	TEL (780) 452-1800 FAX (780) 453-5205 HEI# E07175 PROTOSTATIX ENGINEERING CONSULTANTS INC.
	<b>INFRASTRUCTURE AND</b> TRANSPORTATION
	PRELIMINARY THIS DRAWING IS FOR PROGRESS DOCUMENTATION ONLY AND IS NOT FOR CONSTRUCTION PURPOSES
	<u>KEYPLAN</u>
	1 2007/10/31 ISSUED FOR FINAL DESIGN DEVELOPMENT
	1     2007/10/31     ISSUED FOR FINAL DESIGN DEVELOPMENT       NO     DATE     DESCRIPTION         REVISIONS   SEAL / PERMIT
	PROJECT 900 STUDENT K-9 CORE SCHOOL
	ALBERTA SHEET TITLE MAIN FLOOR POWER & SYSTEMS PARTIAL PLAN
-	Drawn Checked DPB BPR
	Project No. Date 27335 SEPTEMBER 21, 2007 Scale Sheet No. 1:1000 E5




<ul> <li>KEY NOTES:</li> <li>(1) OVERHEAD PROJECTOR DATA AND POWER CONNECTION. COORDINATE AND CONFIRM EXACT LOCATION OF PROJECTOR WITH GENERAL CONTRACTOR PRIOR TO ROUGH-IN.</li> <li>(2) LADDER TYPE CABLE TRAY ACCESSIBLE FROM CEILING SPACE.</li> <li>(3) JUNCTION BOX FOR POWER CONNECTION TO MODULAR CLASSROOMS.</li> <li>(4) MOTORIZED BACKBOARDS.</li> <li>(5) CONTROLLERS: UP, DOWN AND STOP FOR MOTORIZED BACKBOARDS.</li> <li>(6) JUNCTION BOX FOR CONTROL OF SCOREBOARD.</li> <li>(7) JUNCTION BOX FOR CONTROL OF SHOT CLOCK MOUNTED AT 2400mm AFF.</li> <li>(8) JUNCTION BOX FOR CONTROL OF SHOT CLOCK.</li> <li>(9) JUNCTION BOX FOR POWER TO SHOT CLOCK.</li> <li>(9) JUNCTION BOX FOR POWER TO SCOREBOARD MOUNTED AT 3300mm AFF.</li> <li>(10) JUNCTION BOX FOR POWER TO SCOREBOARD MOUNTED AT 3300mm AFF.</li> <li>(11) RUN 21mmC TO AMPLIFIER IN PHYS-ED OFFICE.</li> <li>(12) TWISTLOCK RECEPTACLES FOR FORESTAGE LIGHTING - REFER TO DETAIL.</li> <li>(13) RUN TO SUB DISTRIBUTION PANEL 'A'.</li> <li>(14) RUN TO SUB DISTRIBUTION PANEL 'A'.</li> <li>(15) BRANCH CIRCUIT PANEL.</li> <li>(16) MAIN DISTRIBUTION CENTRE.</li> <li>(17) JUNCTION BOX FOR DOOR SENTRONICS. TIE INTO FIRE ALARM SYSTEM.</li> </ul>	ARCHITECTS ARCHITECTS BARCHITECTS BARCHITECTS BARCHITECTS BARCHITECTS BARCHITECTS ARCHITECTS ARCHITECTS ARCHIT
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	PROJECT 900 STUDENT K-9 CORE SCHOOL
	ALBERTA SHEET TITLE MAIN FLOOR POWER & SYSTEMS PARTIAL PLAN
	Drawn     Checked       DPB     BPR       Project No.     Date       27335     SEPTEMBER 21, 2007
	27335 SEPTEMBER 21, 2007 Scale Sheet No. 1:1000 E6



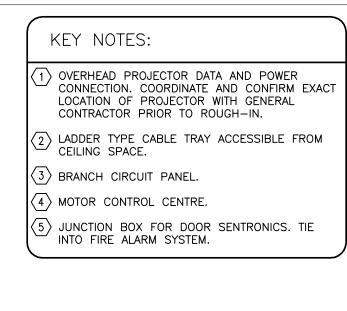

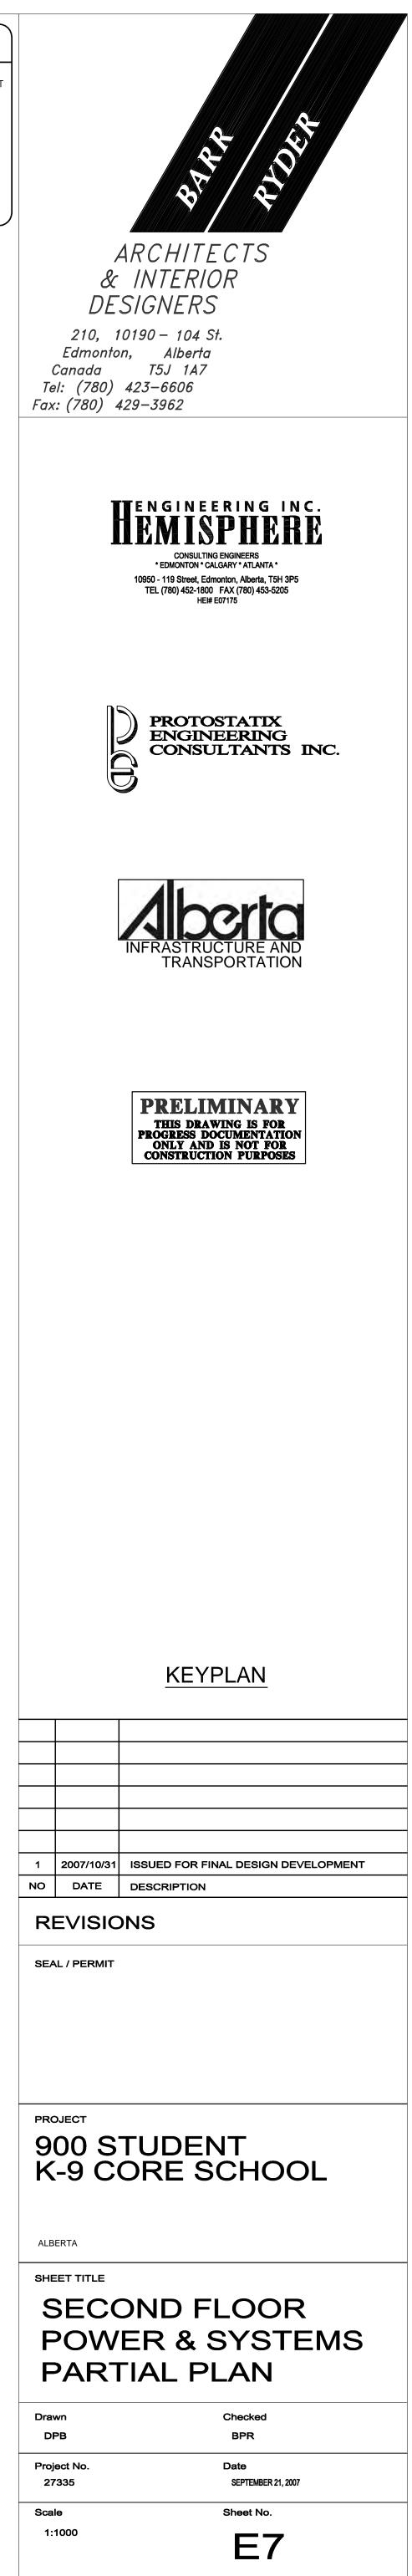

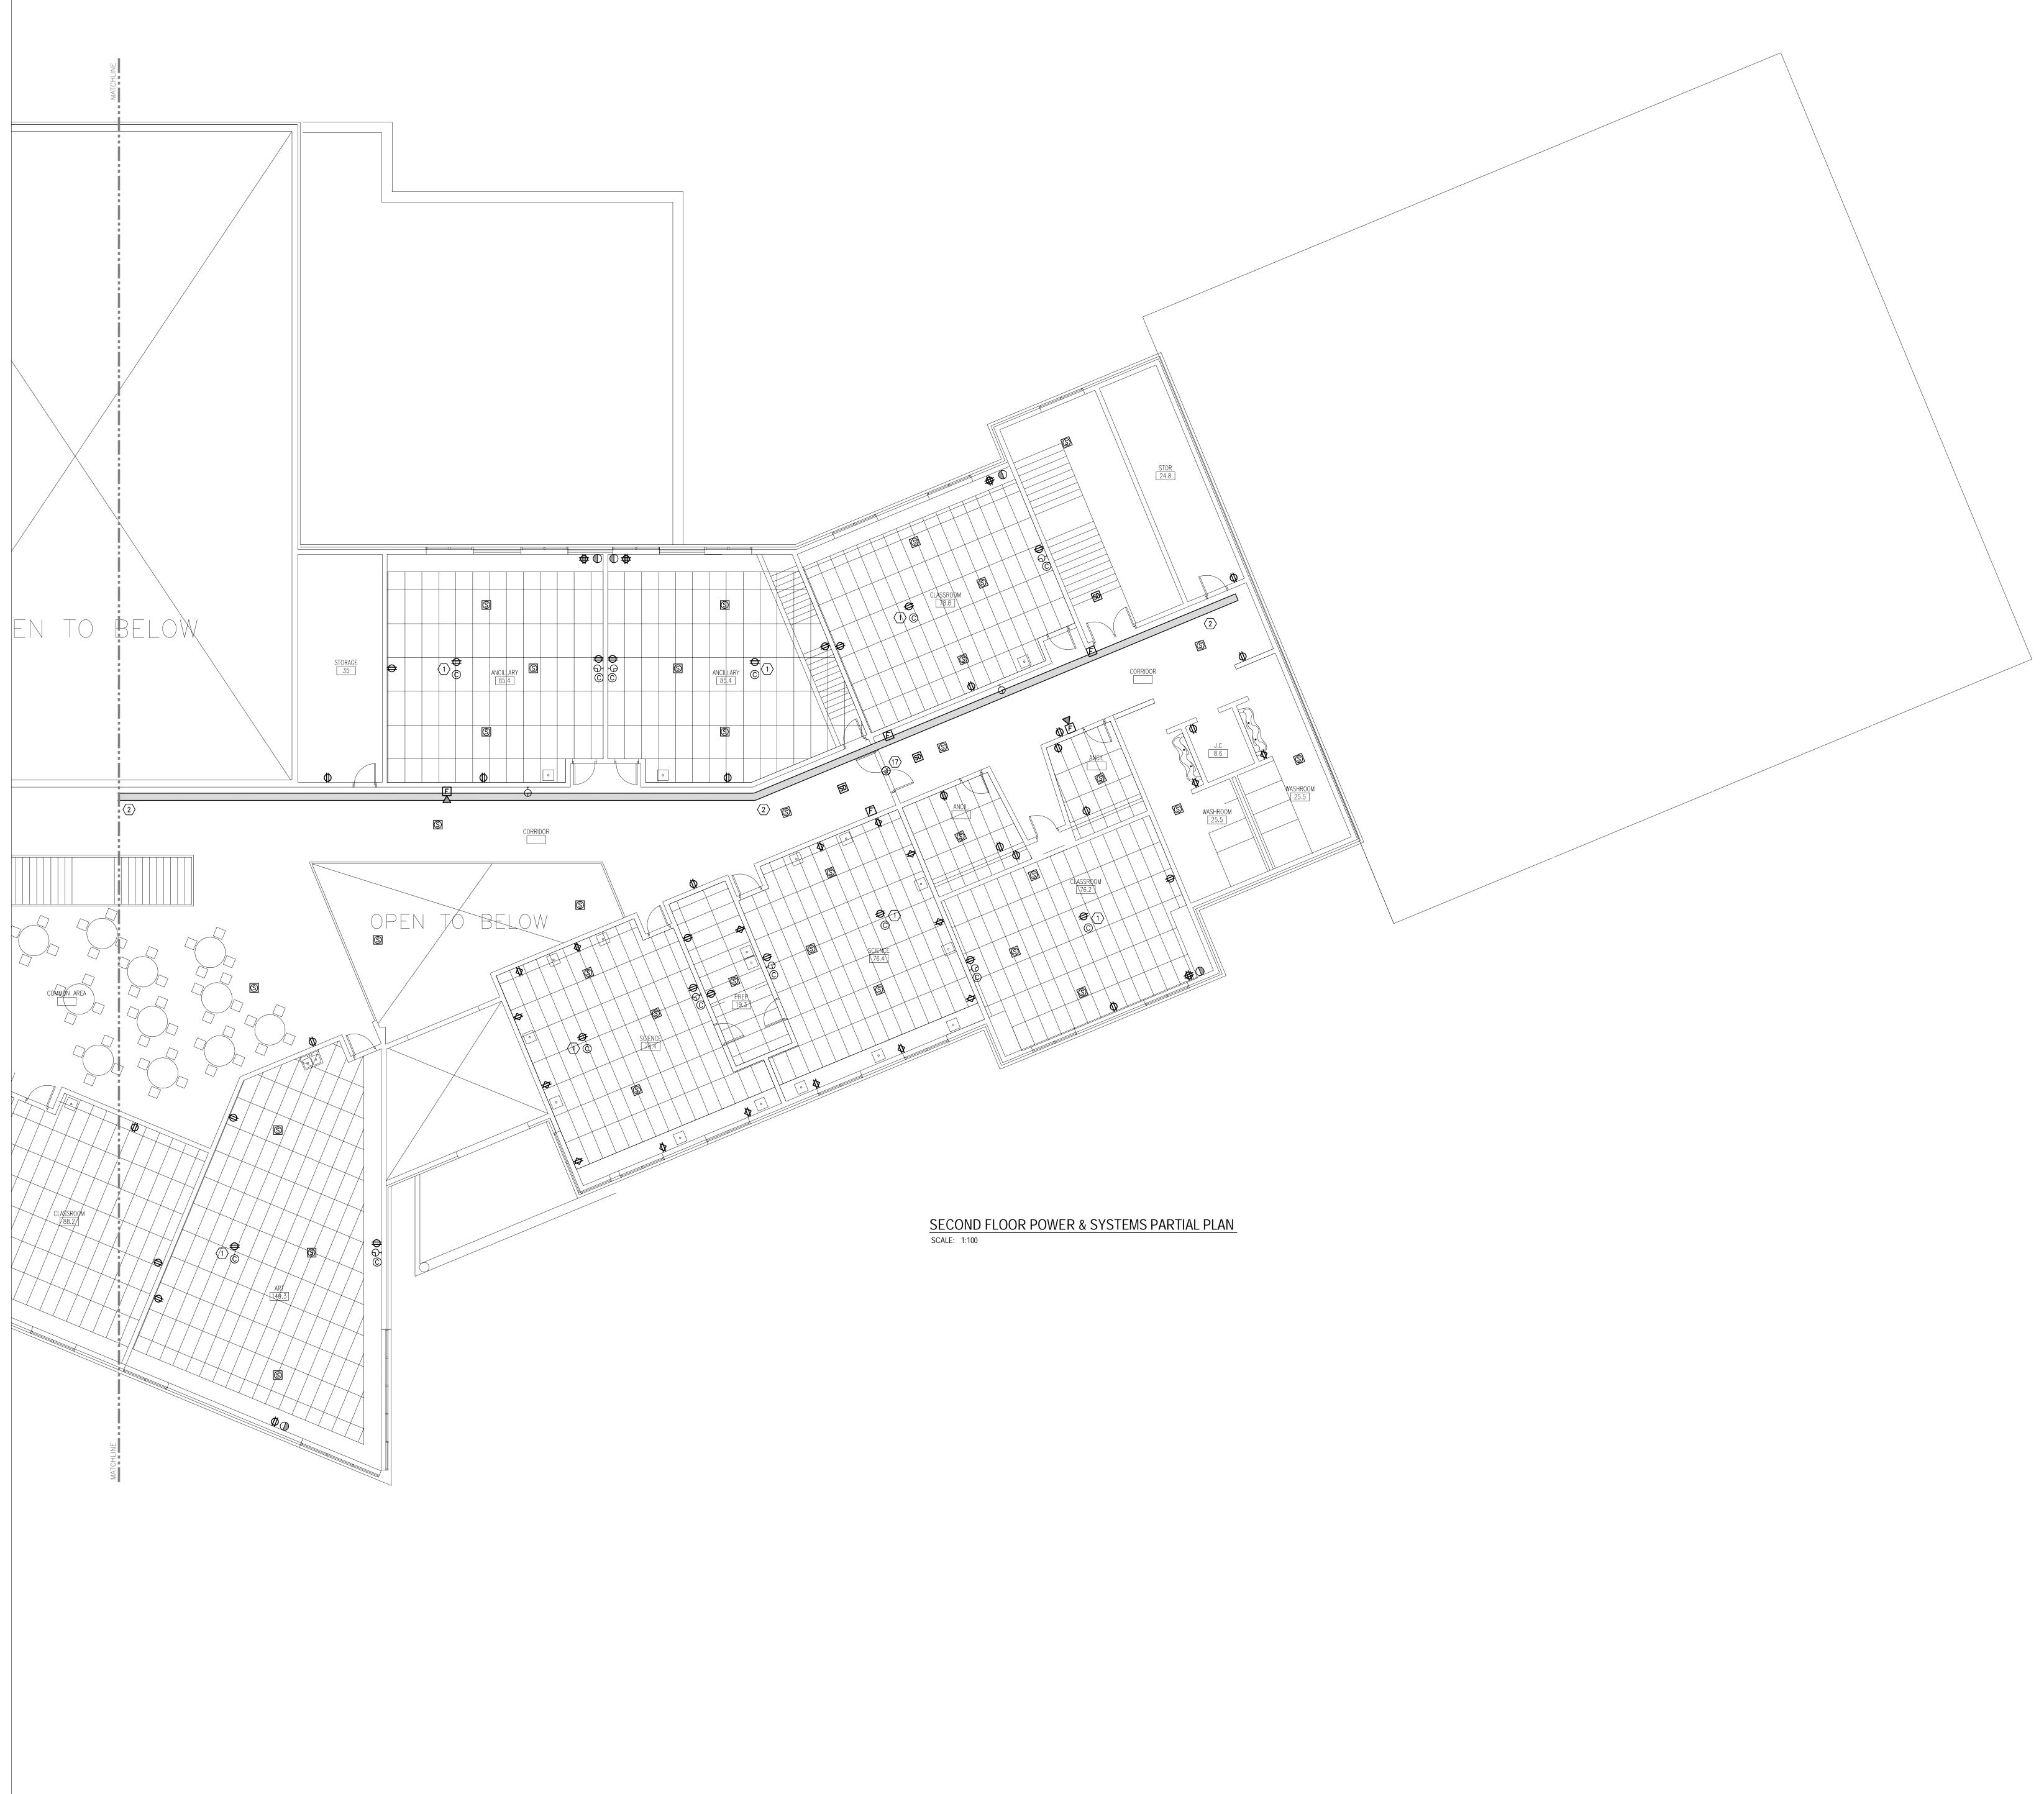

KEY NOTES:
(1) OVERHEAD PROJECTOR DATA AND POWER CONNECTION. COORDINATE AND CONFIRM EXACT LOCATION OF PROJECTOR WITH GENERAL CONTRACTOR PRIOR TO ROUGH-IN.
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3 BRANCH CIRCUIT PANEL.
4 MOTOR CONTROL CENTRE.
5 JUNCTION BOX FOR DOOR SENTRONICS. TIE INTO FIRE ALARM SYSTEM.

