

PROPOSED NEW K-9 (900 STUDENTS) CORE SCHOOL Design Development Report

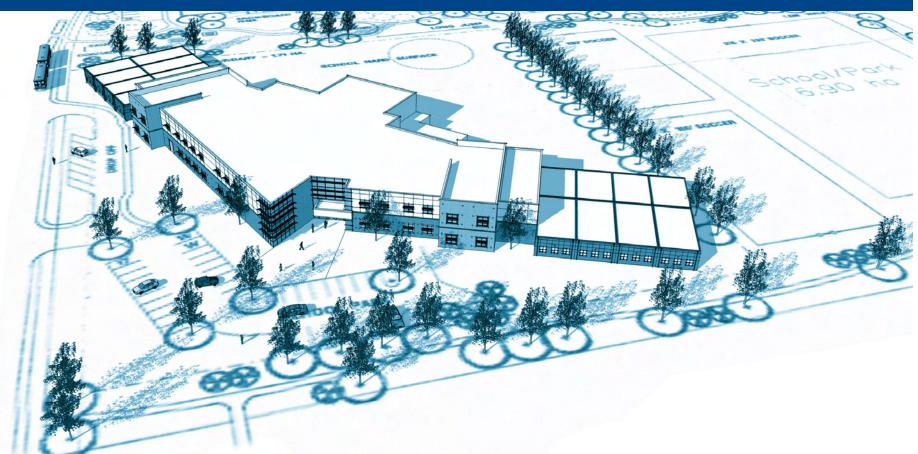

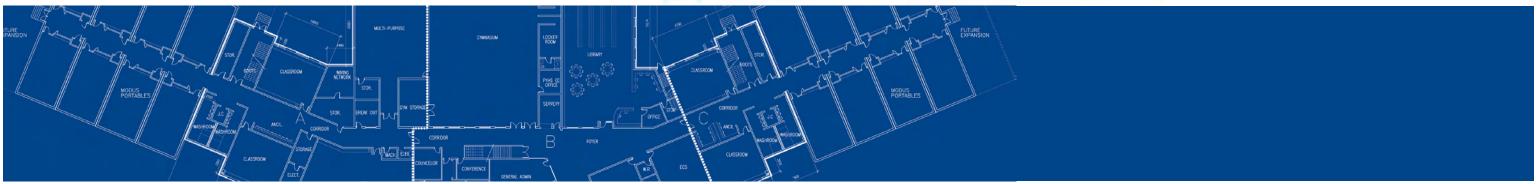






Alberta Infrastructure and Transportation





"Helping Build Communities"

Project No. 27340


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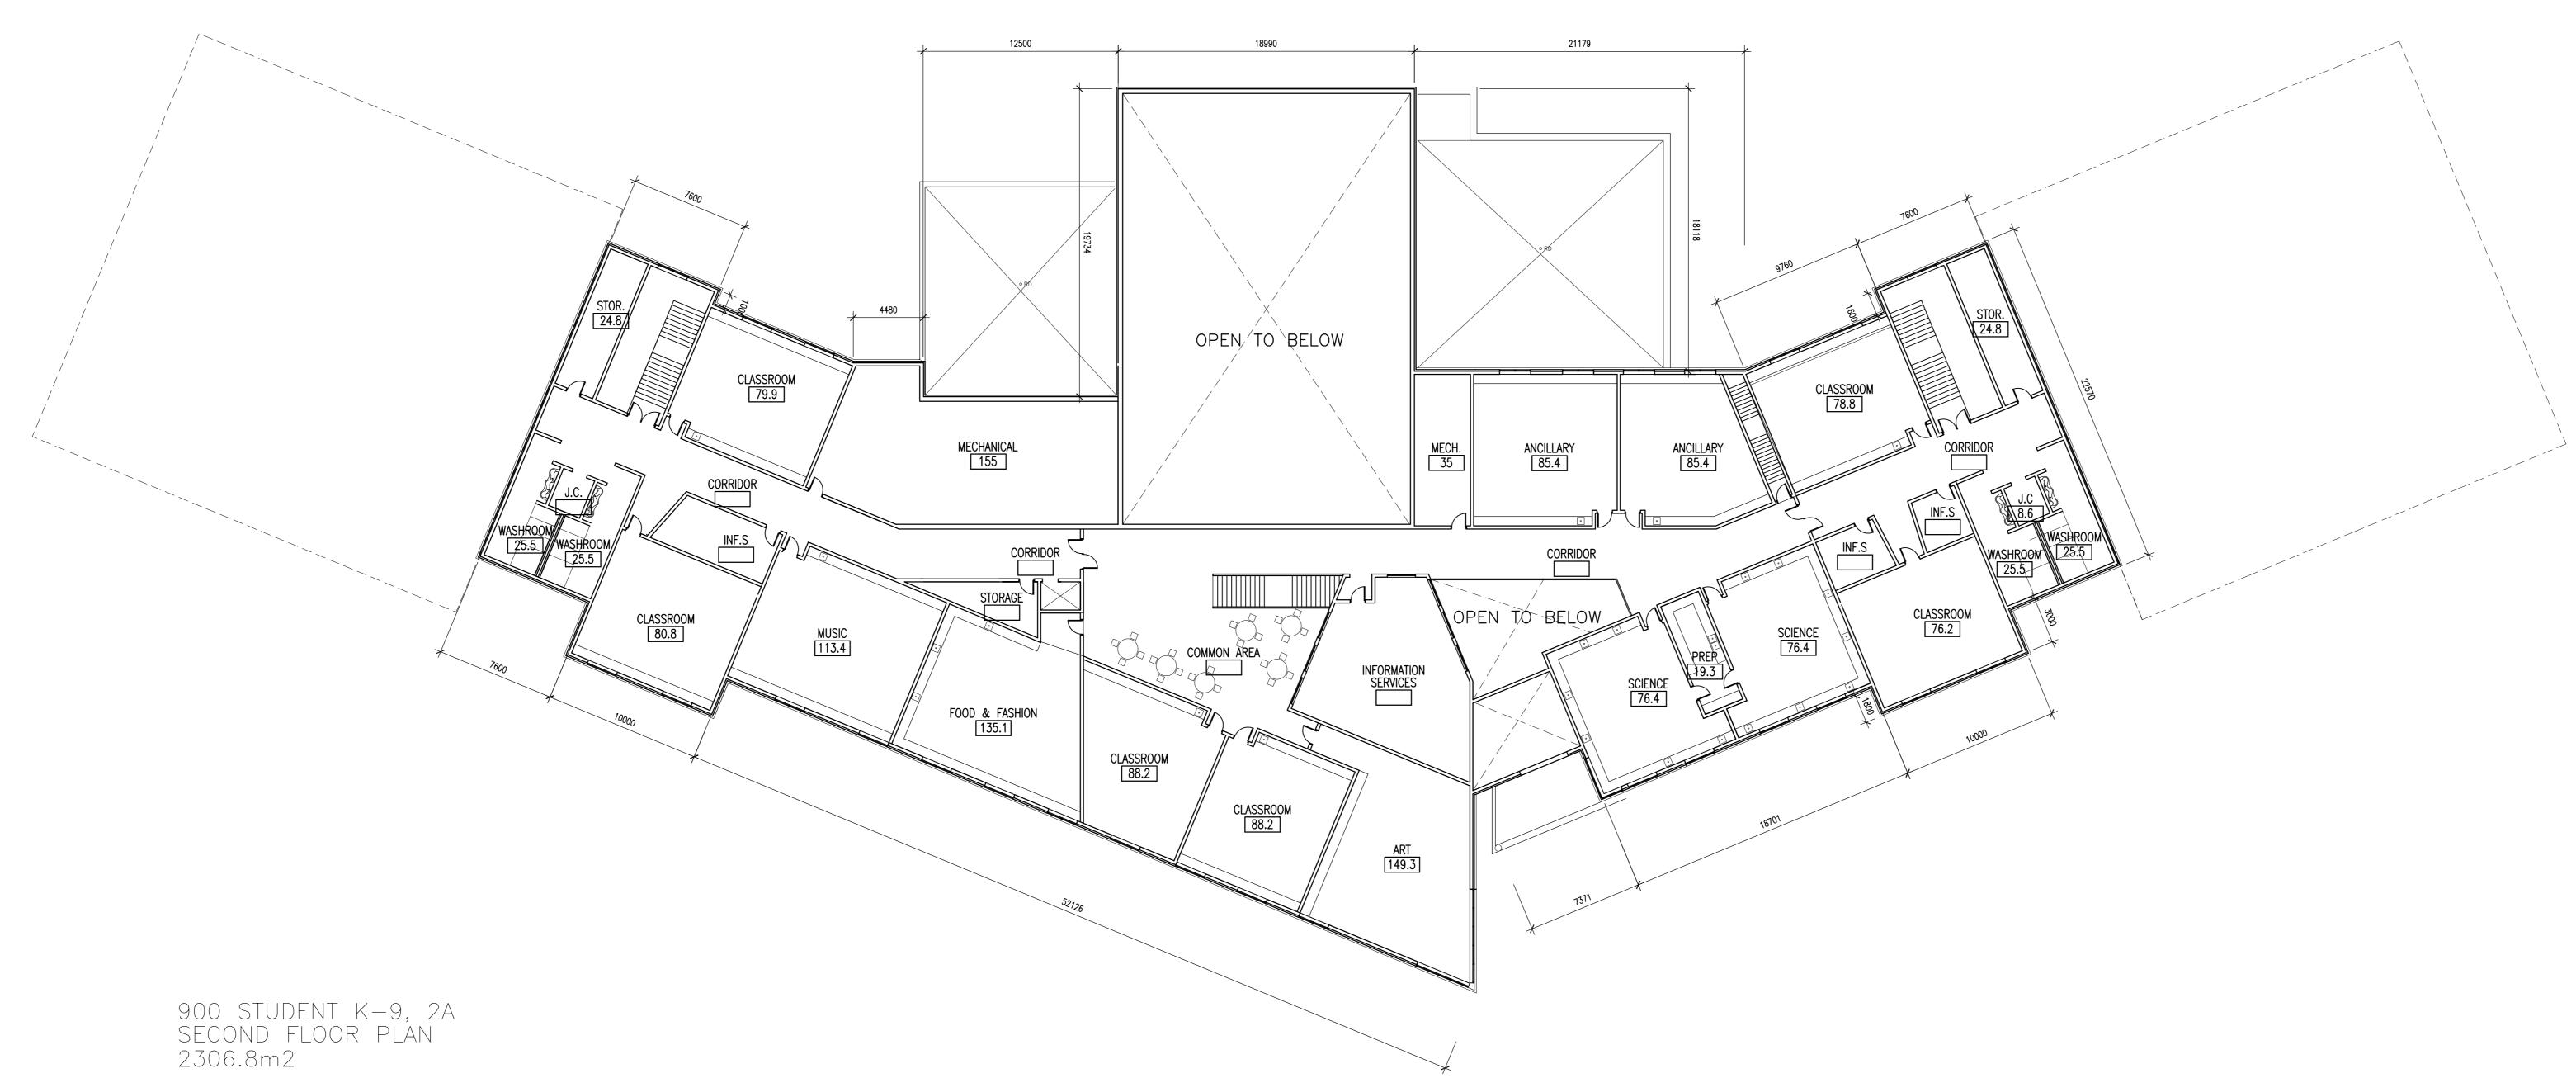


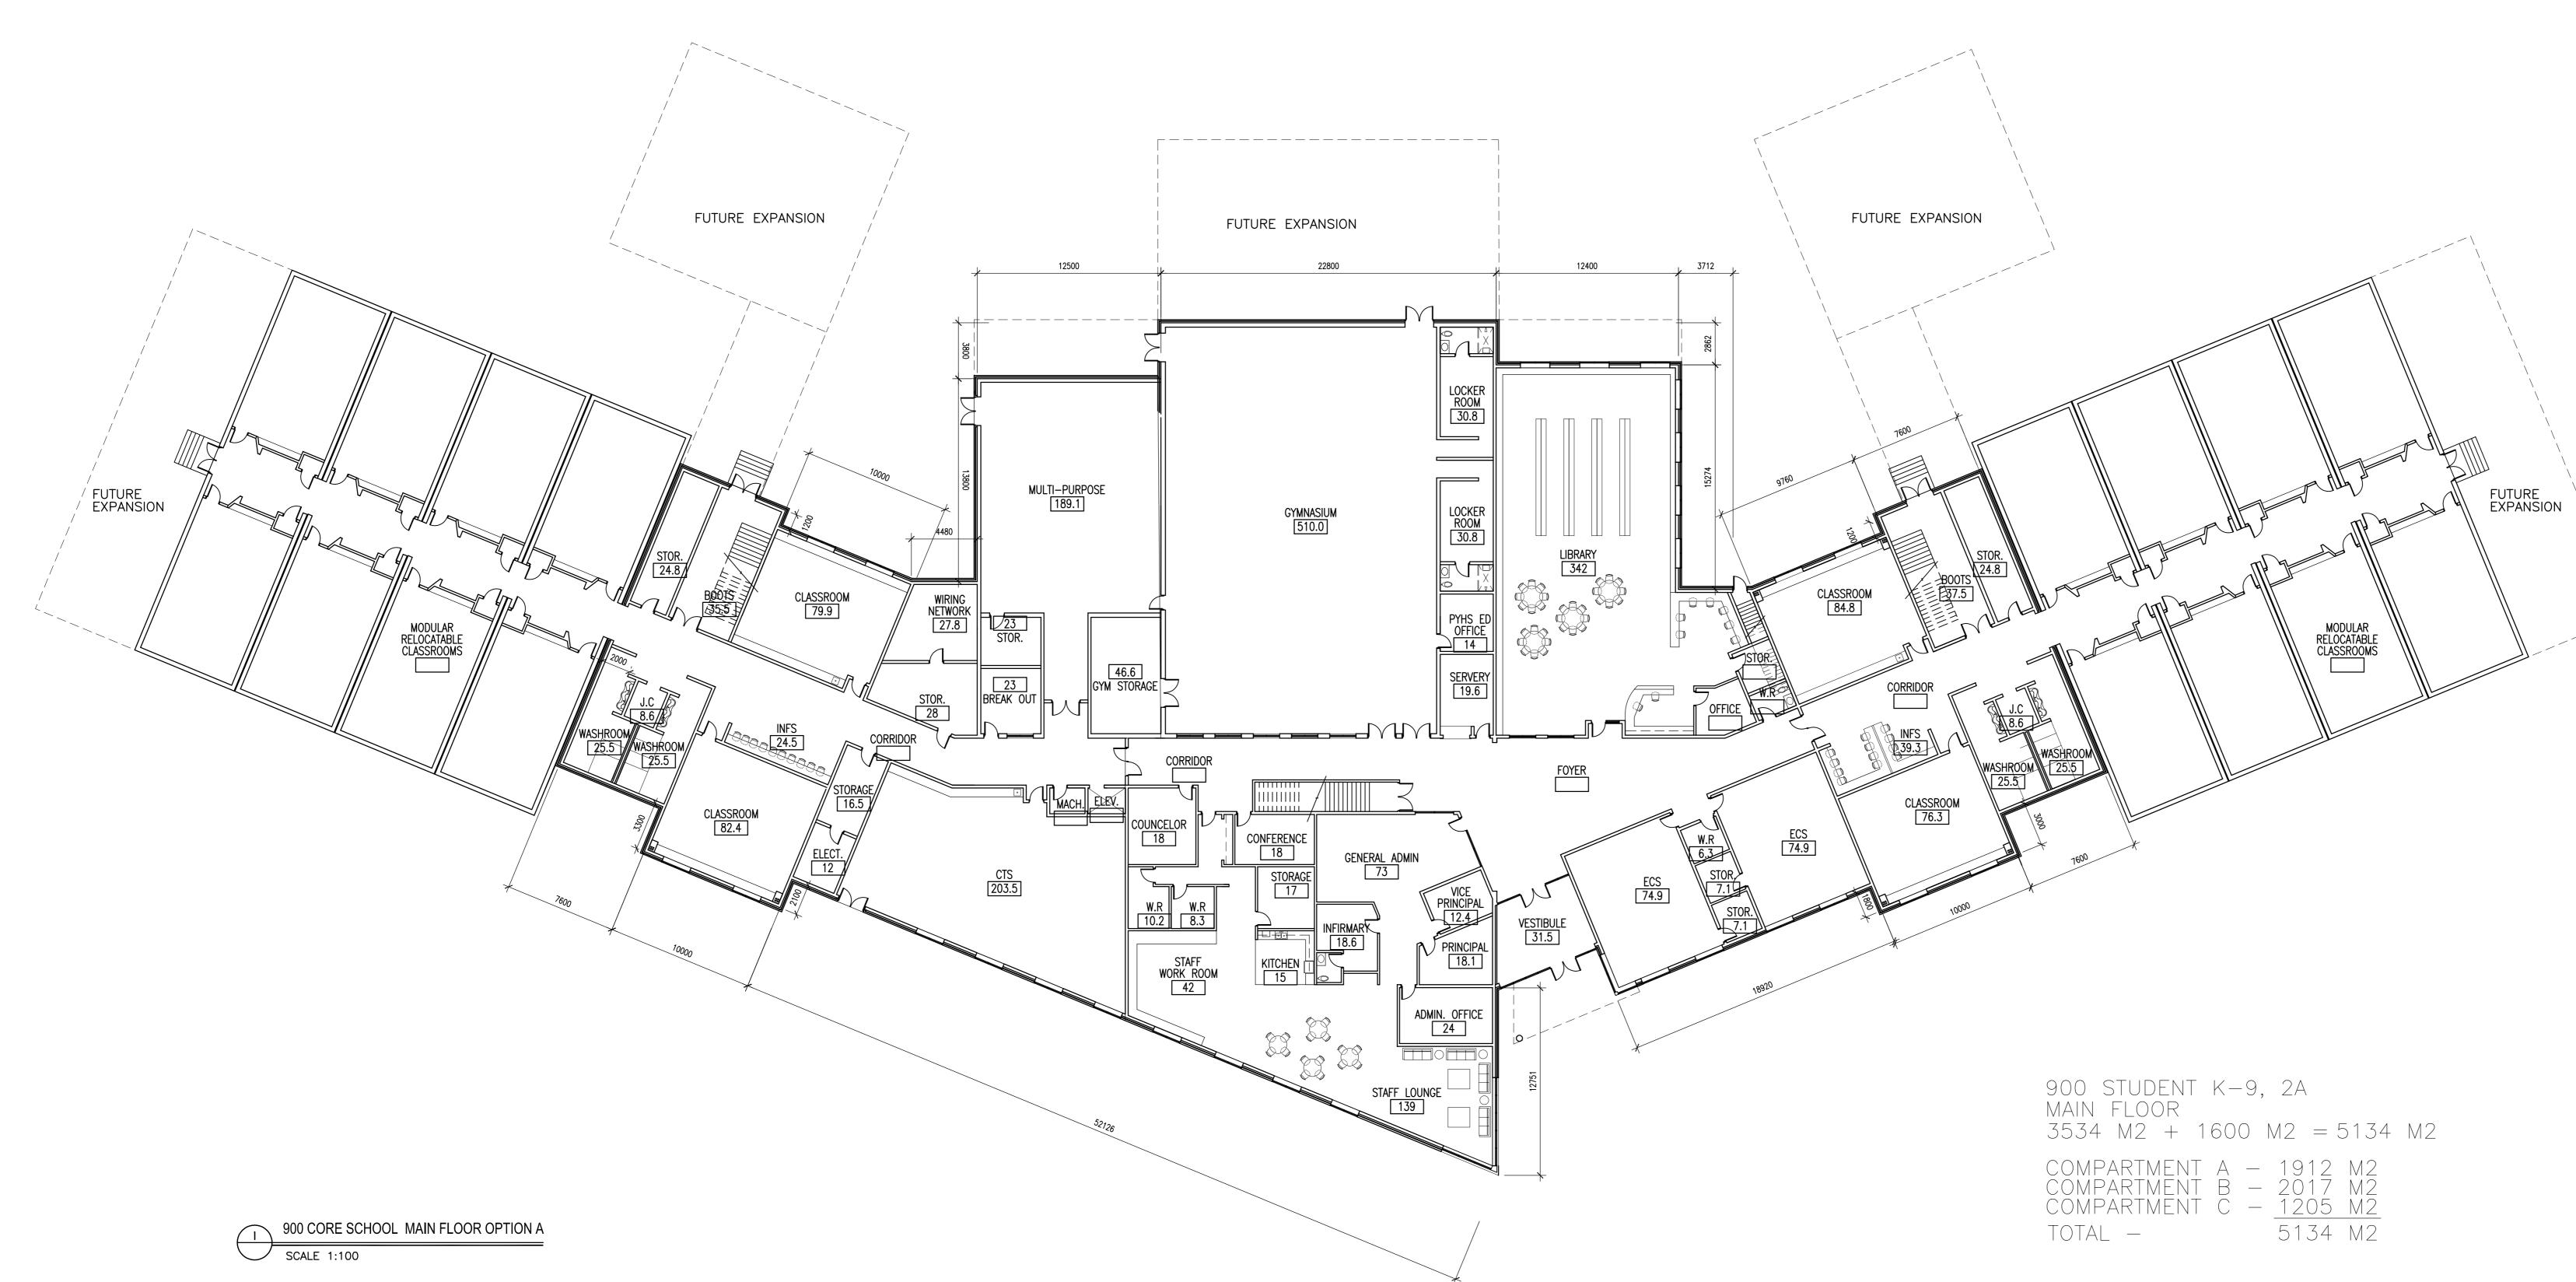
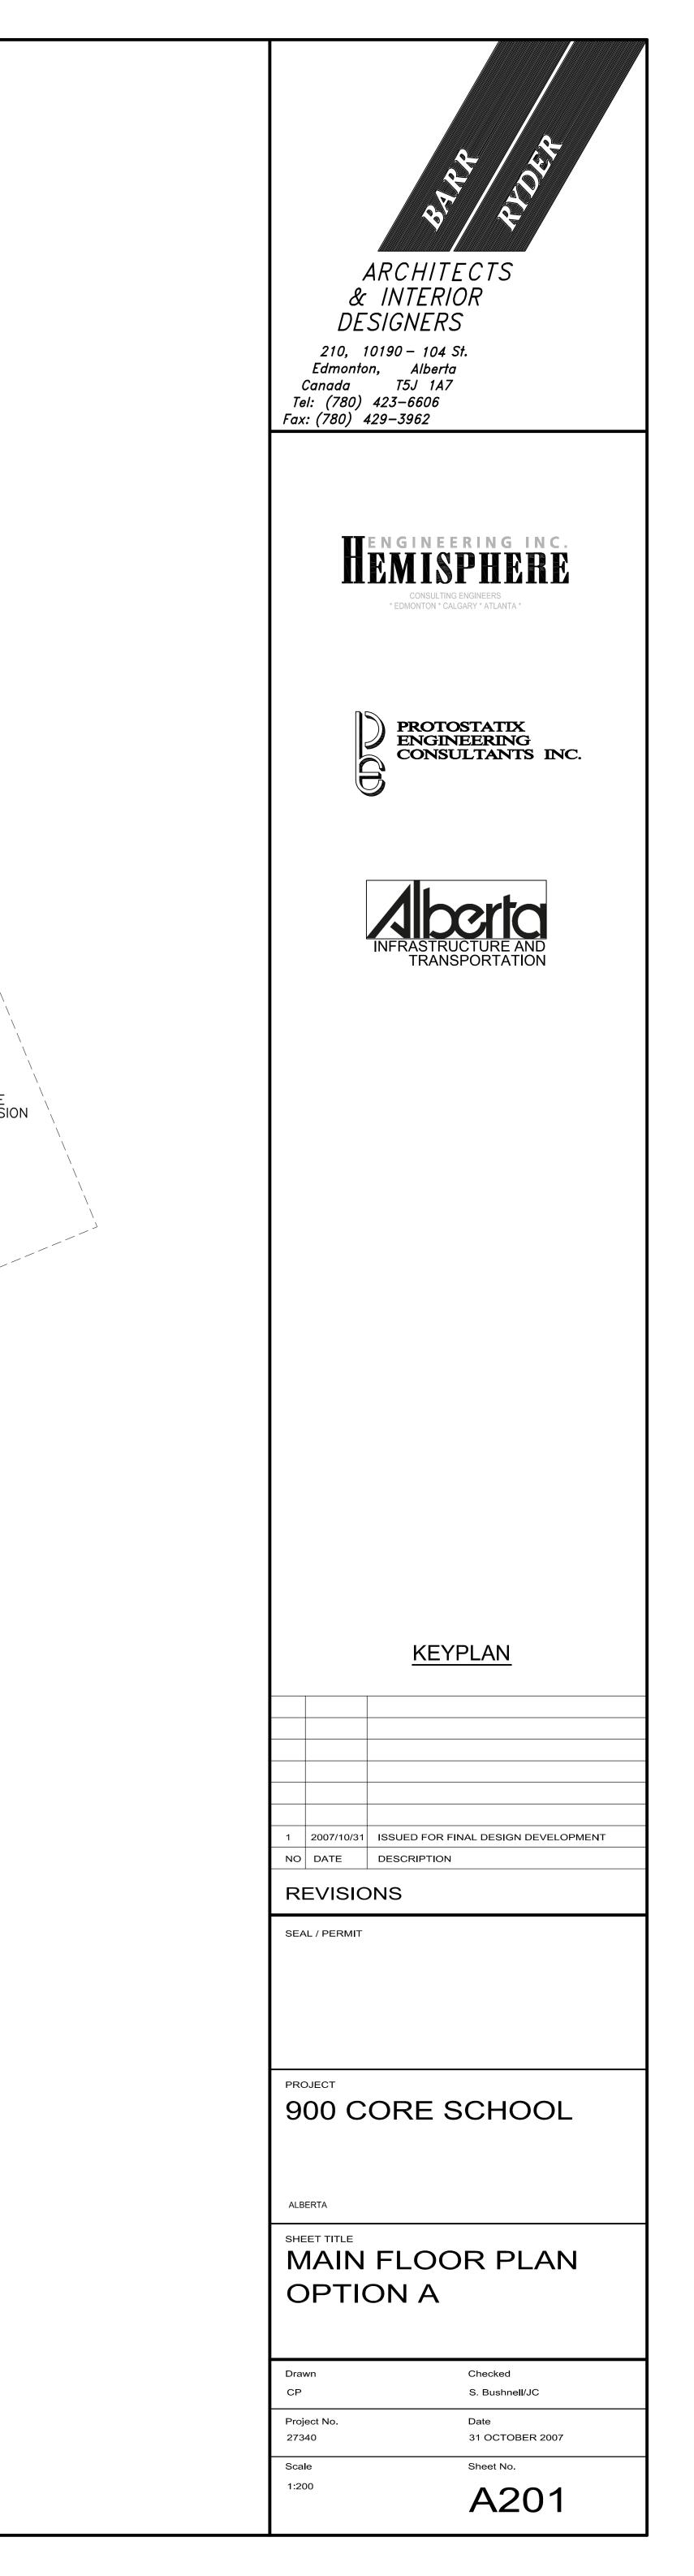
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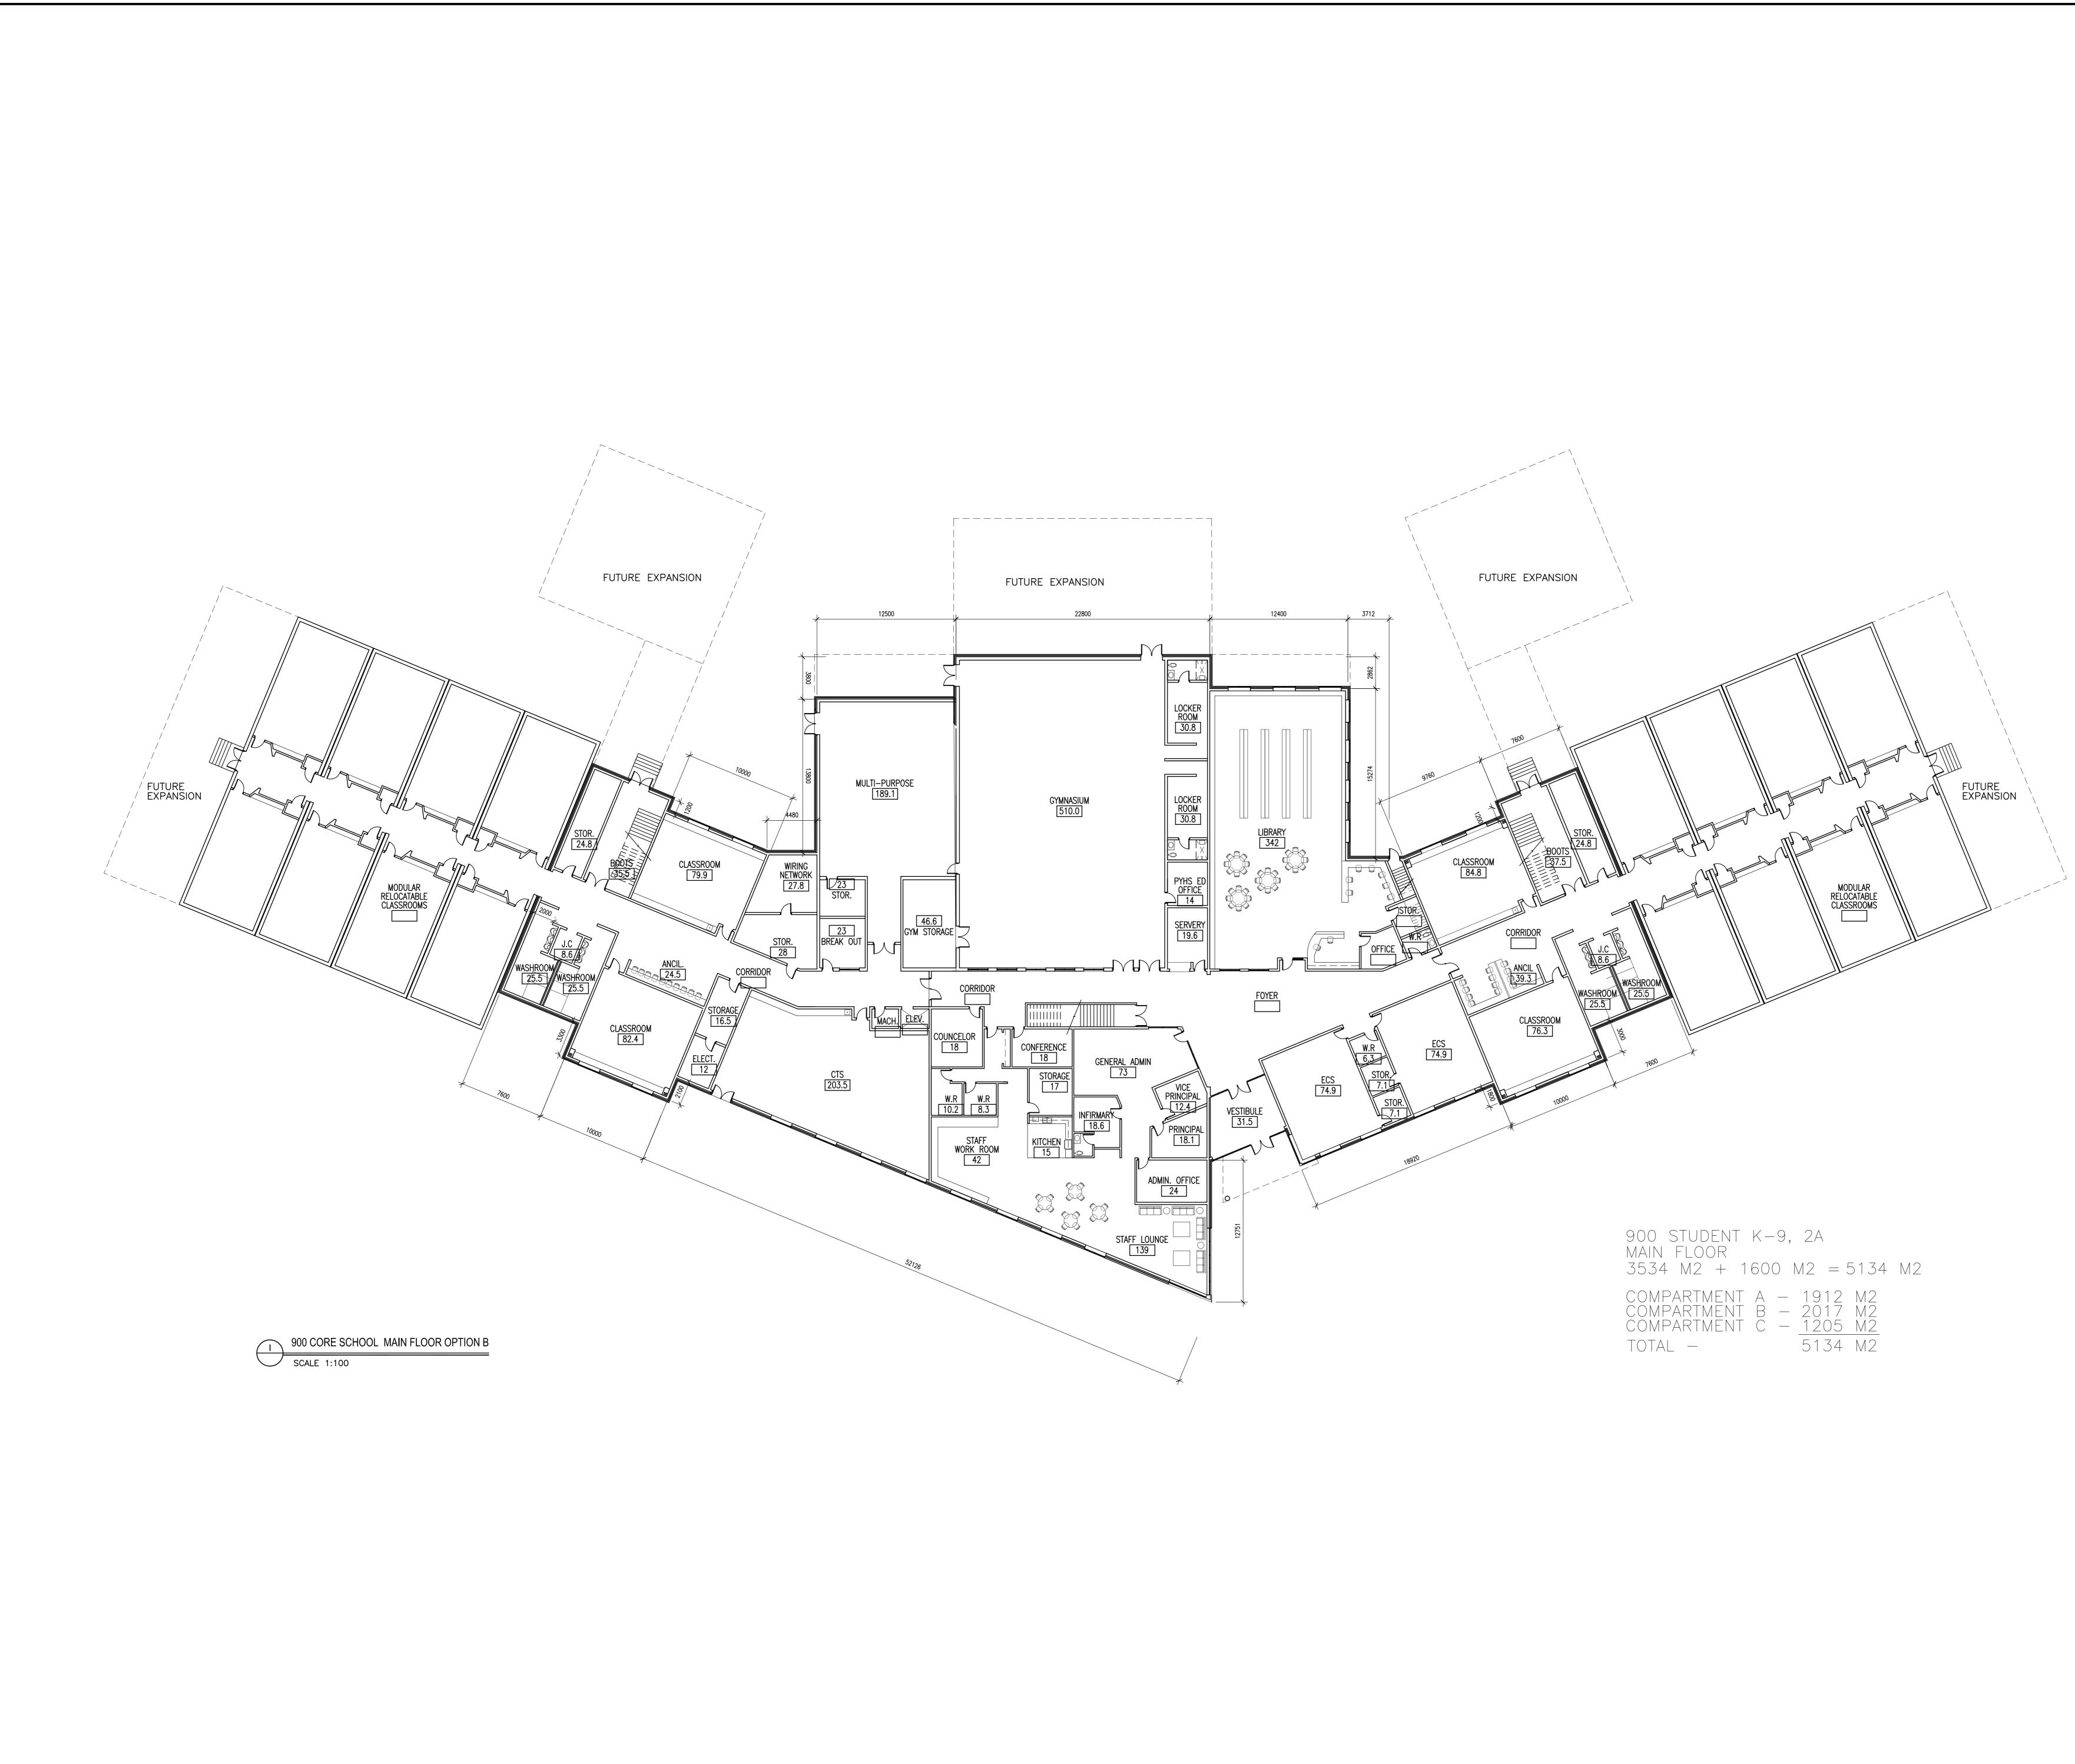


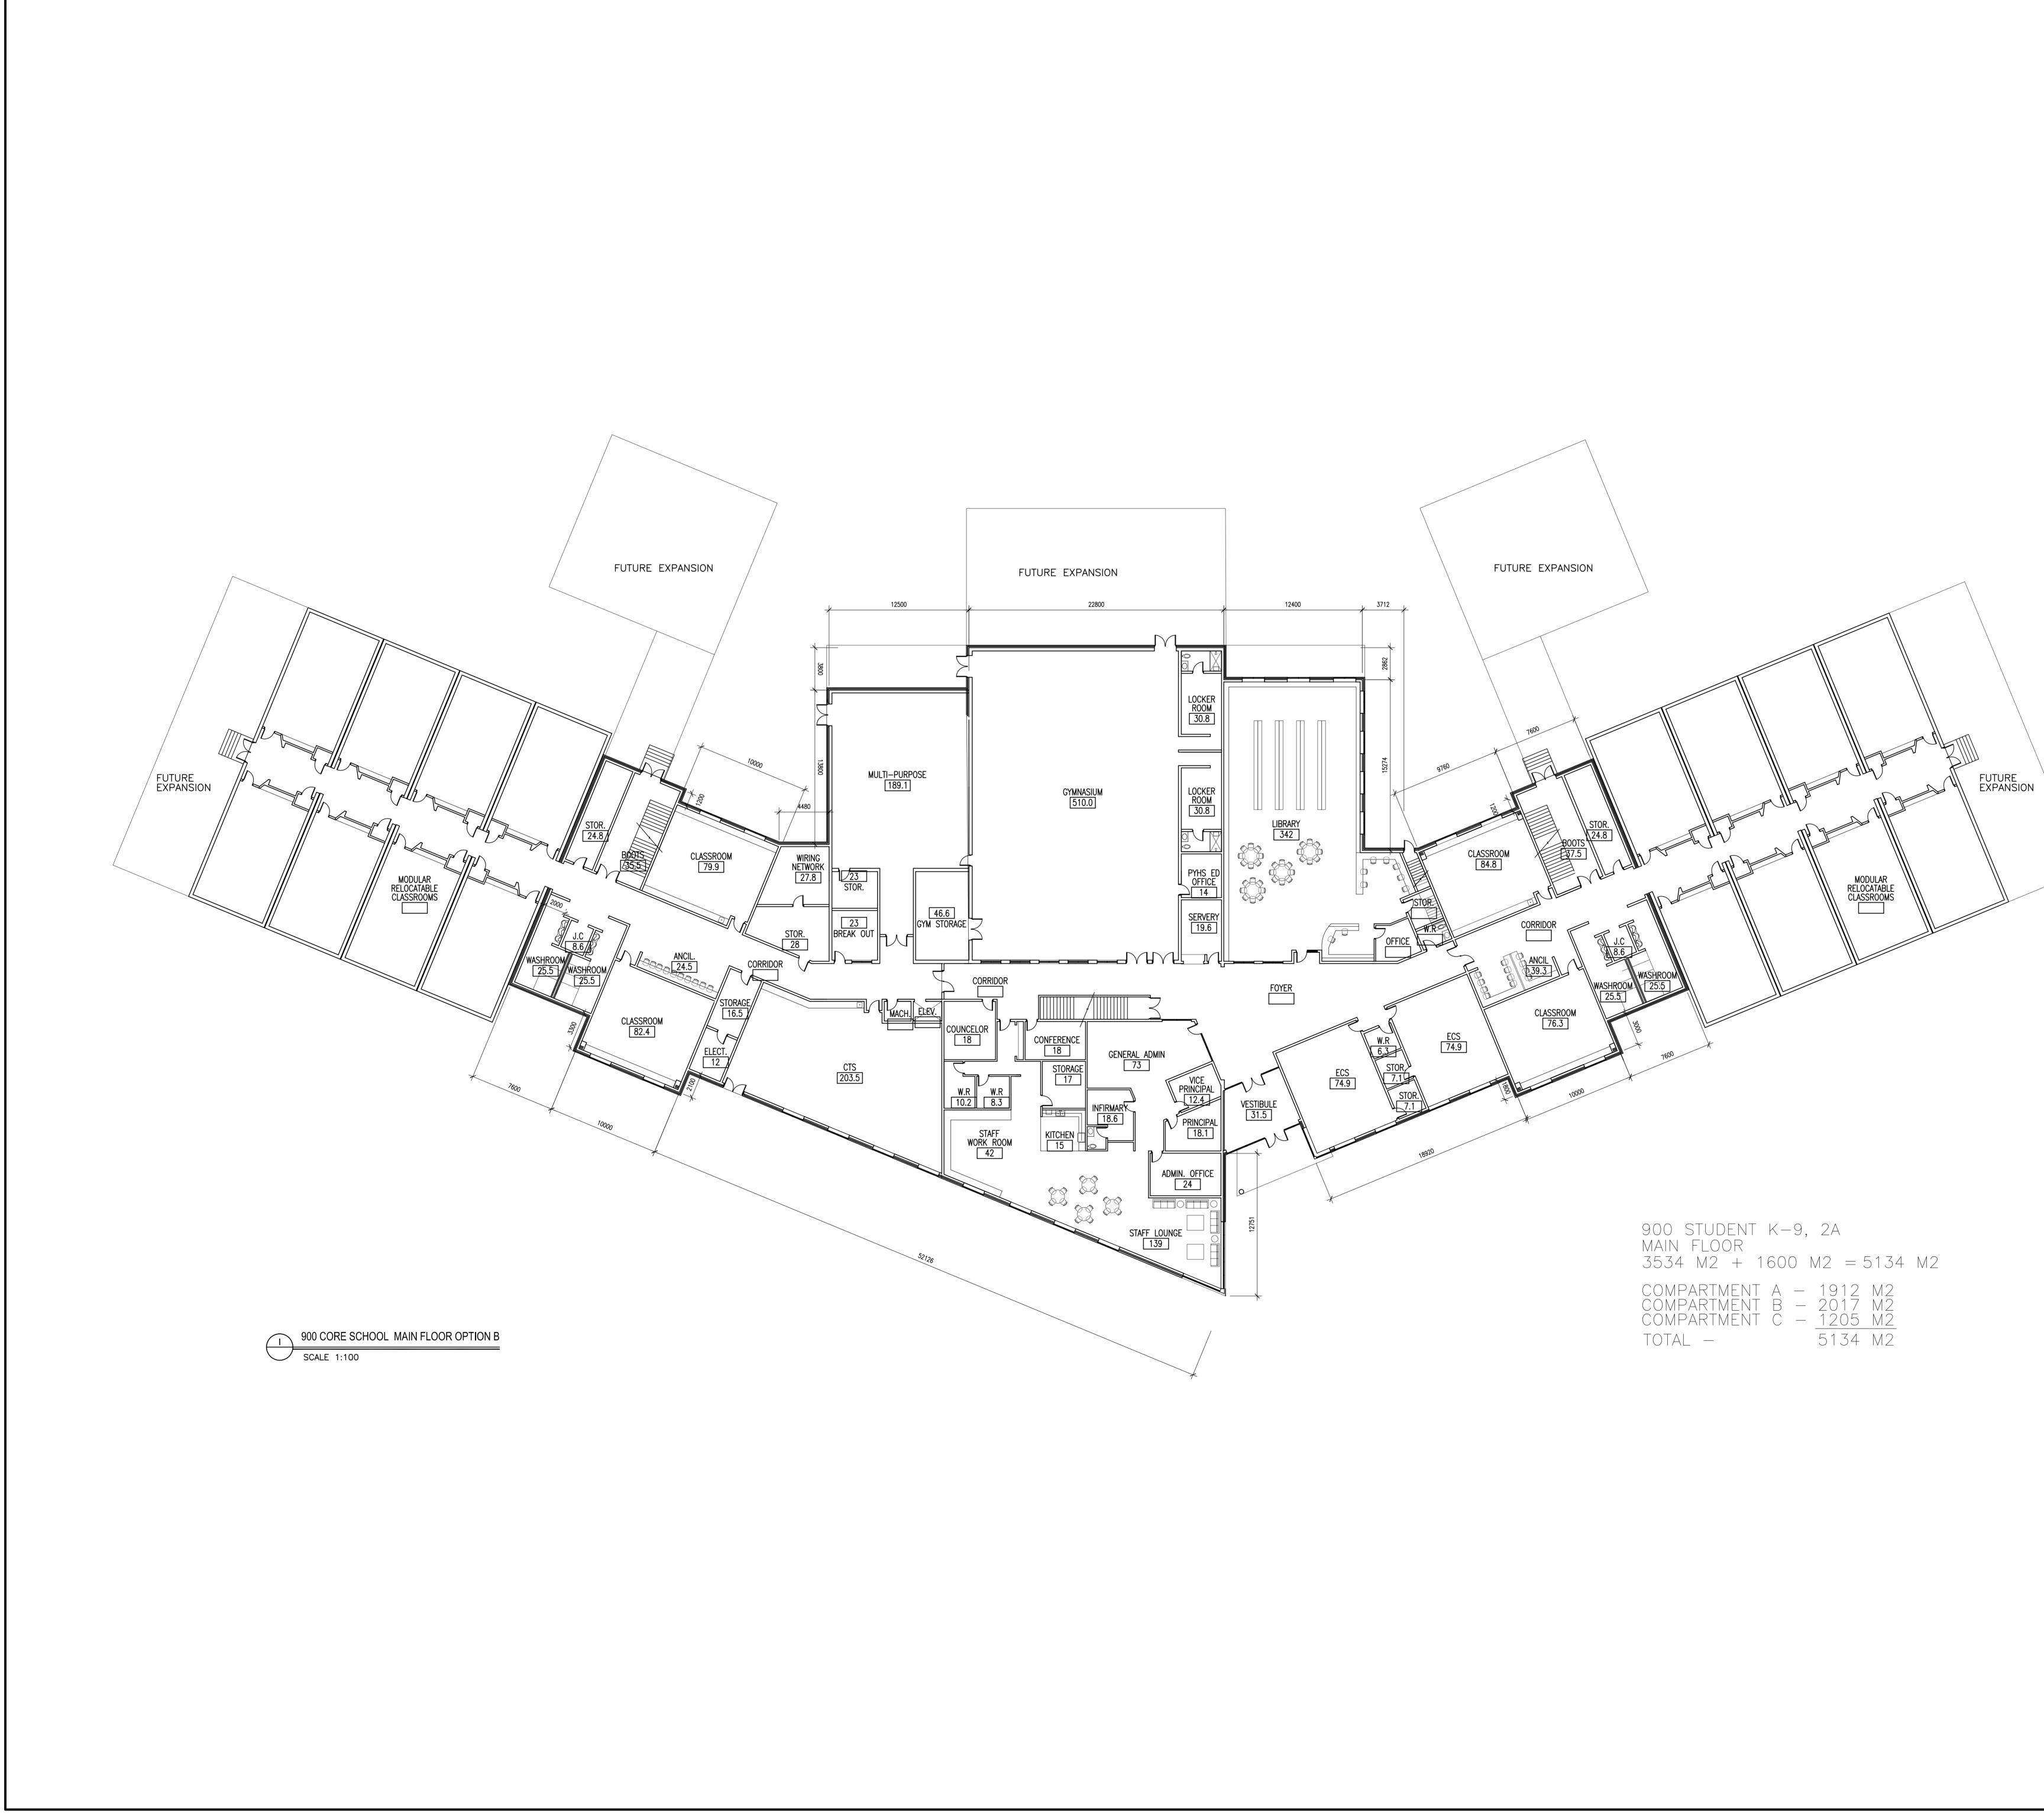
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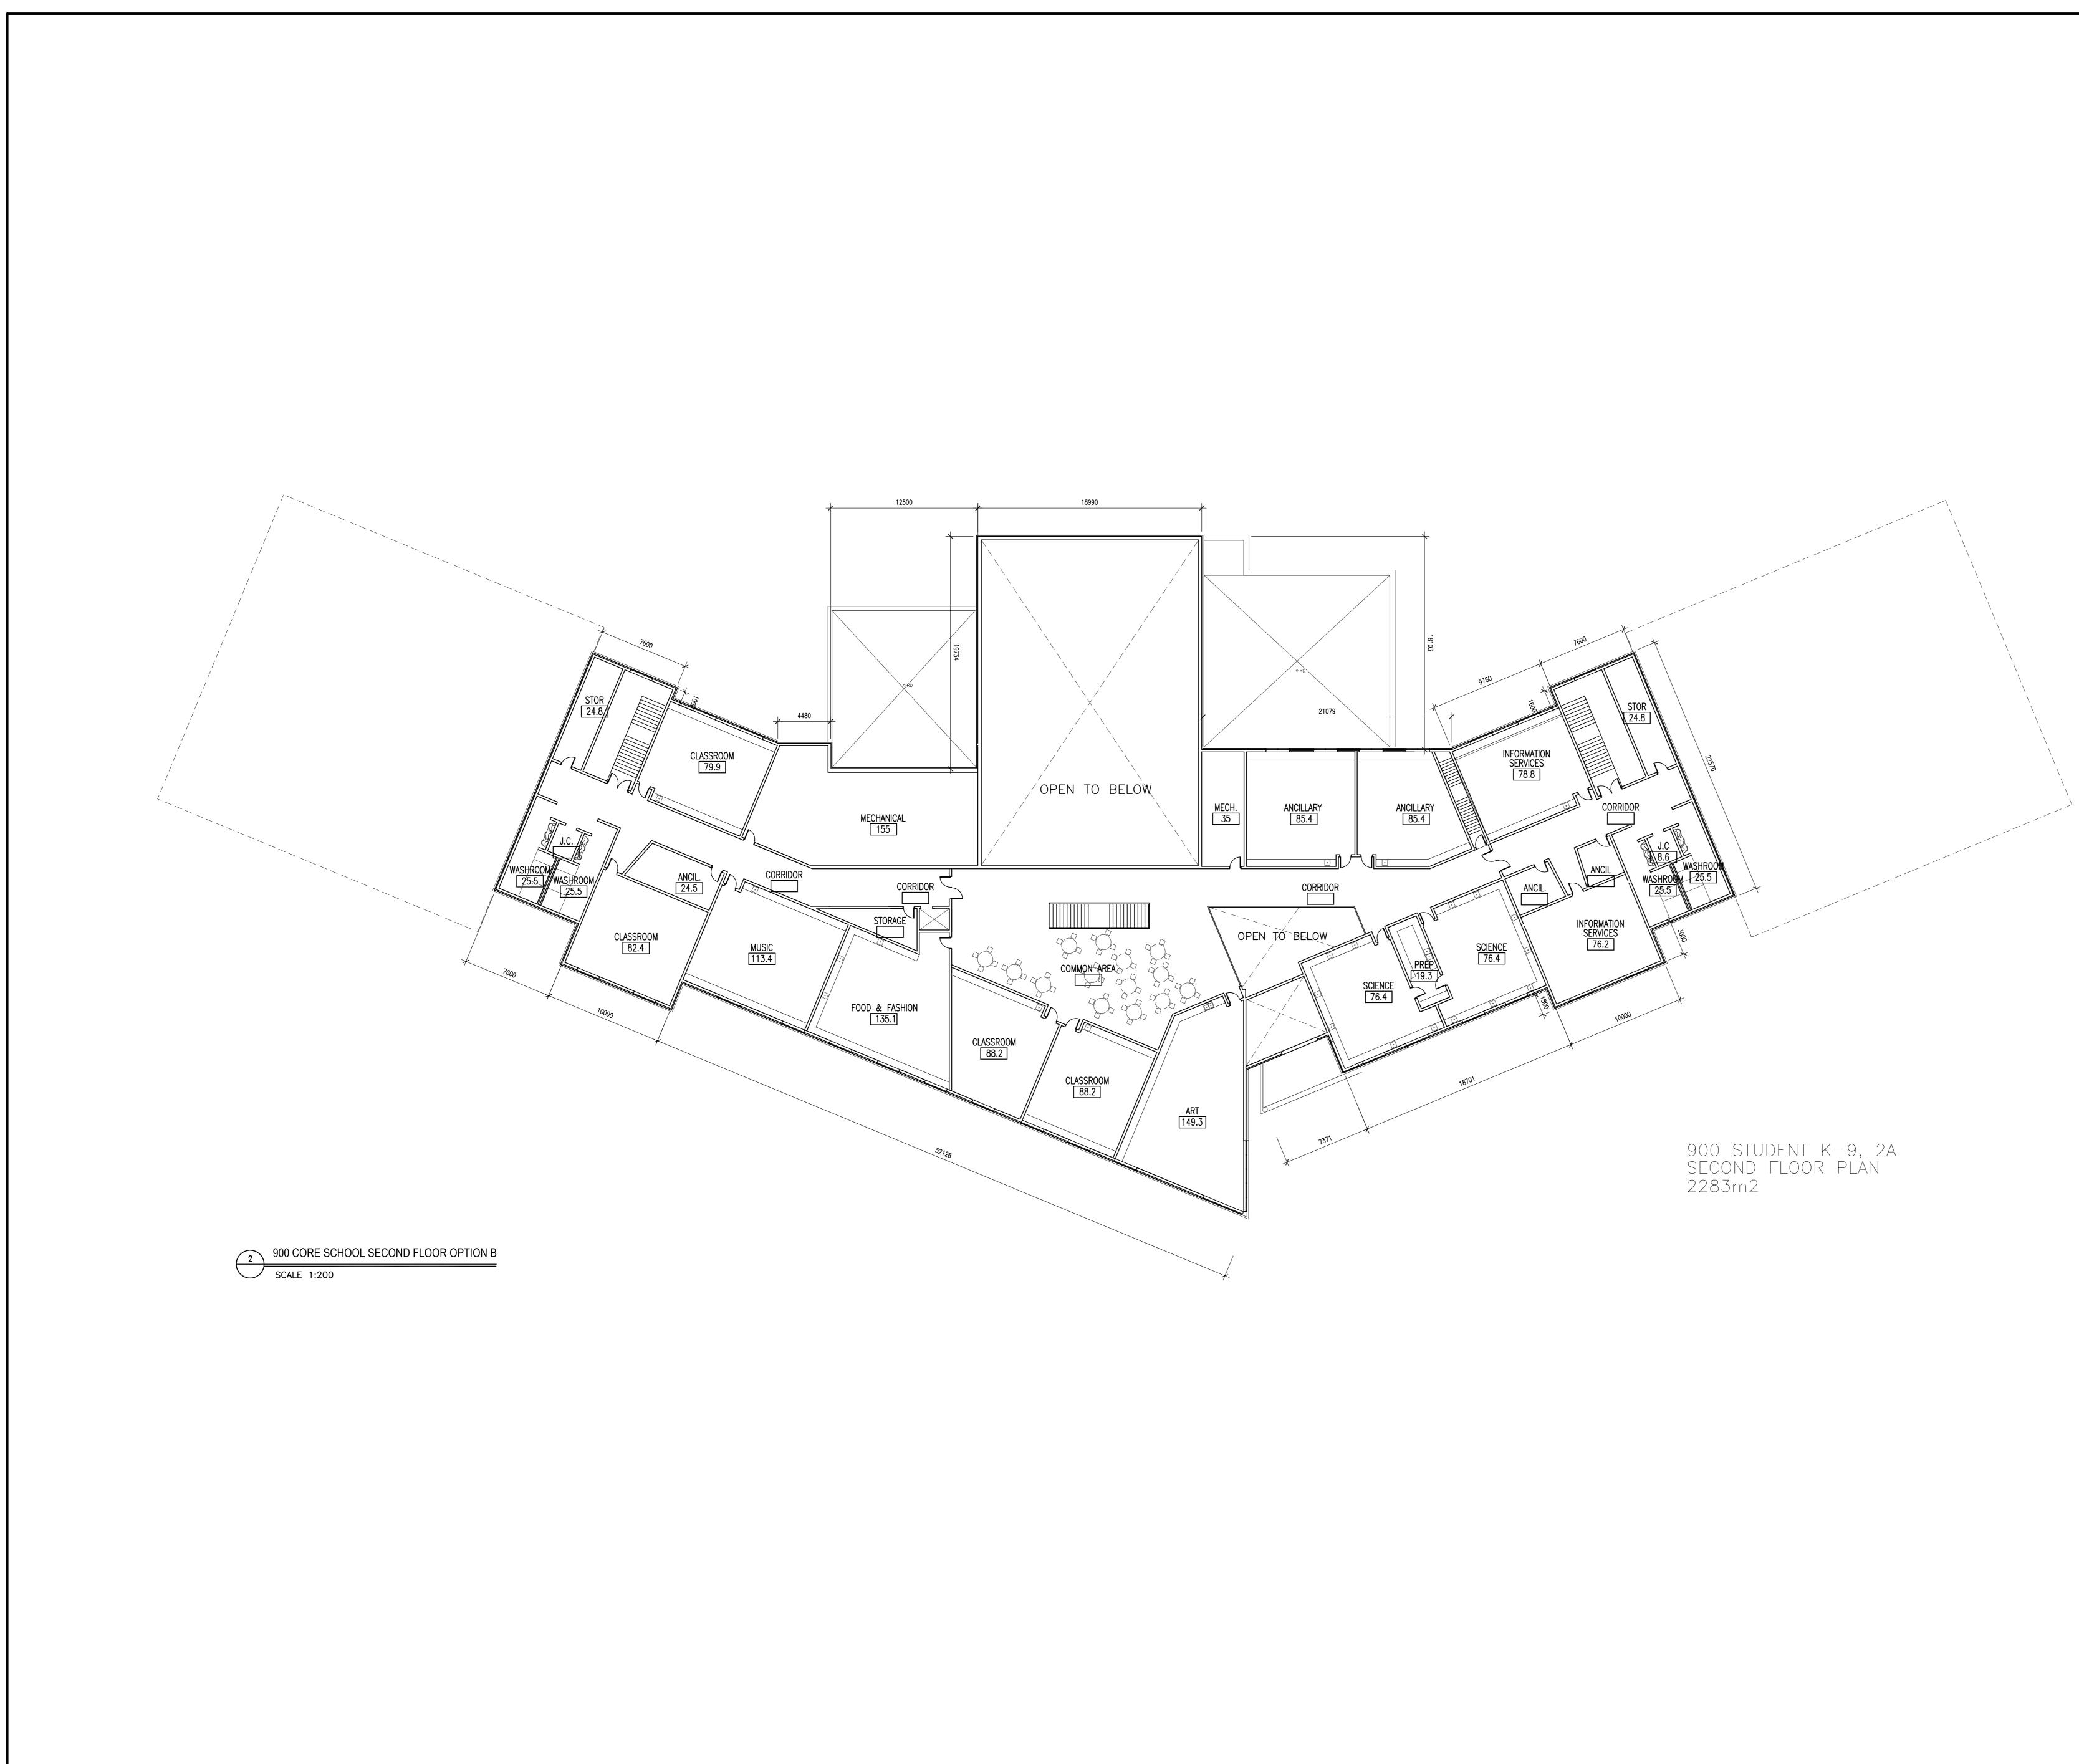



2 900 CORE SCHOOL SECOND FLOOR OPTION A SCALE 1:200

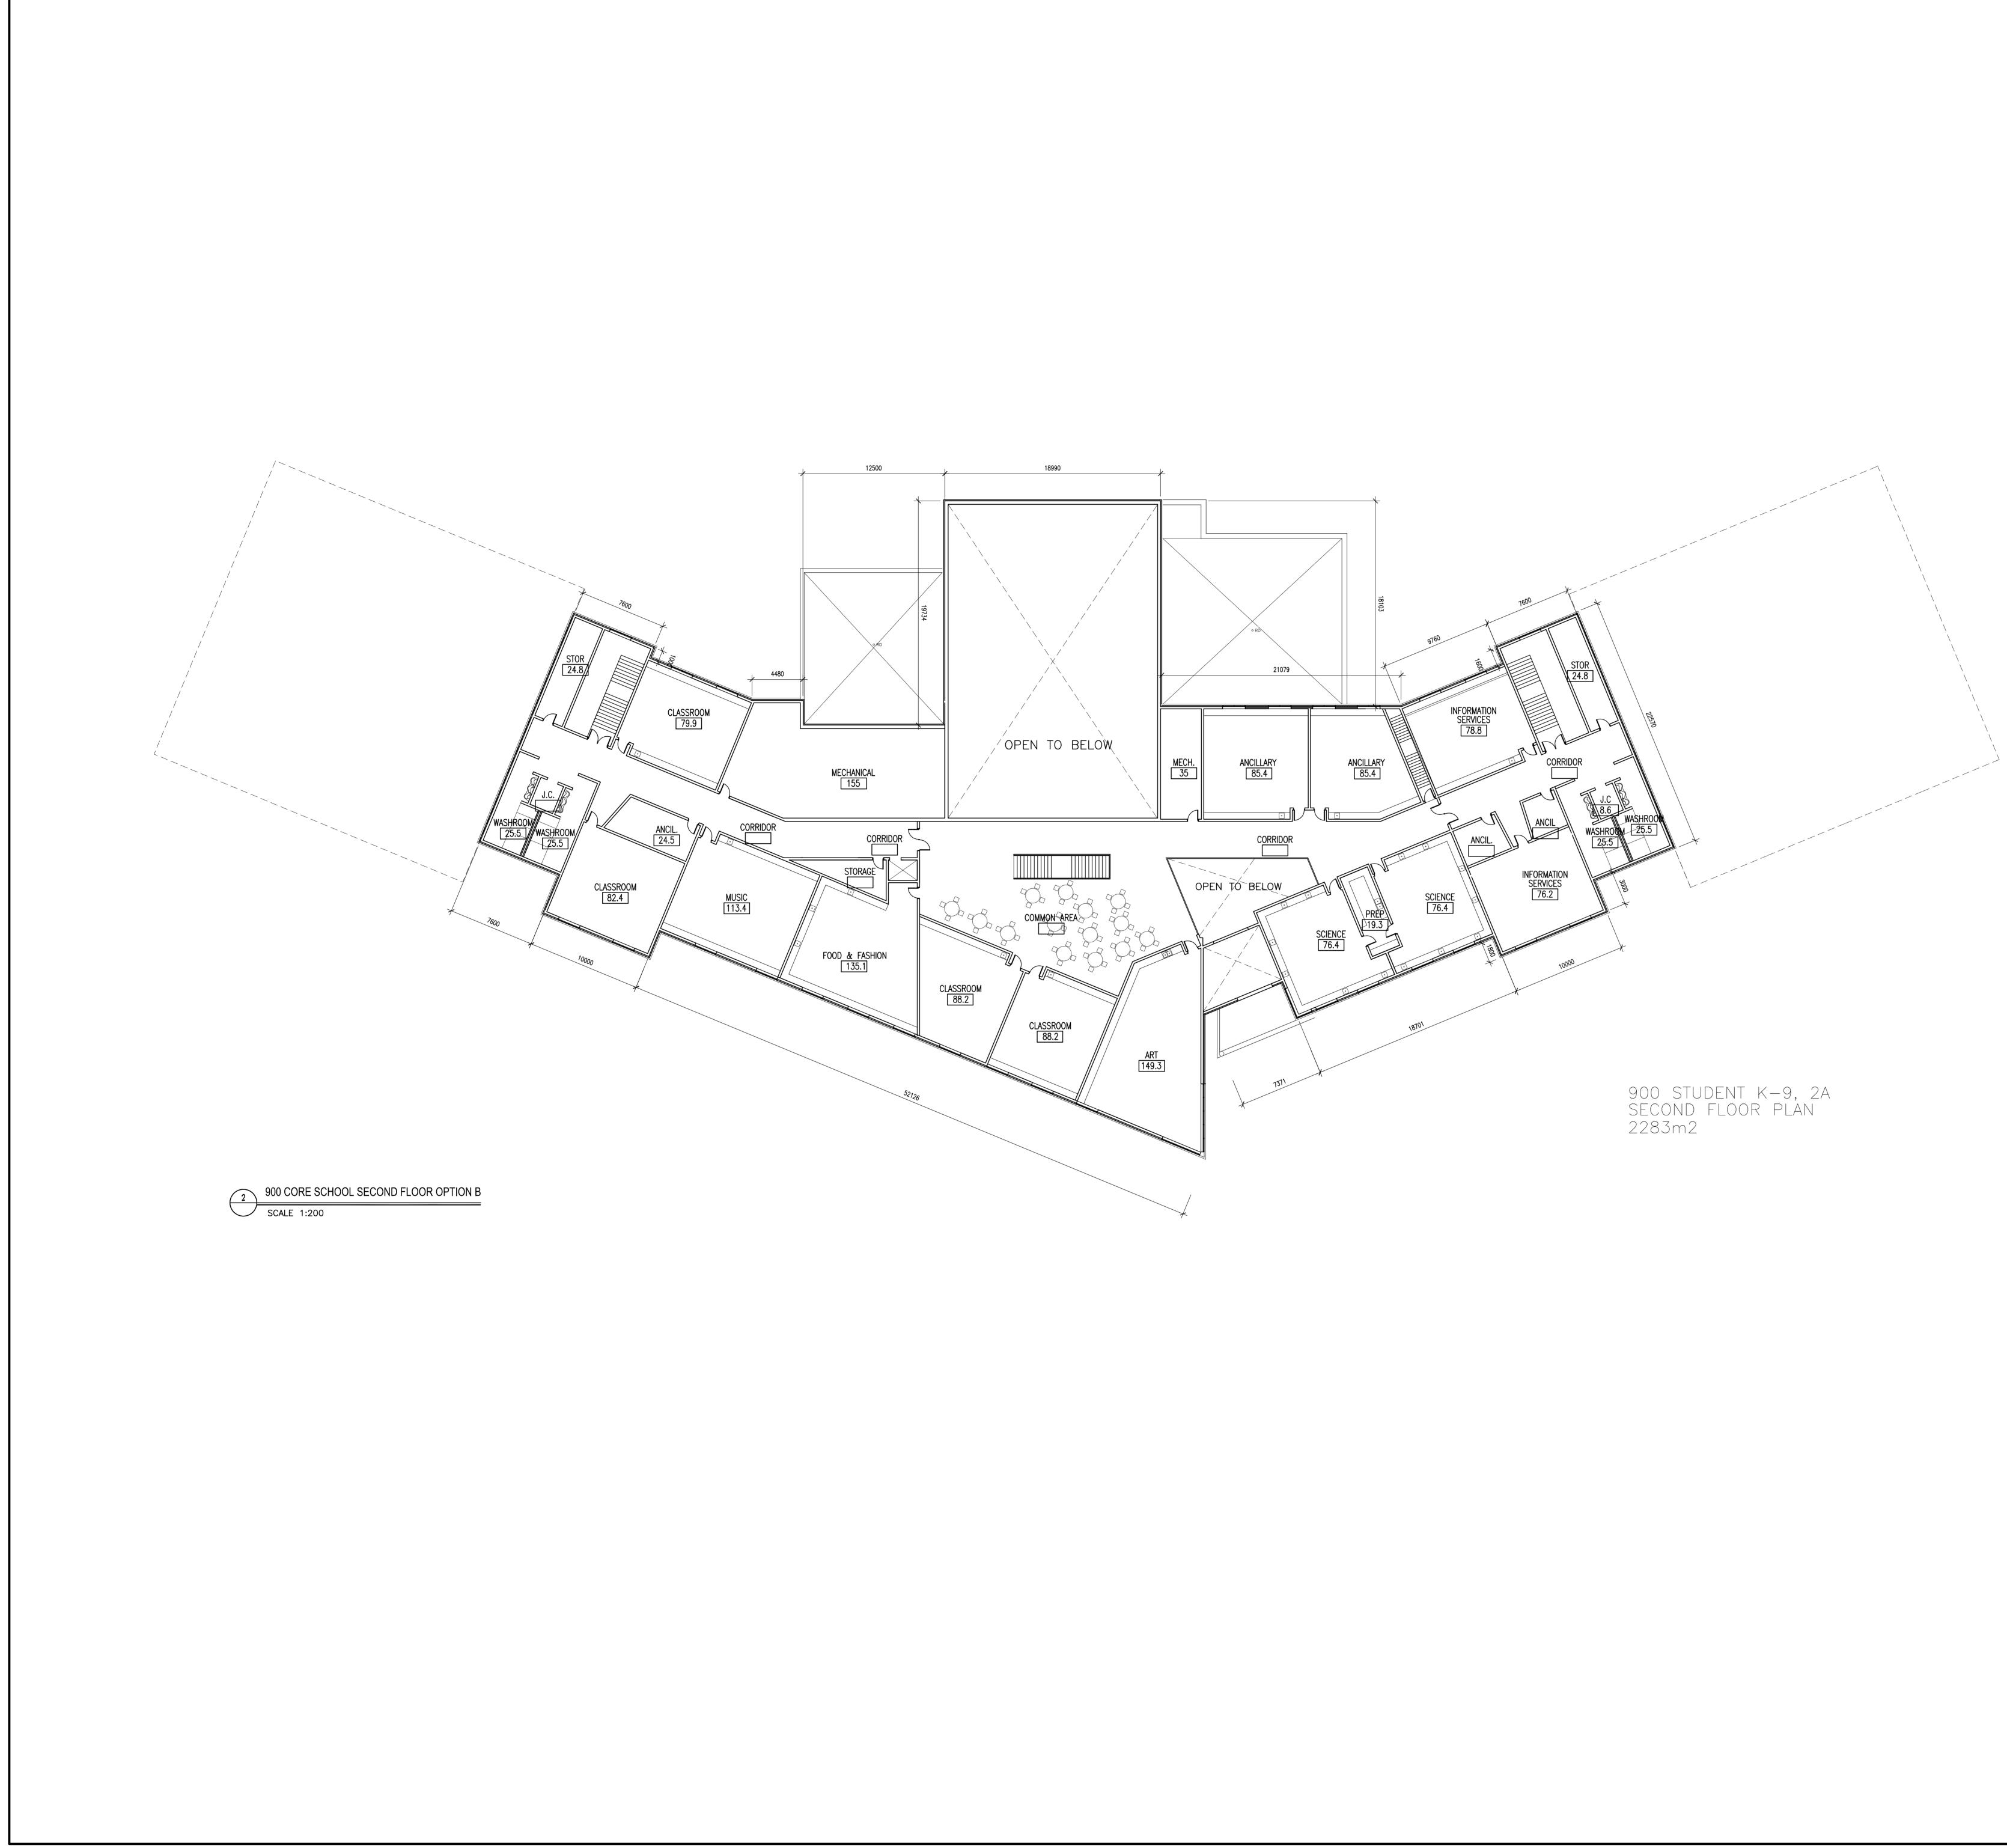
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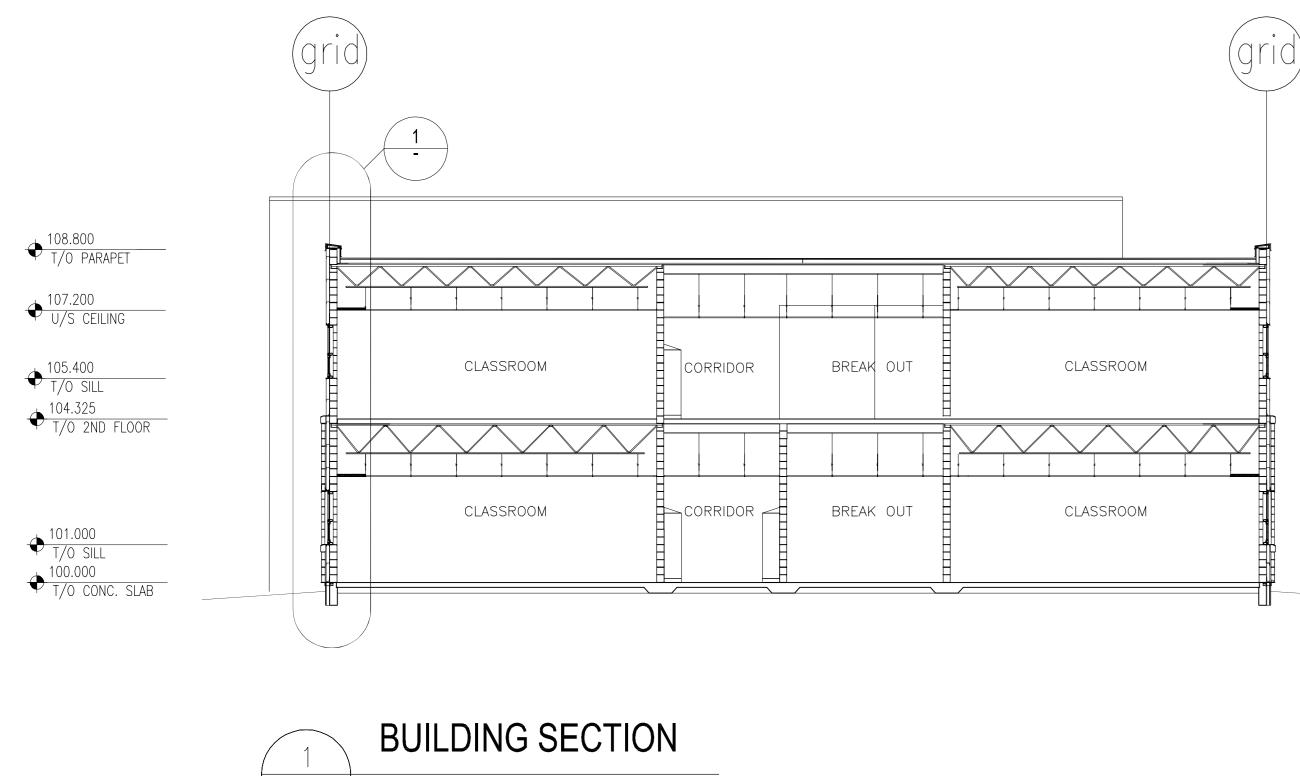





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| PROJECT 900 CORE SCHOOL ADDRESS SHEET TITLE BUILDING ELEVATIONS |
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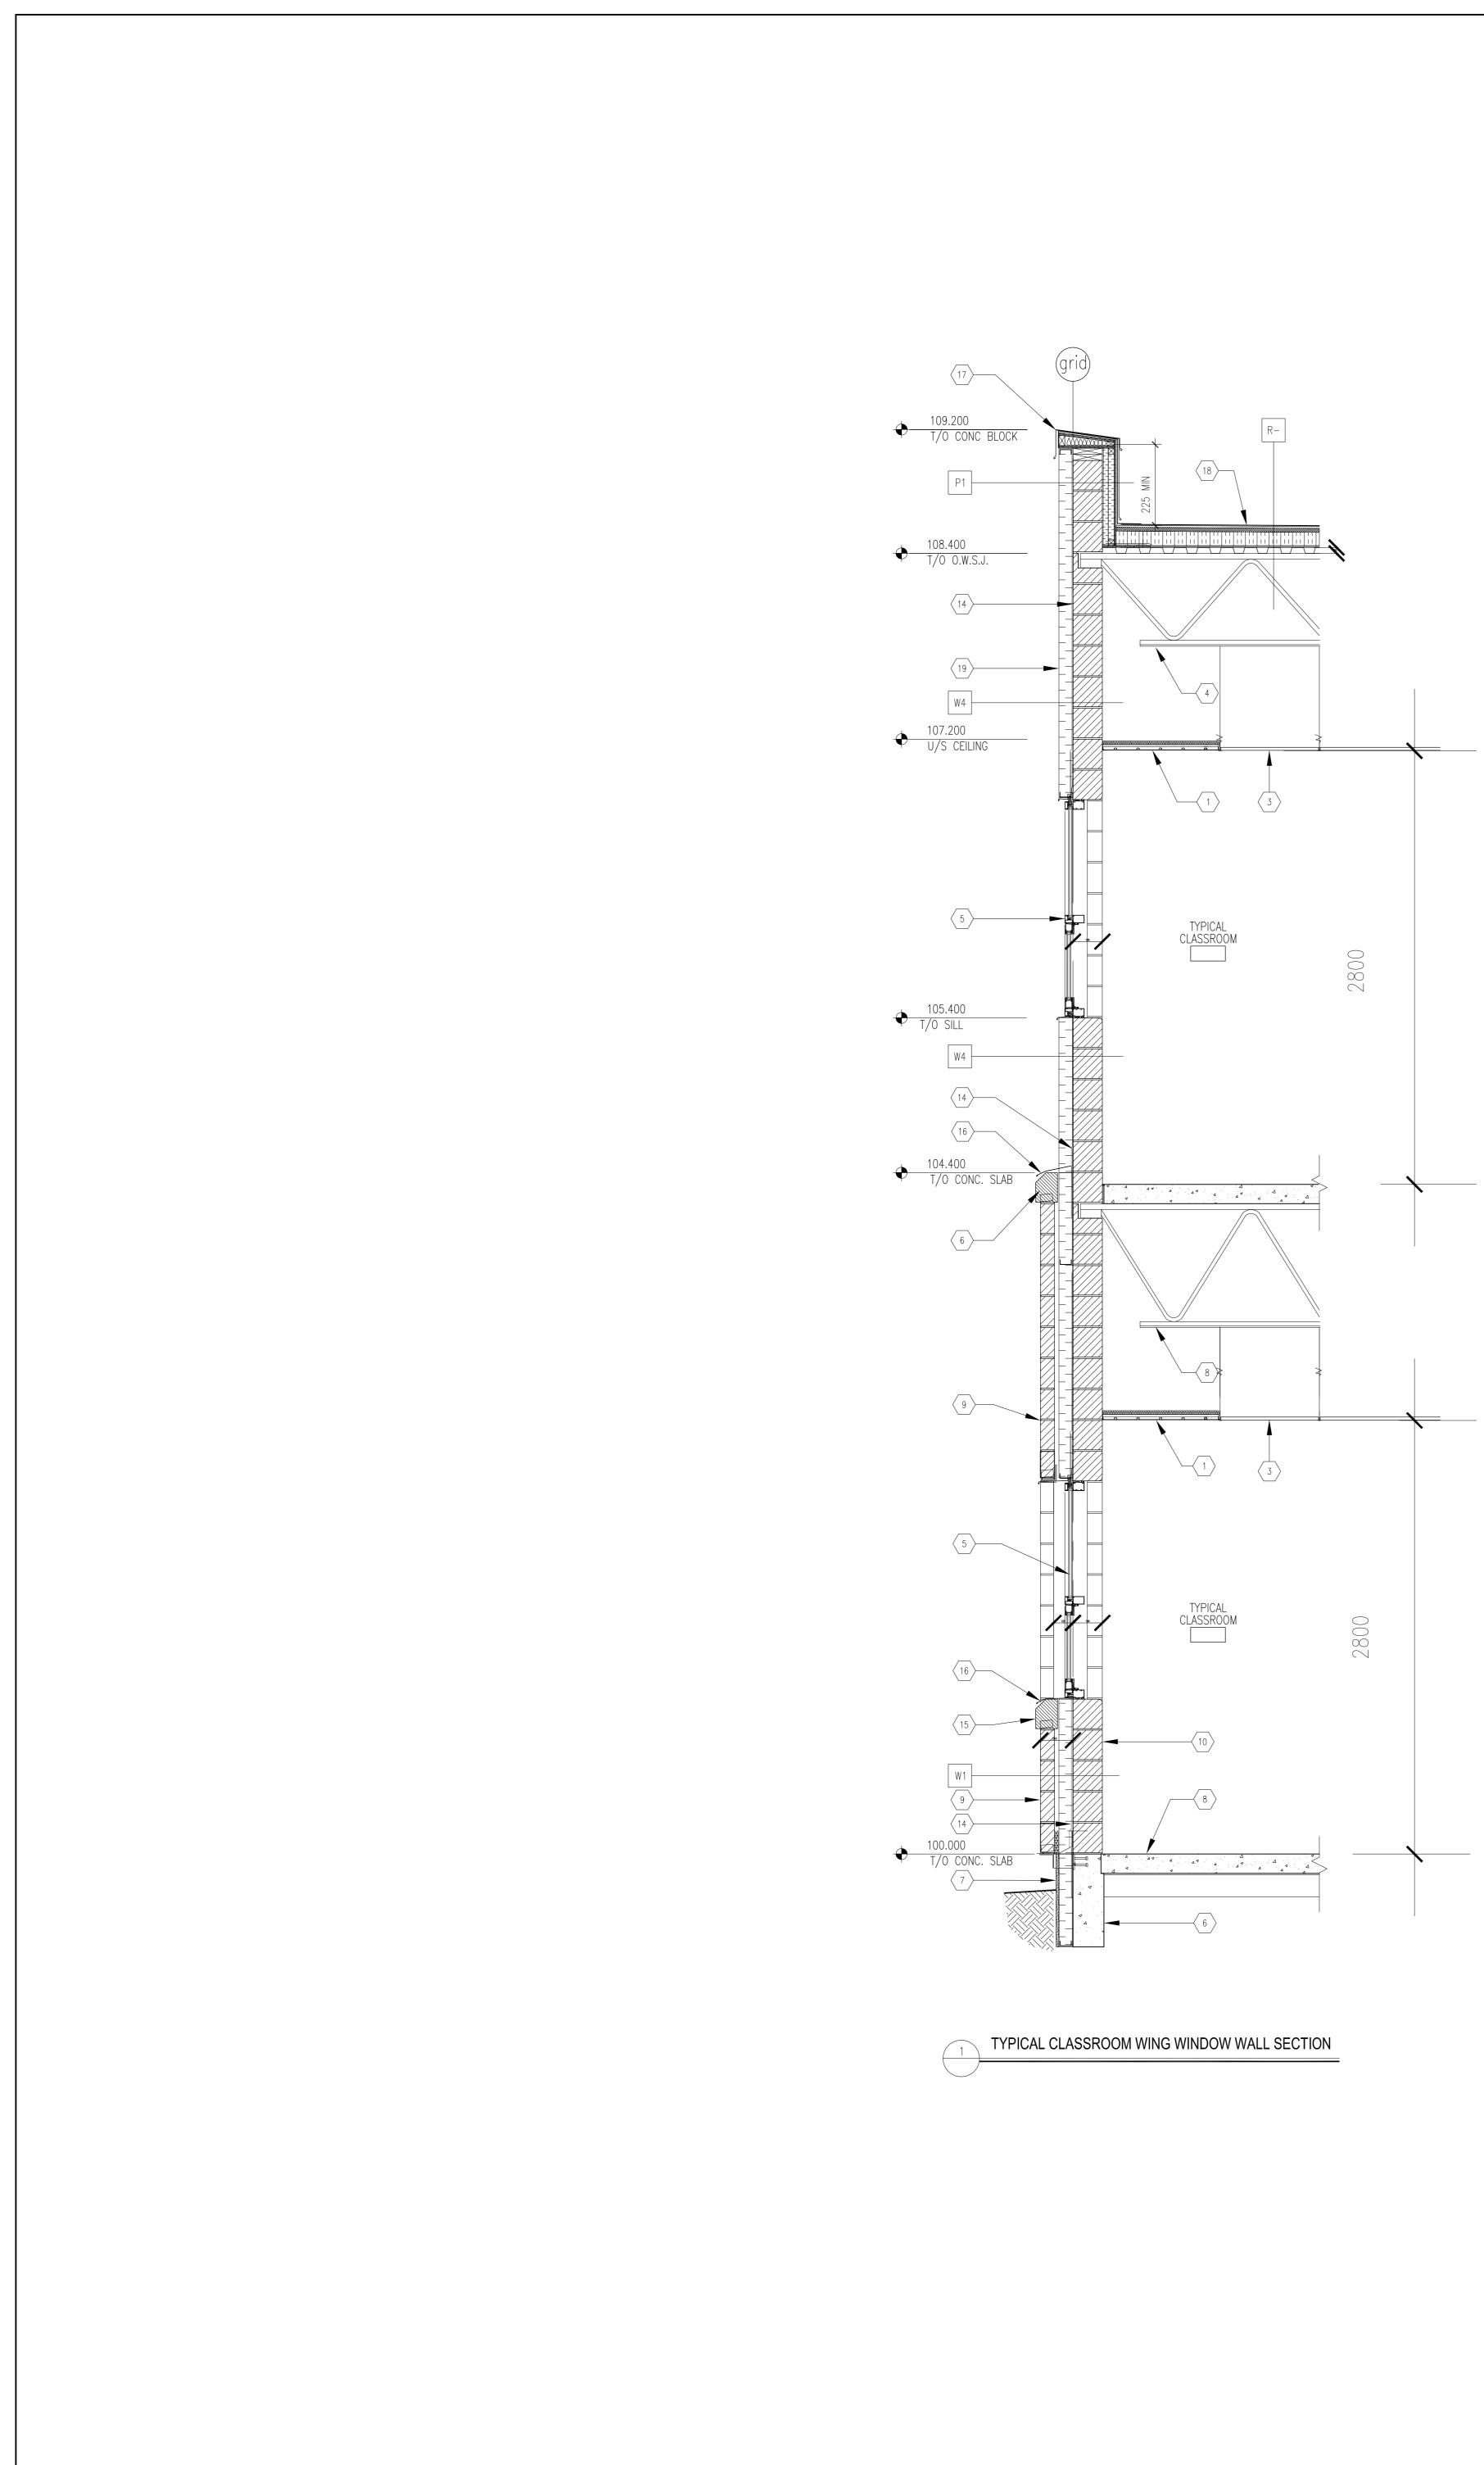


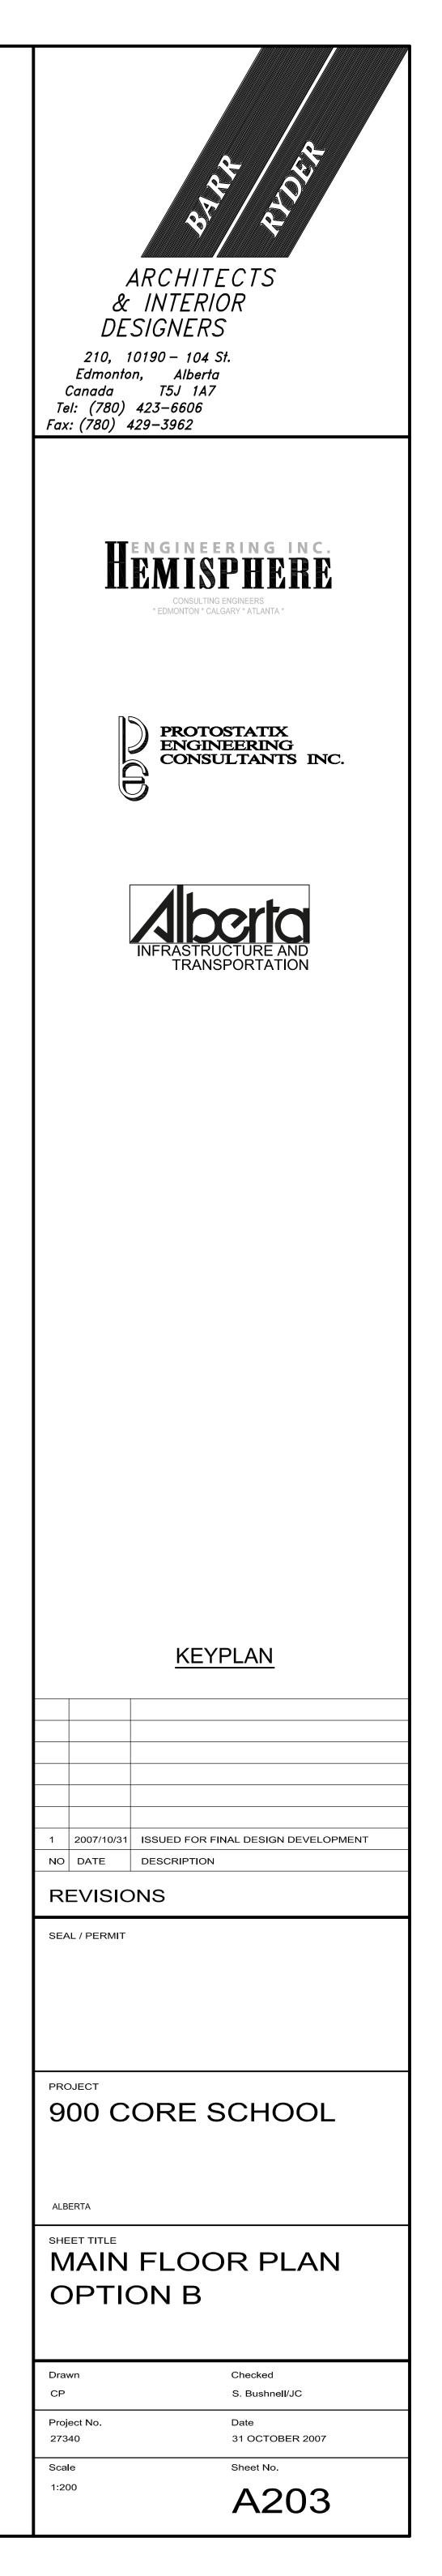- DOUBLE GLAZED THERMALLY BROKEN CLEAR ANOD. ALUM. CURTAINWALL FRAME WINDOW W/OPERABLE AWNING UNIT
- 16mm CEMENT BOARD ON 50mm Z-BARS, 50mm RIGID INSULATION,
- 50mm STIFFENED METAL PANEL ON 19mm GALV. STL BATTENS

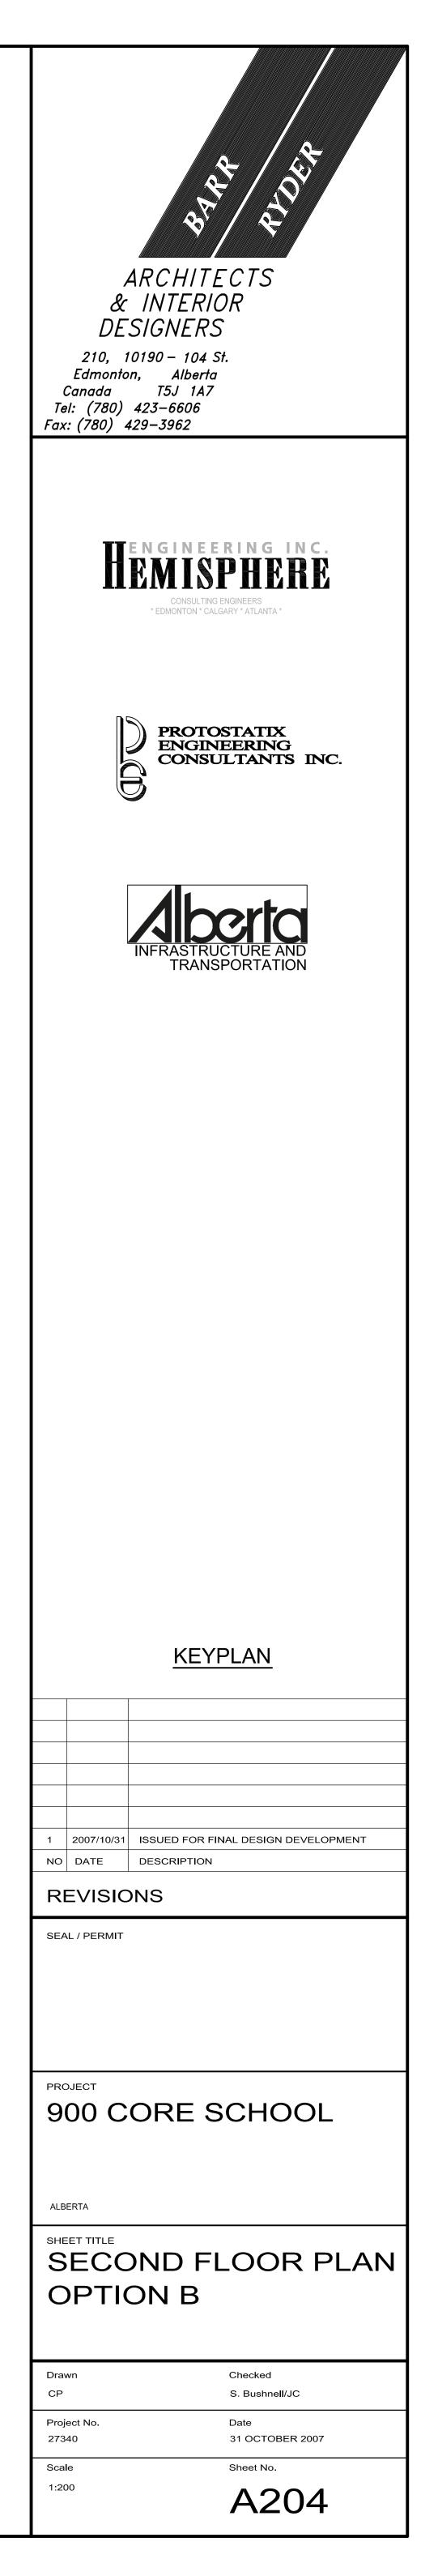PARAPET TYPES:

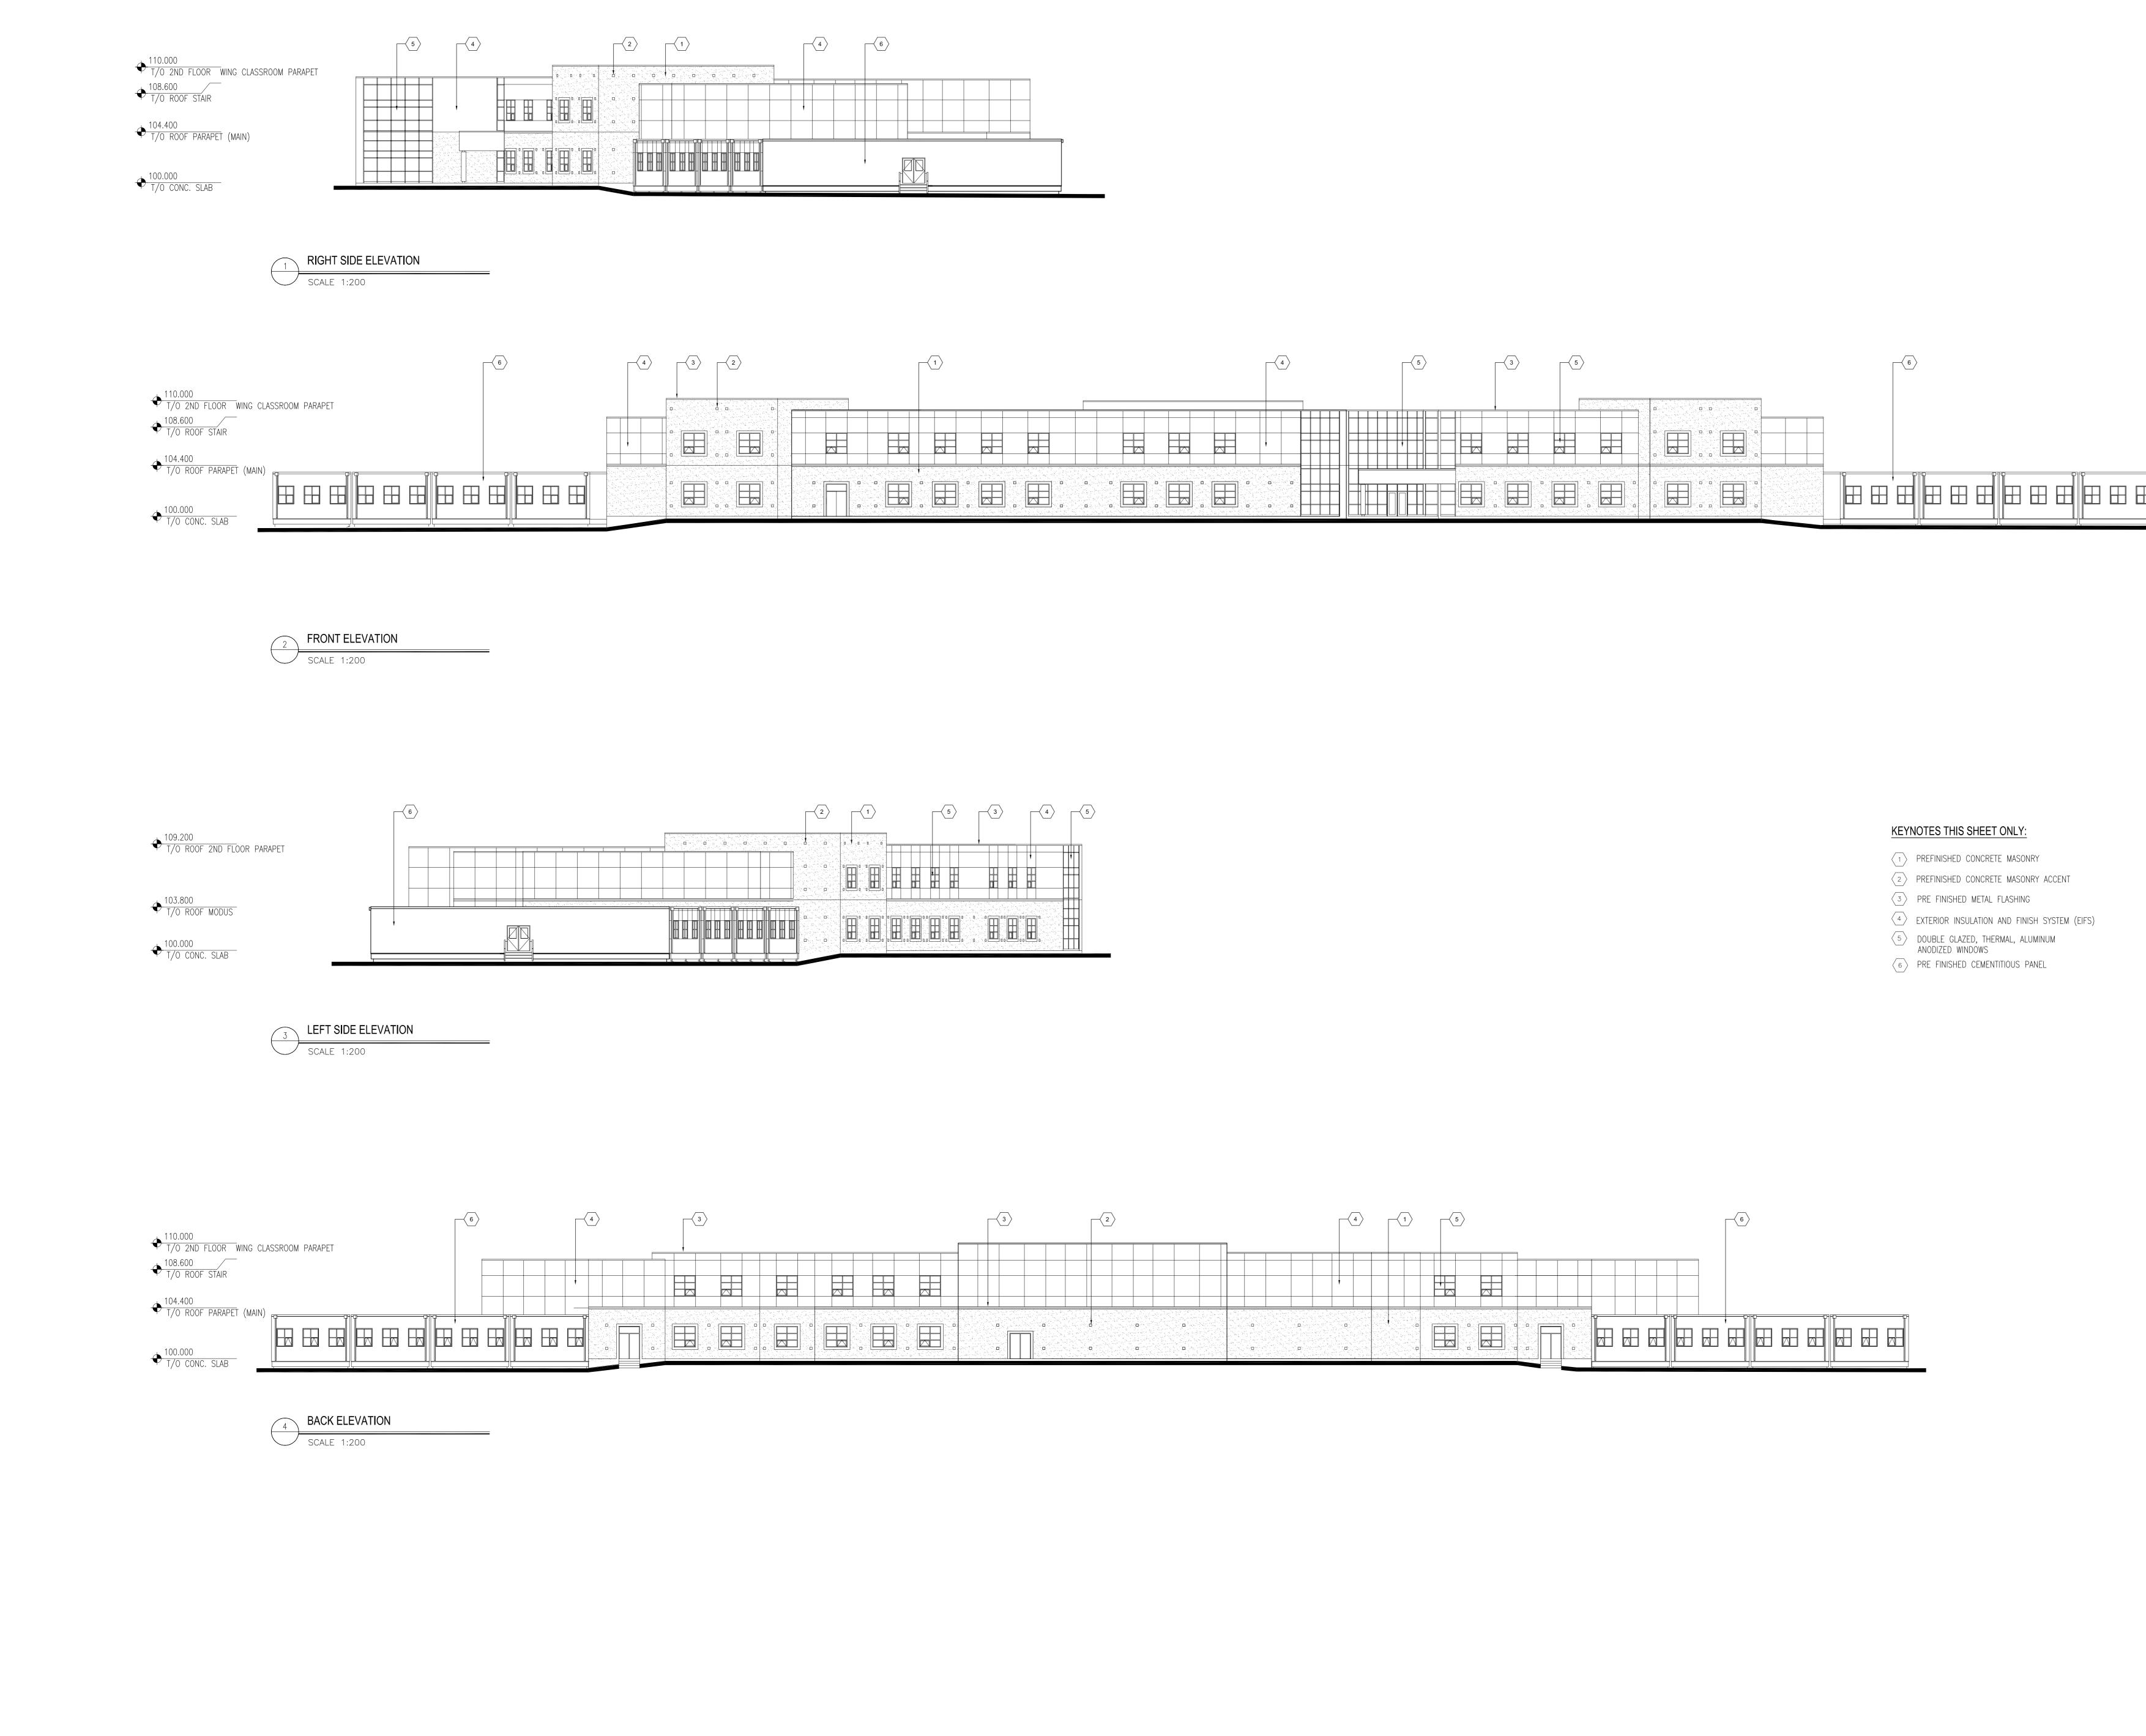AIR/ VAPOUR BARRIER FILL VOID WITH INSULATION.



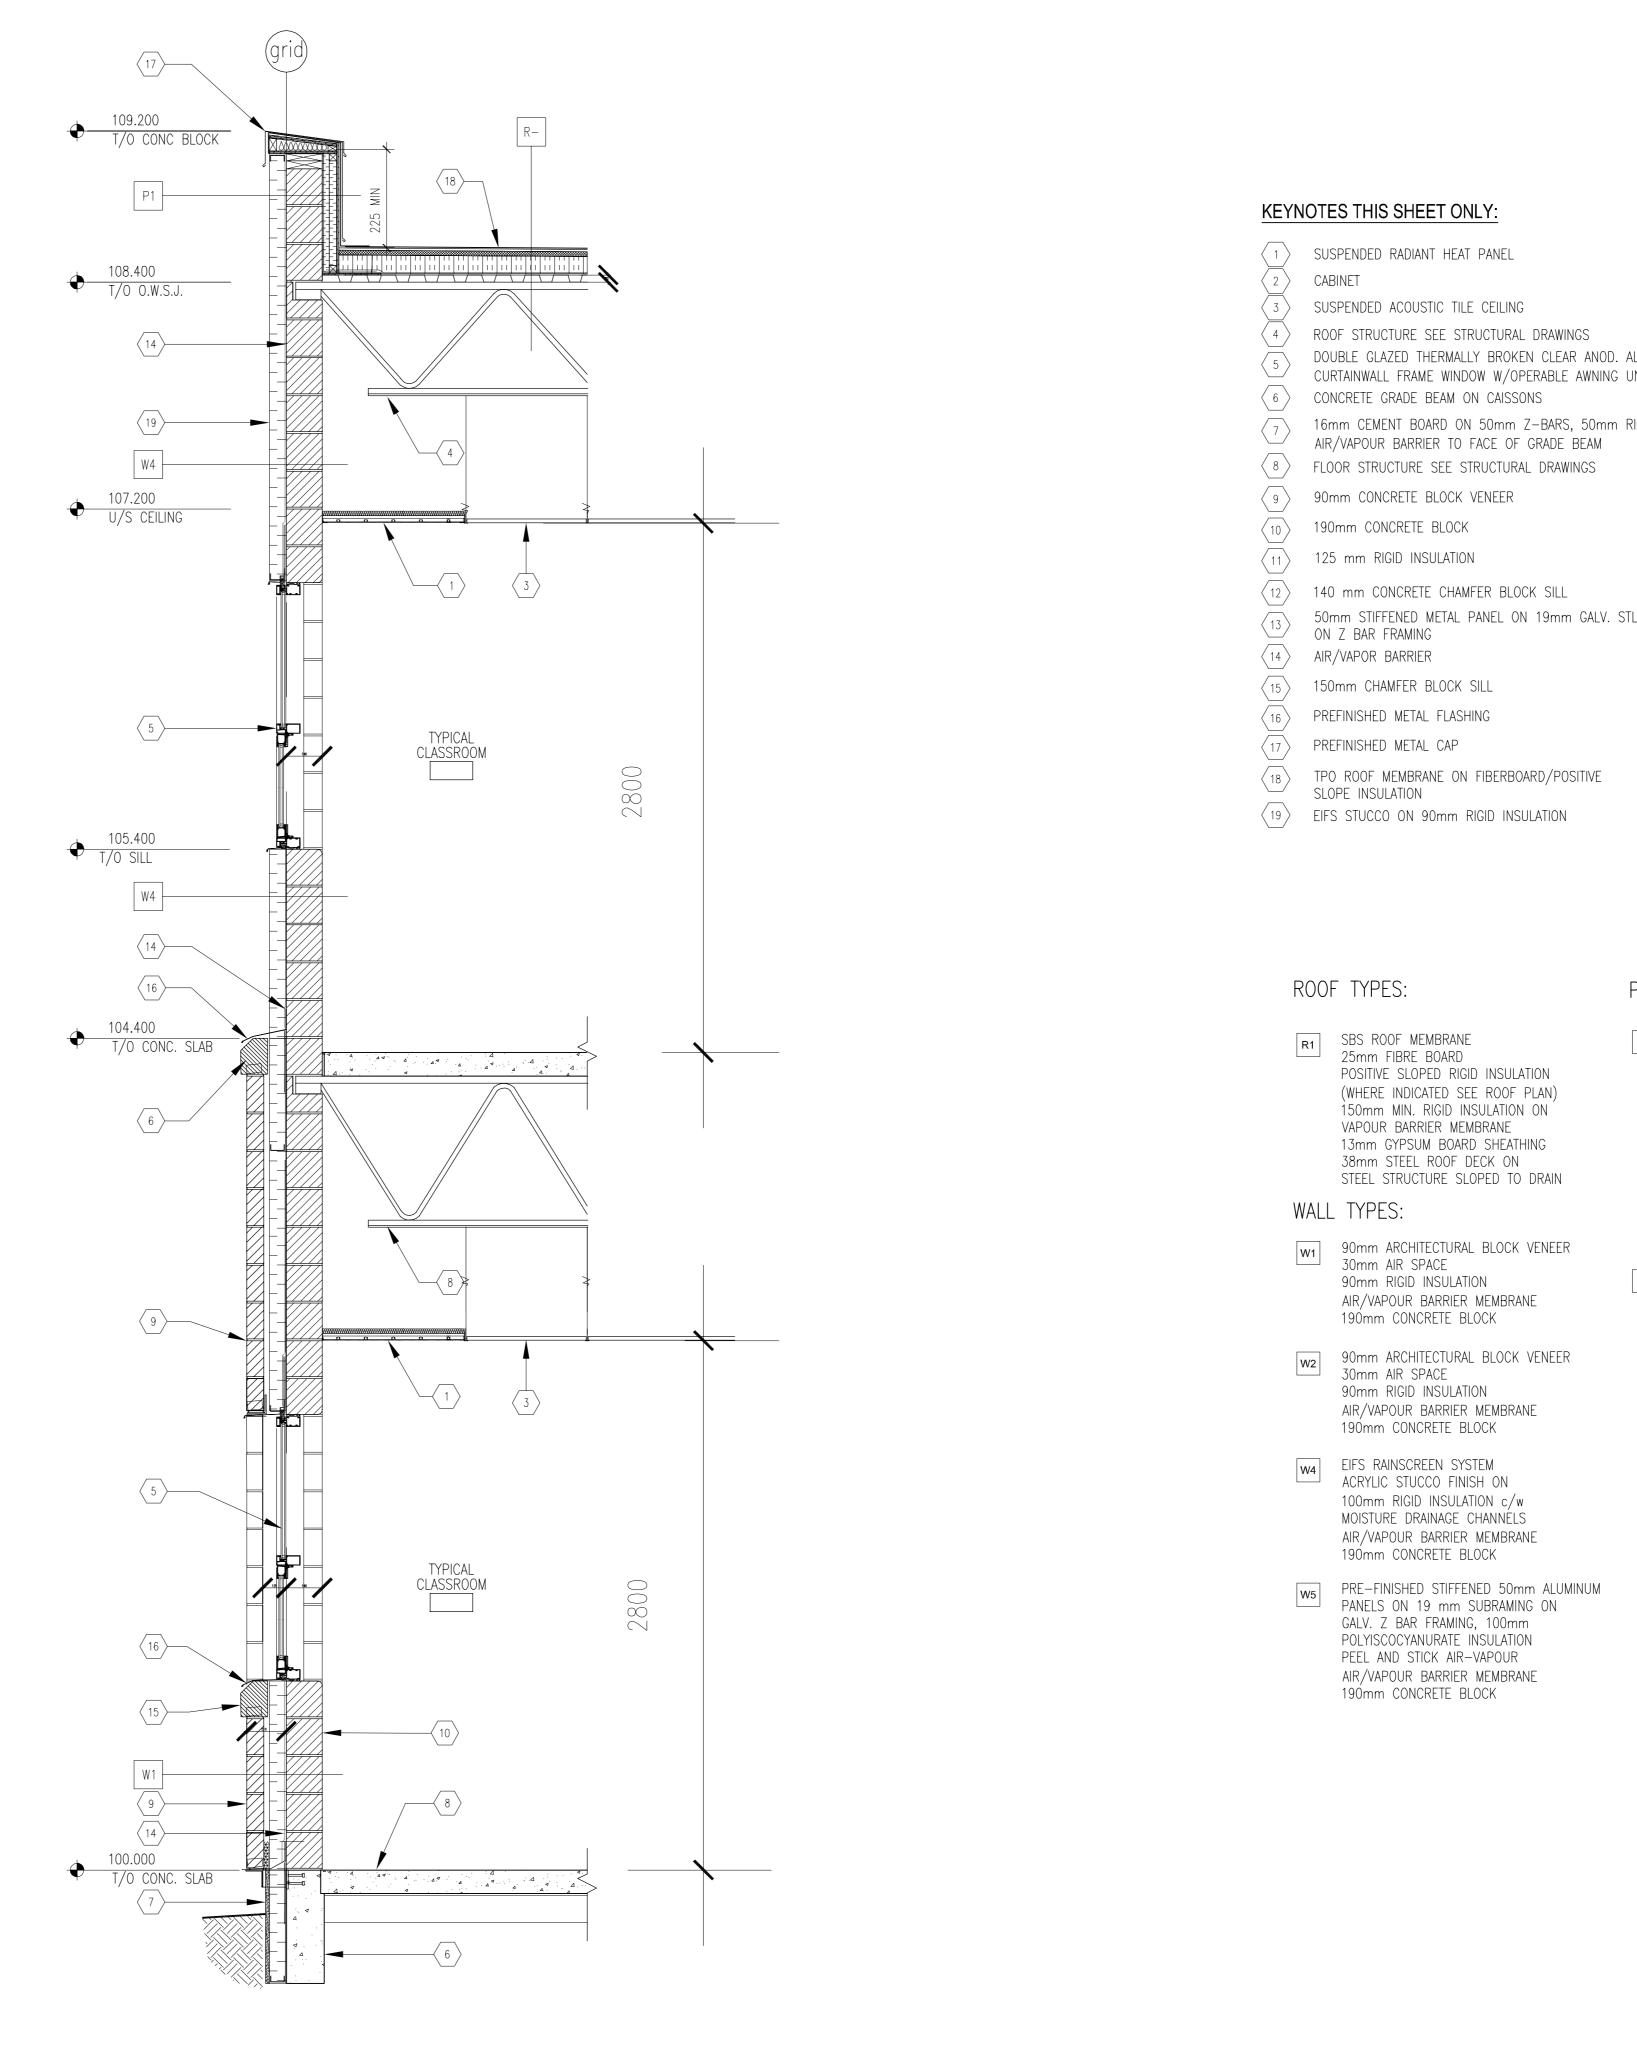

 $\langle 19 \rangle$ EIFS STUCCO ON 90mm RIGID INSULATION

KEYNOTES THIS SHEET ONLY:

 \langle 1 \rangle SUSPENDED RADIANT HEAT PANEL 2 CABINET SUSPENDED ACOUSTIC TILE CEILING ROOF STRUCTURE SEE STRUCTURAL DRAWINGS DOUBLE GLAZED THERMALLY BROKEN CLEAR ANOD. ALUM. CURTAINWALL FRAME WINDOW W/OPERABLE AWNING UNIT 6 CONCRETE GRADE BEAM ON CAISSONS 16mm CEMENT BOARD ON 50mm Z-BARS, 50mm RIGID INSULATION, AIR/VAPOUR BARRIER TO FACE OF GRADE BEAM $\langle 8 \rangle$ FLOOR STRUCTURE SEE STRUCTURAL DRAWINGS 9 90mm CONCRETE BLOCK VENEER 0 190mm CONCRETE BLOCK > 125 mm RIGID INSULATION 12 140 mm CONCRETE CHAMFER BLOCK SILL 50mm STIFFENED METAL PANEL ON 19mm GALV. STL BATTENS ON Z BAR FRAMING (14) AIR/VAPOR BARRIER 15 150mm CHAMFER BLOCK SILL PREFINISHED METAL FLASHING 17 PREFINISHED METAL CAP TPO ROOF MEMBRANE ON FIBERBOARD/POSITIVE SLOPE INSULATION


ROOF TYPES:

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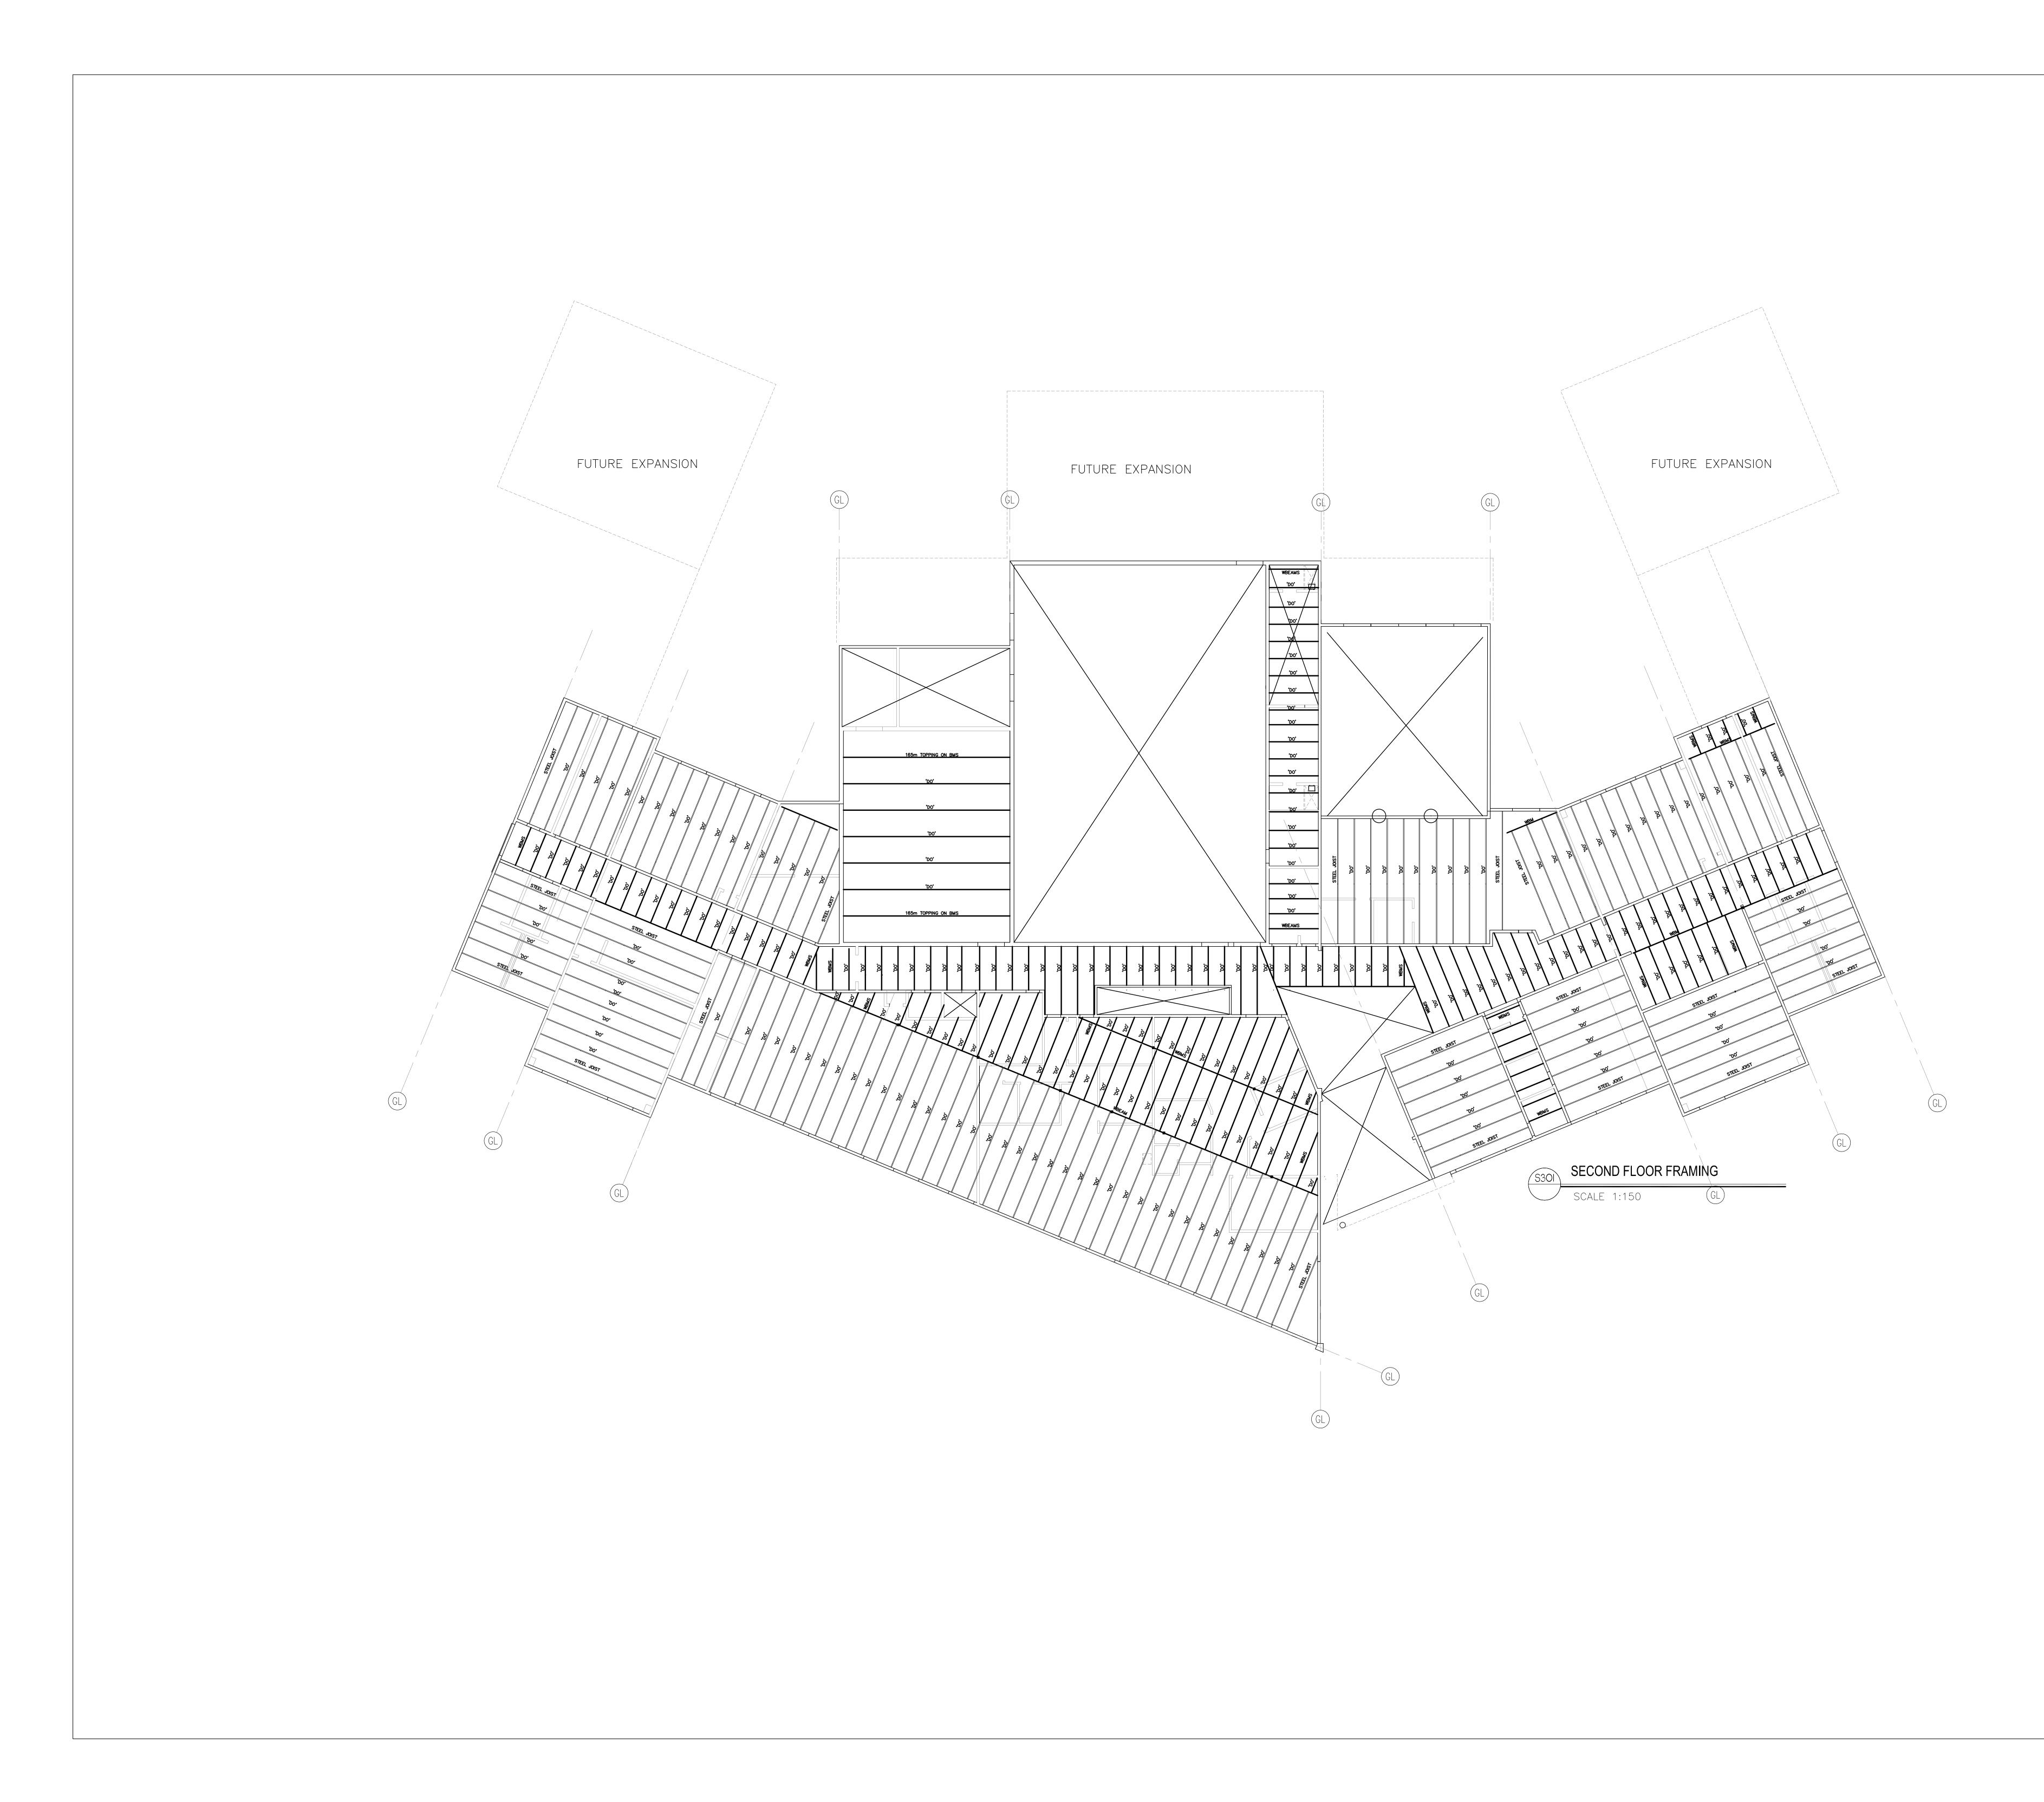
- R1 SBS ROOF MEMBRANE 25mm FIBRE BOARD POSITIVE SLOPED RIGID INSULATION (WHERE INDICATED SEE ROOF PLAN) 150mm MIN. RIGID INSULATION ON VAPOUR BARRIER MEMBRANE 13mm GYPSUM BOARD SHEATHING 38mm STEEL ROOF DECK ON STEEL STRUCTURE SLOPED TO DRAIN
- WALL TYPES:
- W1 90mm ARCHITECTURAL BLOCK VENEER 30mm AIR SPACE 90mm RIGID INSULATION AIR/VAPOUR BARRIER MEMBRANE 190mm CONCRETE BLOCK
- w2 90mm ARCHITECTURAL BLOCK VENEER 30mm AIR SPACE 90mm RIGID INSULATION AIR/VAPOUR BARRIER MEMBRANE 190mm CONCRETE BLOCK
- W4 EIFS RAINSCREEN SYSTEM ACRYLIC STUCCO FINISH ON 100mm RIGID INSULATION c/w MOISTURE DRAINAGE CHANNELS AIR/VAPOUR BARRIER MEMBRANE 190mm CONCRETE BLOCK
- W5 PRE-FINISHED STIFFENED 50mm ALUMINUM PANELS ON 19 mm SUBRAMING ON GALV. Z BAR FRAMING, 100mm POLYISCOCYANURATE INSULATION PEEL AND STICK AIR-VAPOUR AIR/VAPOUR BARRIER MEMBRANE 190mm CONCRETE BLOCK


- PT PREFINISHED METAL COPING FLASHING INCLUDING COUNTERFLASHING. CARRY SBS ROOF MEMBRANE FROM ROOF TO TOP OF WOOD COPING. 190 CONCRETE BLOCK AIR/ VAPOUR BARRIER 50mm STIFFENED METAL PANEL ON 19 mm GALV. STEEL BATTENS AND Z GIRT FRAMING 100mm RIGID INSULATION c/w MOISTURE DRAINAGE CHANNELS AIR/VAPOUR BARRIER MEMBRANE 190 CONCRETE BLOCK
- P2 PREFINISHED METAL COPING FLASHING INCLUDING COUNTERFLASHING. CARRY SBS ROOF MEMBRANE FROM ROOF TO TOP OF WOOD COPING. WOOD COPING TO CONSIST OF 13mm EXT. GRADE PLYWOOD ON PRESSURE TREATED WOOD BLOCKING ON 16mm EXTERIOR GRADE PLYWOOD FILL VOID WITH INSULATION. EASTENED TO EXTERIOR 13mm GYPSUM SHEA FASTENED TO EXTERIOR 13mm GYPSUM SHEATHING TO TOP TRACK OF METAL STUD. 38mm X 89mm PRESSURE TREATED WOOD BLOCKING FASTENED TO SHEATHING 90mm ARCHITECTURAL BLOCK 30mm AIR SPACE AIR/VAPOUR BARRIER MEMBRANE 13mm EXT. GYPSUM BOARD SHEATHING 152mm STEEL STUDS @ 400mm O.C. R20 BATT INSULATION 16mm ABUSE RESISTANT GYPSUM BOARD 38mm X 38mm PRESSURE TREATED WOOD STUD @ 400.0.0 STUD @ 400 O.C.
 - FILL VOID W/ RIGID INSULATION ON 13mm EXTERIOR GRADE PLYWOOD TPO ROOF MEMBRANE


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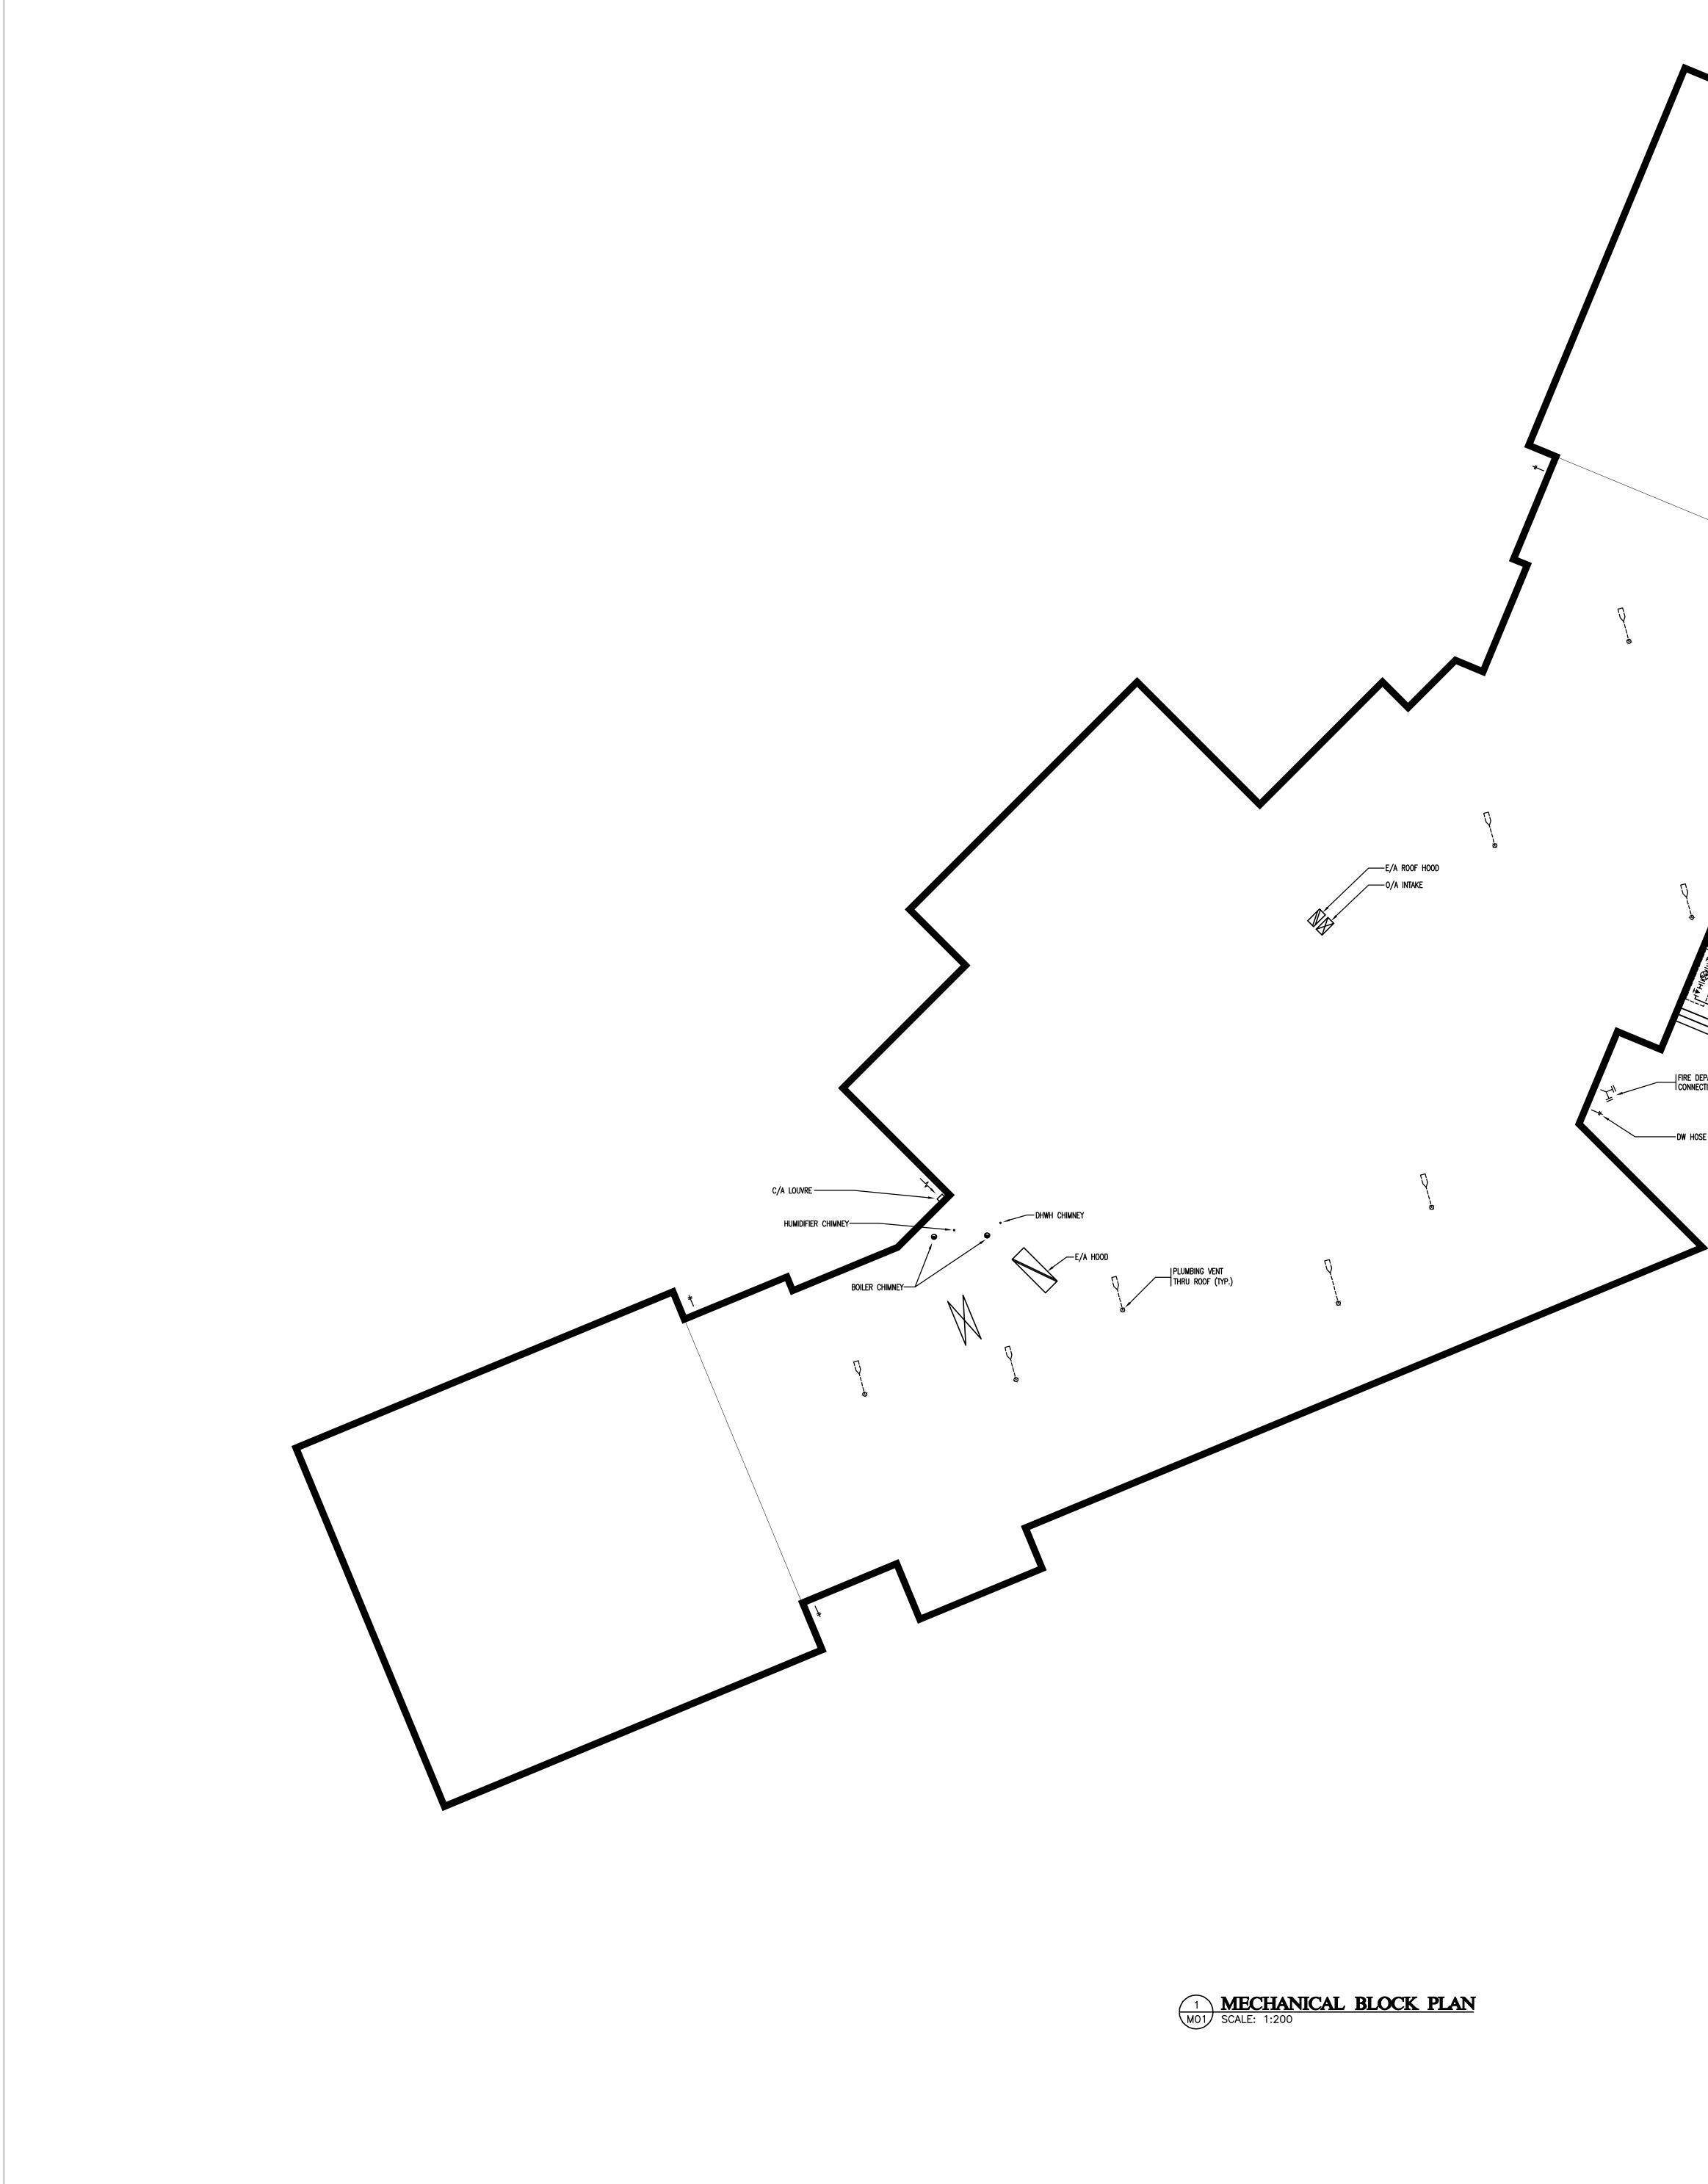


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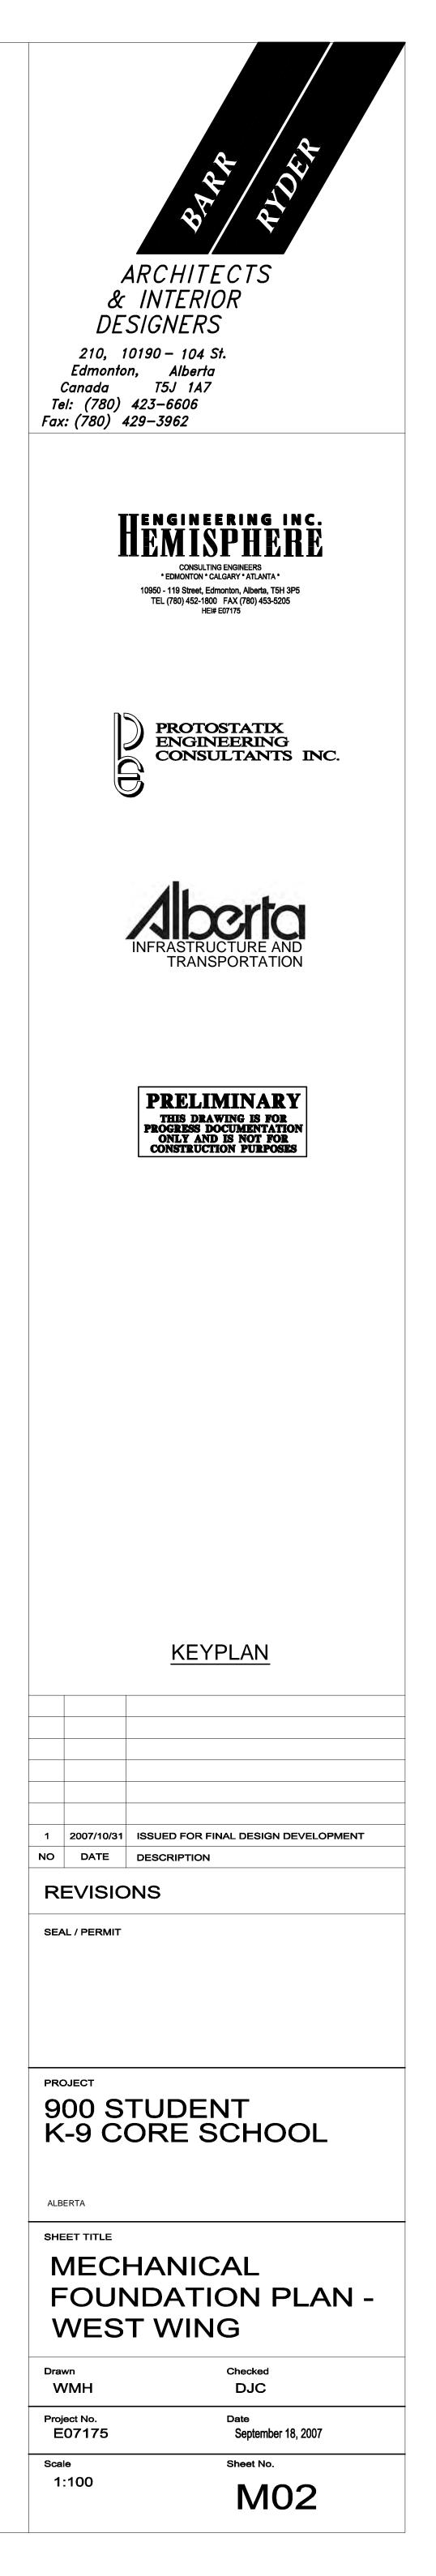


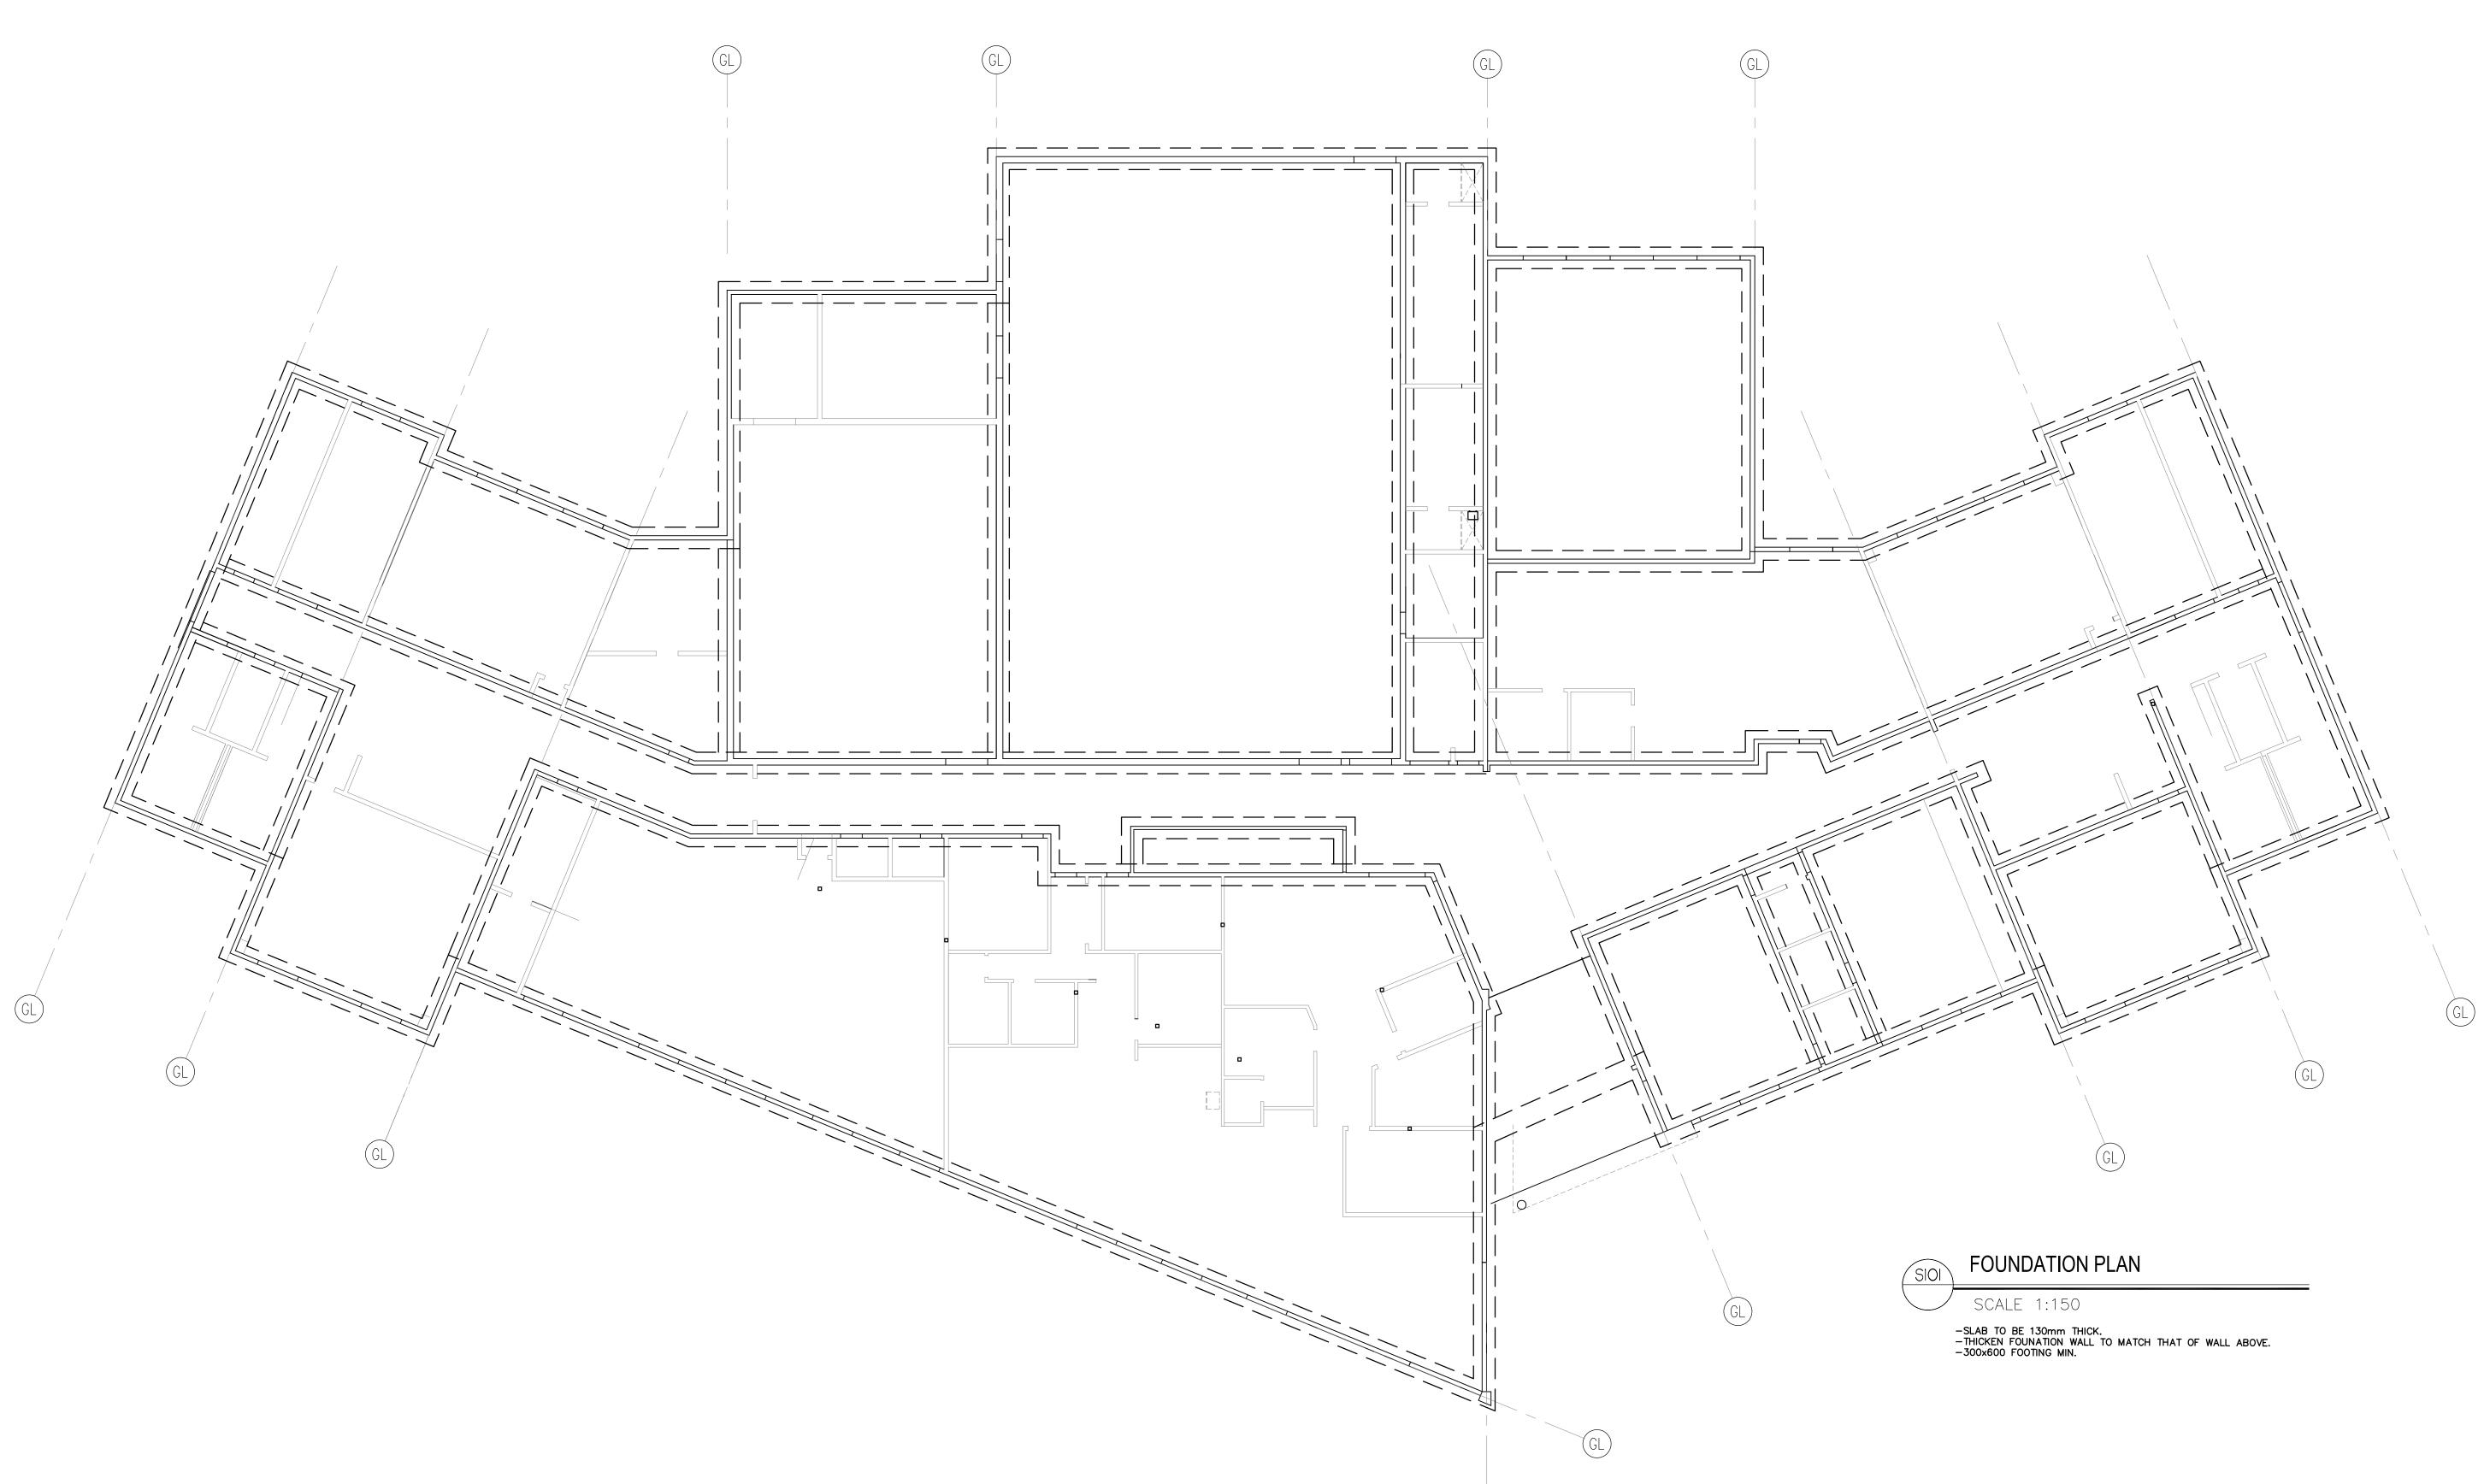


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|---|--|
| | ELBOW RISING |
| | TOP TAKEOFF |
| | BOTTOM TAKEOFF |
| | ELBOW DROPPING |
| | SHUTOFF VALVE VERTICAL MOUNT |
| | THROTTLING VALVE |
| | CHECK VALVE |
| | 2-WAY CONTROL VALVE |
| | 3-WAY CONTROL VALVE |
| | MECHANICAL PRESSURE REDUCING Y RELIEF VALVE |
| | UNION OR FLANGE |
| | |
| | AUTOMATIC AIR VENT |
| | CAP OR PLUG |
| | PUMP |
| | NEW THERMOSTAT/THERMOSTAT C/ |
| | SWITCH |
| | THERMOMETER/THERMOMETER & PR |
| | PRESSURE GAUGE/PRESSURE TAP - |
| | FLOW METER |
| | |
| | FIRE EXTINGUISHER C/W CABINET (FIRE HOSE CABINET |
| | SIAMESE CONNECTION |
| | SANITARY DRAIN |
| | STORM DRAIN |
| | ACID WASTE |
| | |
| | INDIRECT DRAIN |
| | DOMESTIC HOT WATER |
| | DOMESTIC HOT WATER RECIRC. |
| | GAS-LOW PRESSURE |
| | CLEANOUT |
| | FLOOR DRAIN |
| | HUB DRAIN |
| | ROOF DRAIN |
| | PLUMBING FIXTURE (TYPE NOTED) - |
| | REDUCED BACKFLOW PRESSURE AS |
| | SANITARY VENT CAP |
| | RUNNING TRAP |
| | FIRE HYDRANT |
| | MANHOLE |
| | CATCH BASIN |
| | SUPPLY DUCT (UP & DOWN) |
| | EXHAUST (UP & DOWN) |
| | ROUND DUCT (UP & DOWN) |
| | FLEXIBLE DUCT CONNECTION |
| | OPPOSED BLADE DAMPERS |
| DIAGRAMMATIC LOCATION | MOTORIZED DAMPER |
| OF GAS METER. | |
| CONFIRM EXACT LOCATION ON SITE. CO-ORDINATE WITH WINDOW LOCATION. | DIFFUSER |
| | FIRE DAMPER OR SMOKE DAMPER- |
| | |
| | ACOUSTIC LINED DUCTWORK |
| CONNECT NEW GAS, WATER, SANITARY AND | |
| STORM PIPING TO EXISTING CITY SERVICE. | |
| DETERMINE EXACT | AIR OUTLET OR INLET |
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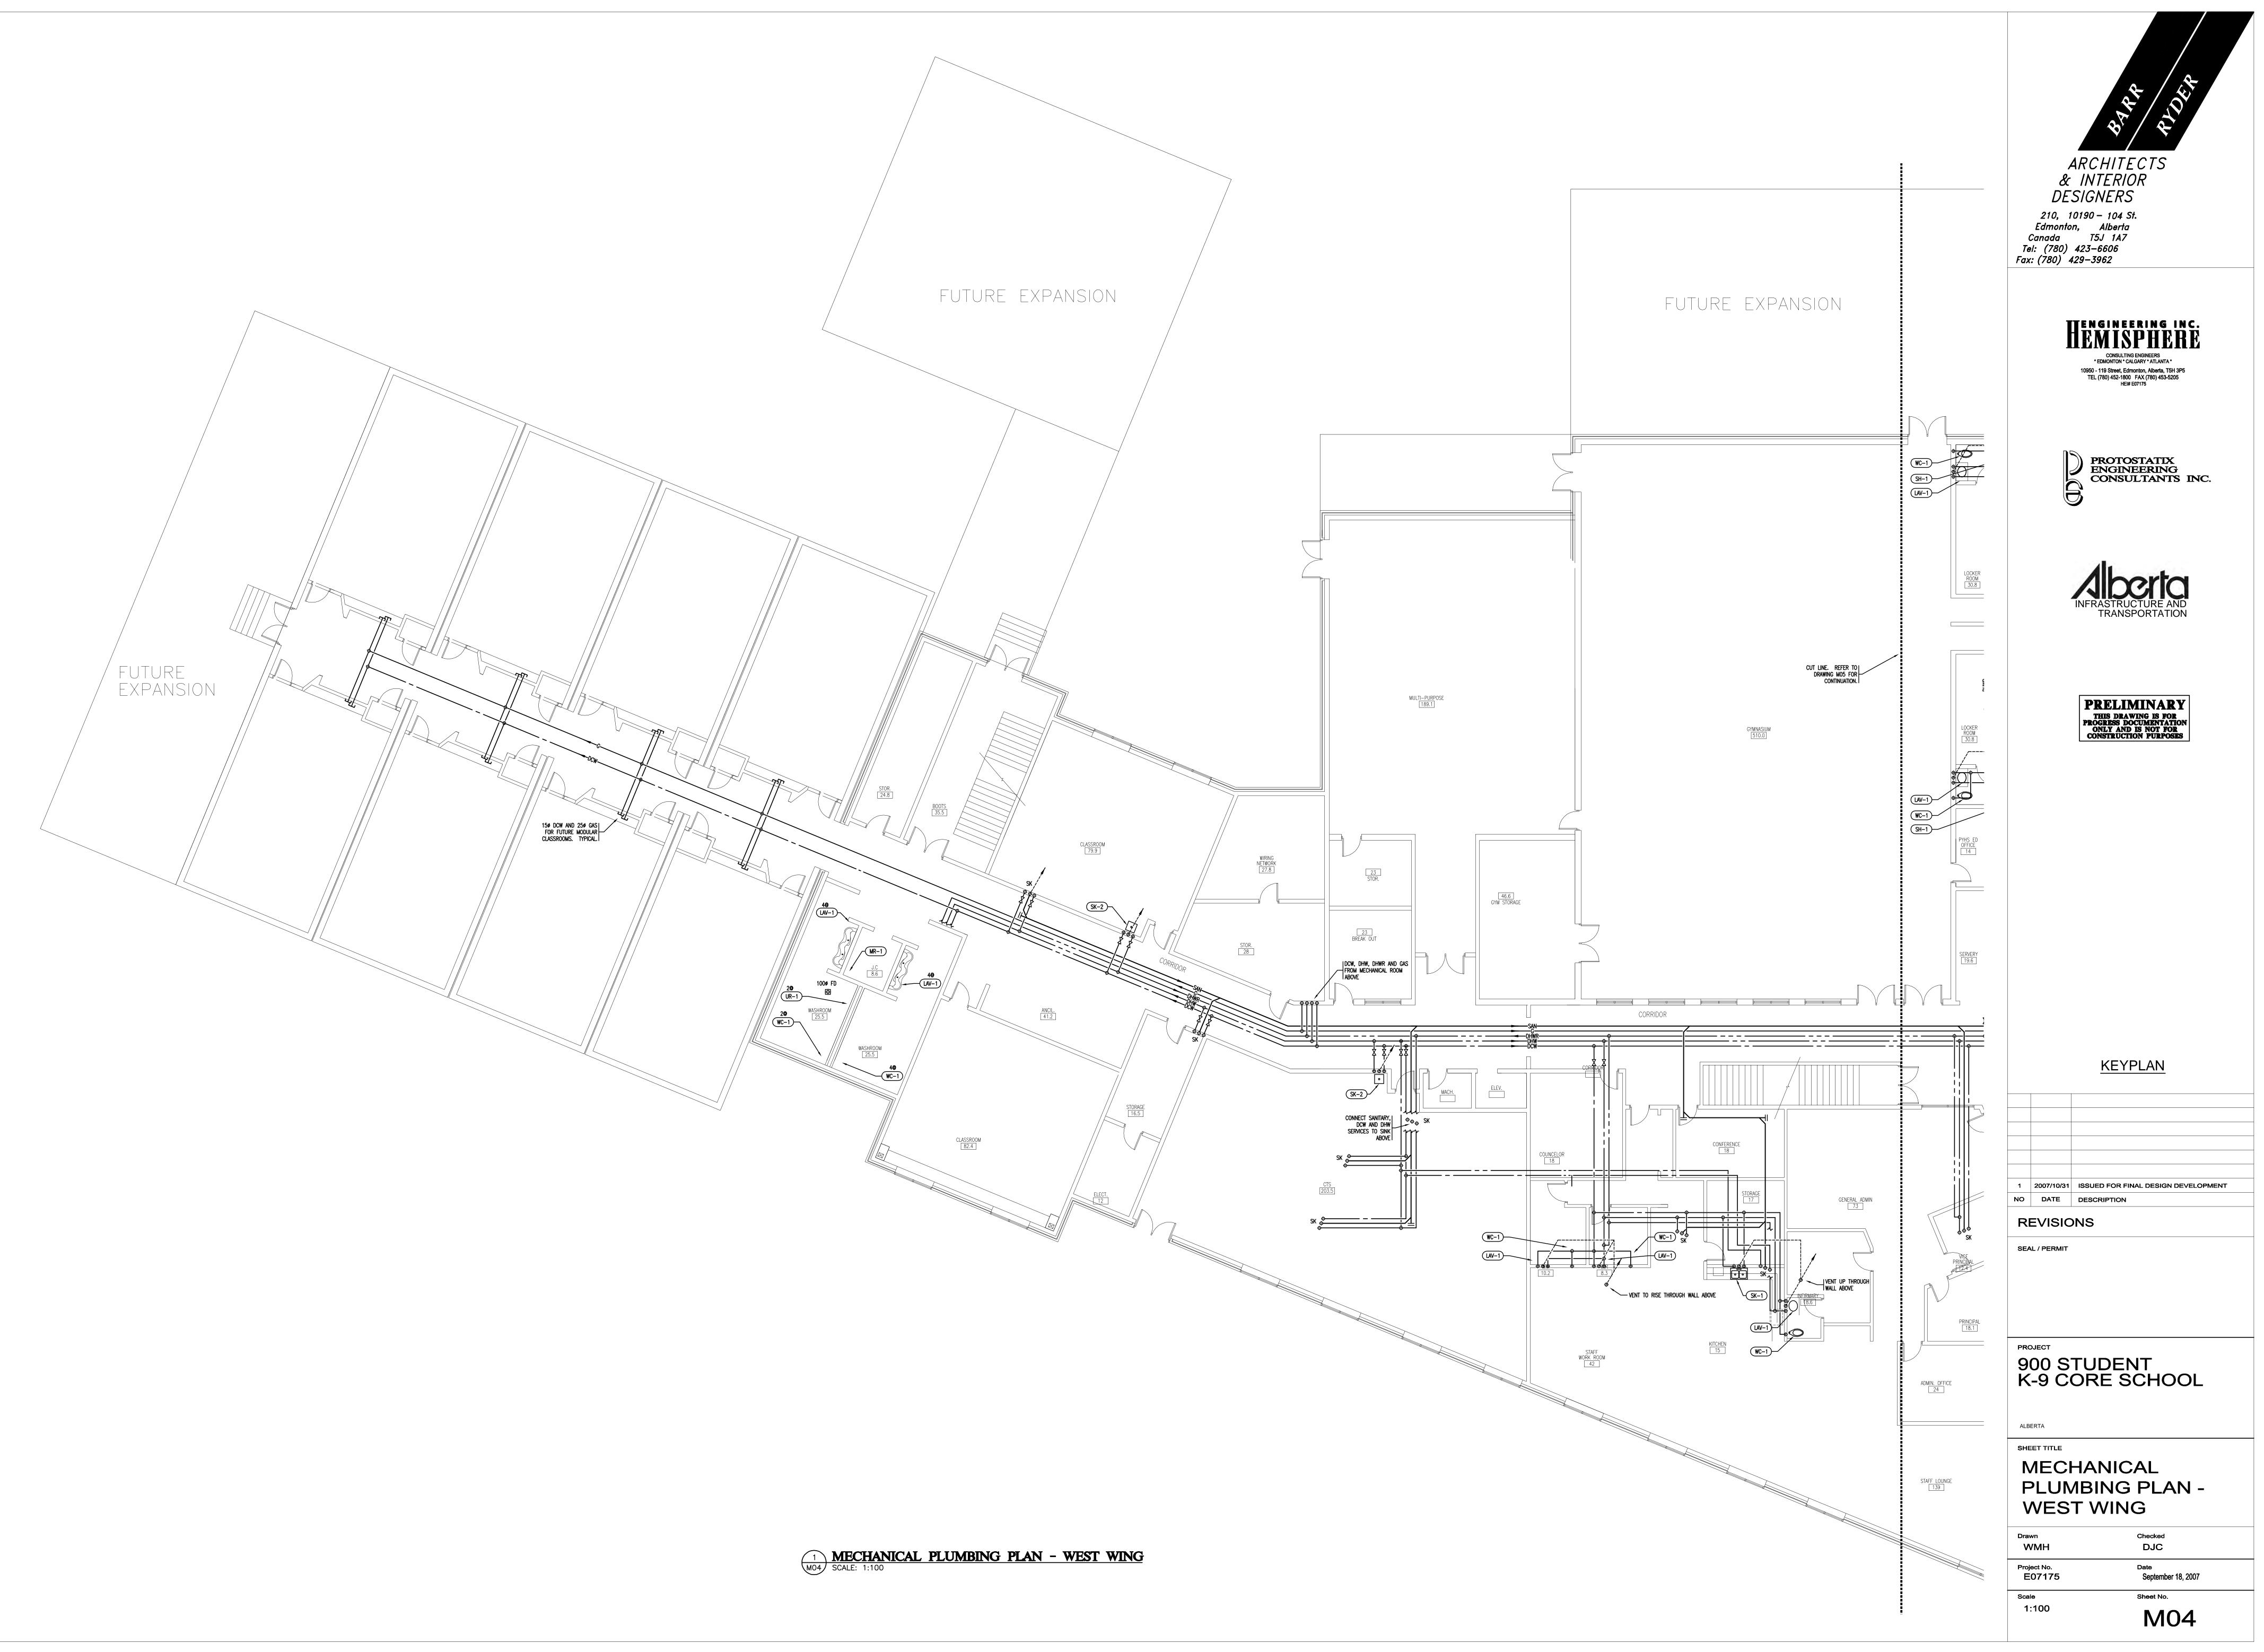
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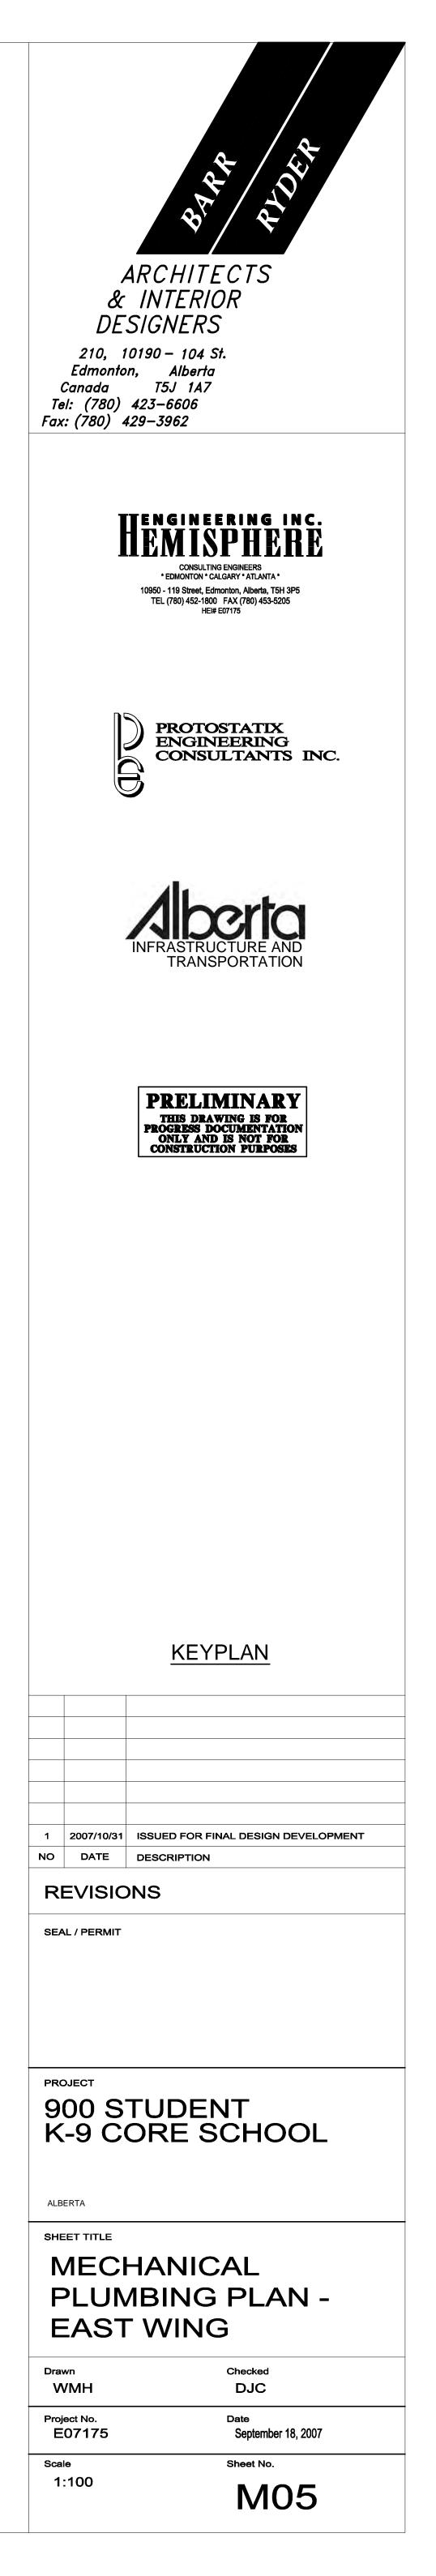


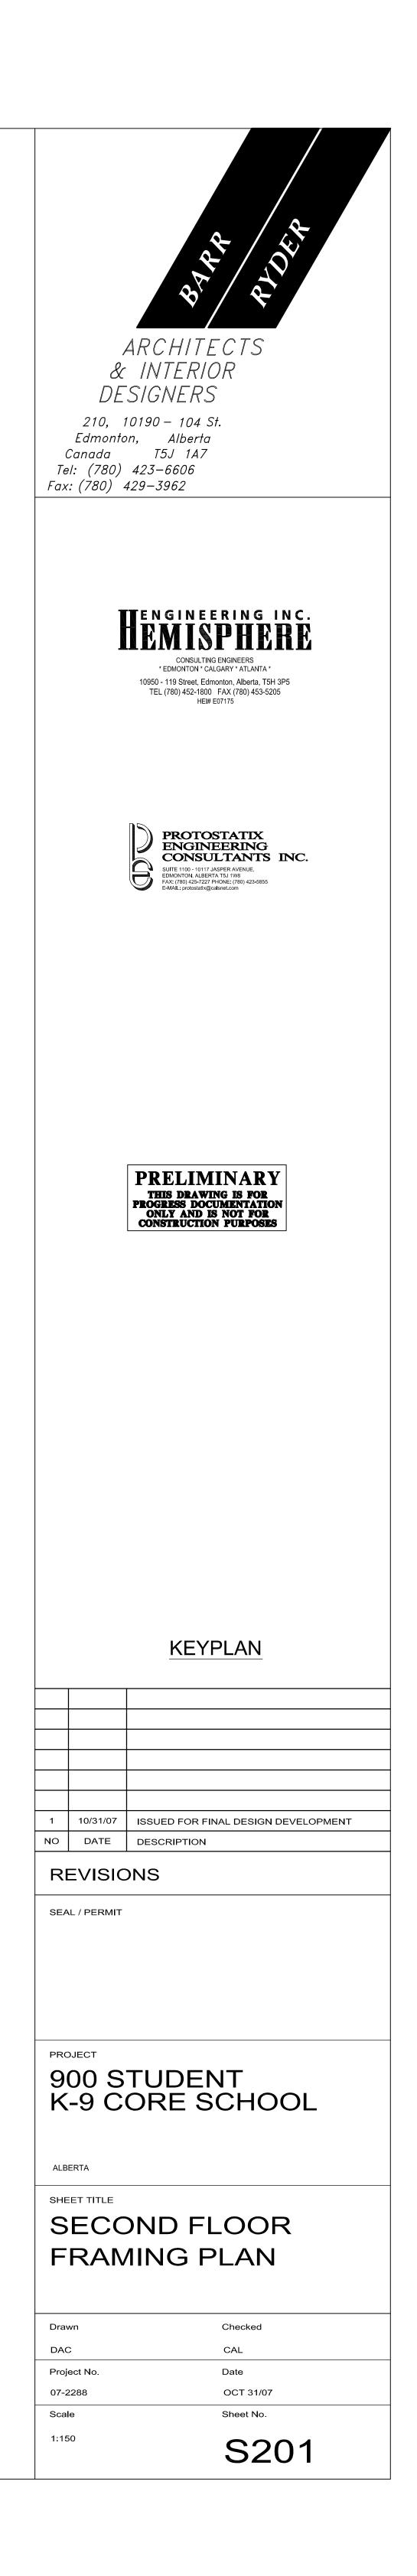

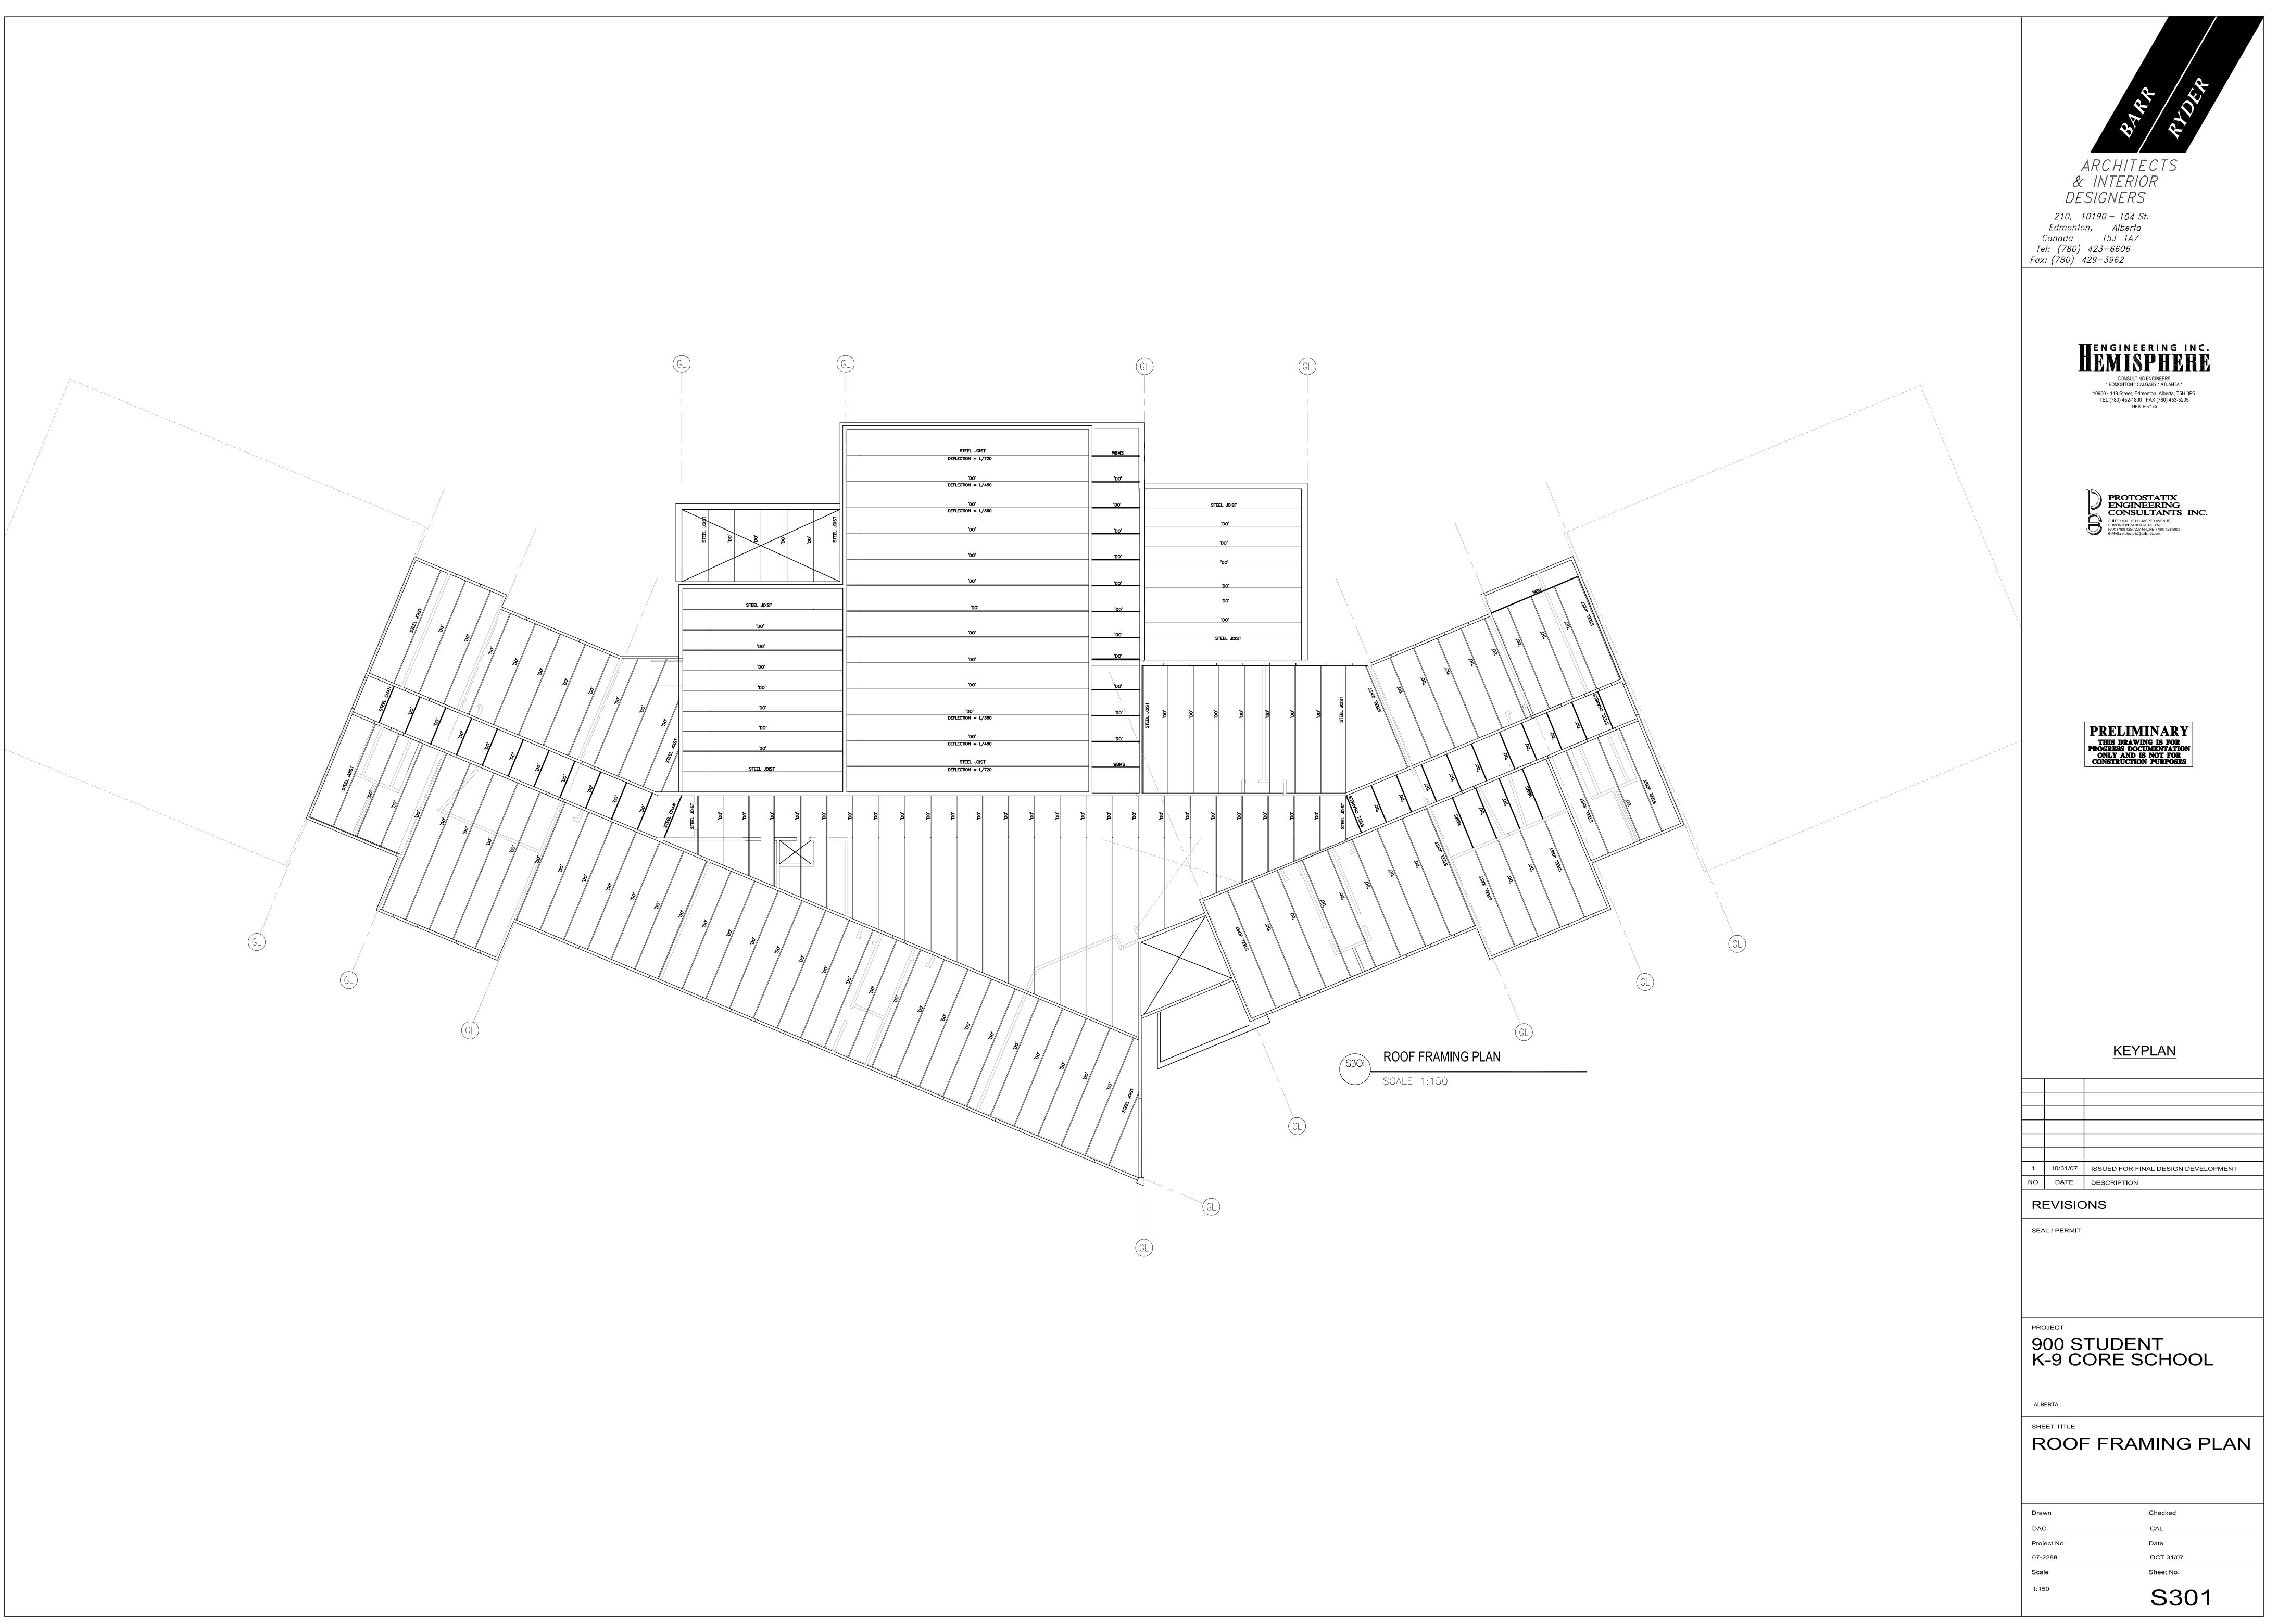ARCHITECTS & INTERIOR DESIGNERS 210, 10190 – 104 St. Edmonton, Alberta Canada T5J 1A7 Tel: (780) 423–6606 Fax: (780) 429–3962 CONSULTING ENGINEERS * EDMONTON * CALGARY * ATLANTA* 10950 - 119 Street, Edmonton, Alberta, T5H 3P5 TEL (780) 452-1800 FAX (780) 453-5205 HEI# E07175 PROTOSTATIX ENGINEERING CONSULTANTS INC. RASTRUCTURE AND TRANSPORTATION PRELIMINARY THIS DRAWING IS FOR PROGRESS DOCUMENTATION ONLY AND IS NOT FOR CONSTRUCTION PURPOSES <u>KEYPLAN</u> 1 2007/10/31 ISSUED FOR FINAL DESIGN DEVELOPMENT NO DATE DESCRIPTION REVISIONS SEAL / PERMIT PROJECT 900 STUDENT K-9 CORE SCHOOL ALBERTA SHEET TITLE MECHANICAL FOUNDATION PLAN -EAST WING Checked Drawn WMH _____ Project No. E07175 Date September 18, 2007 Scale Sheet No. 1:100 M03



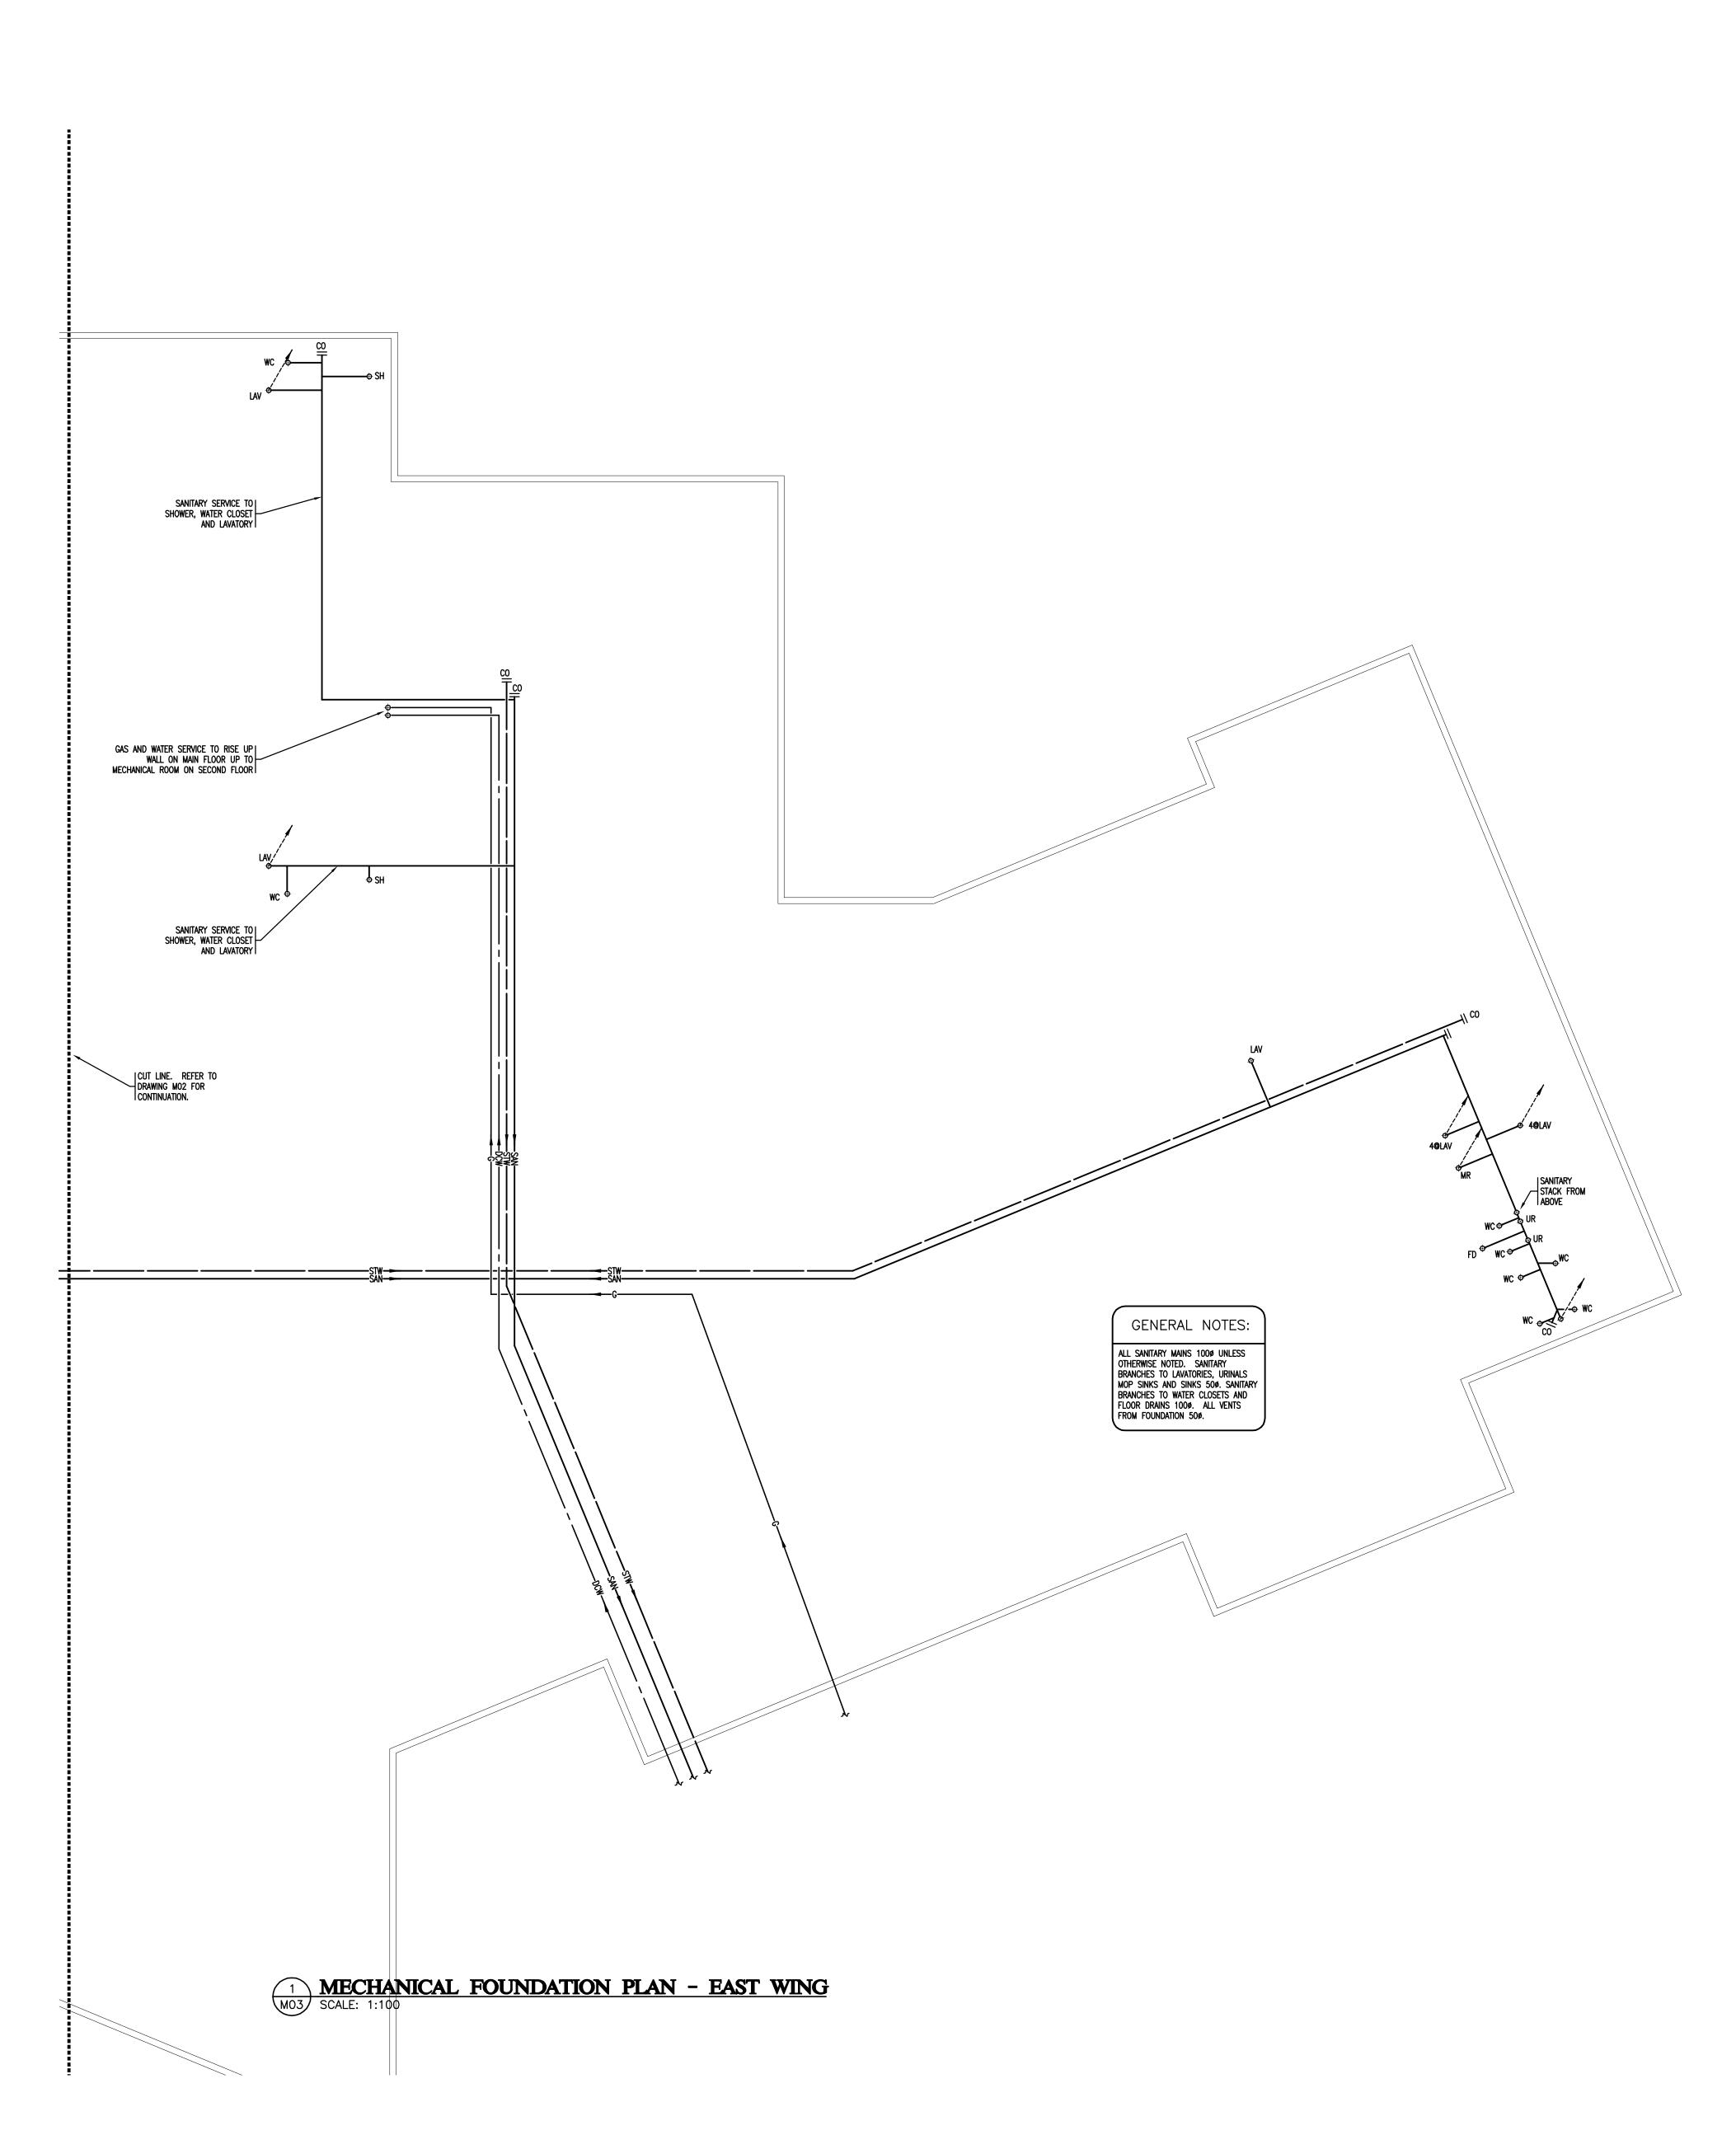









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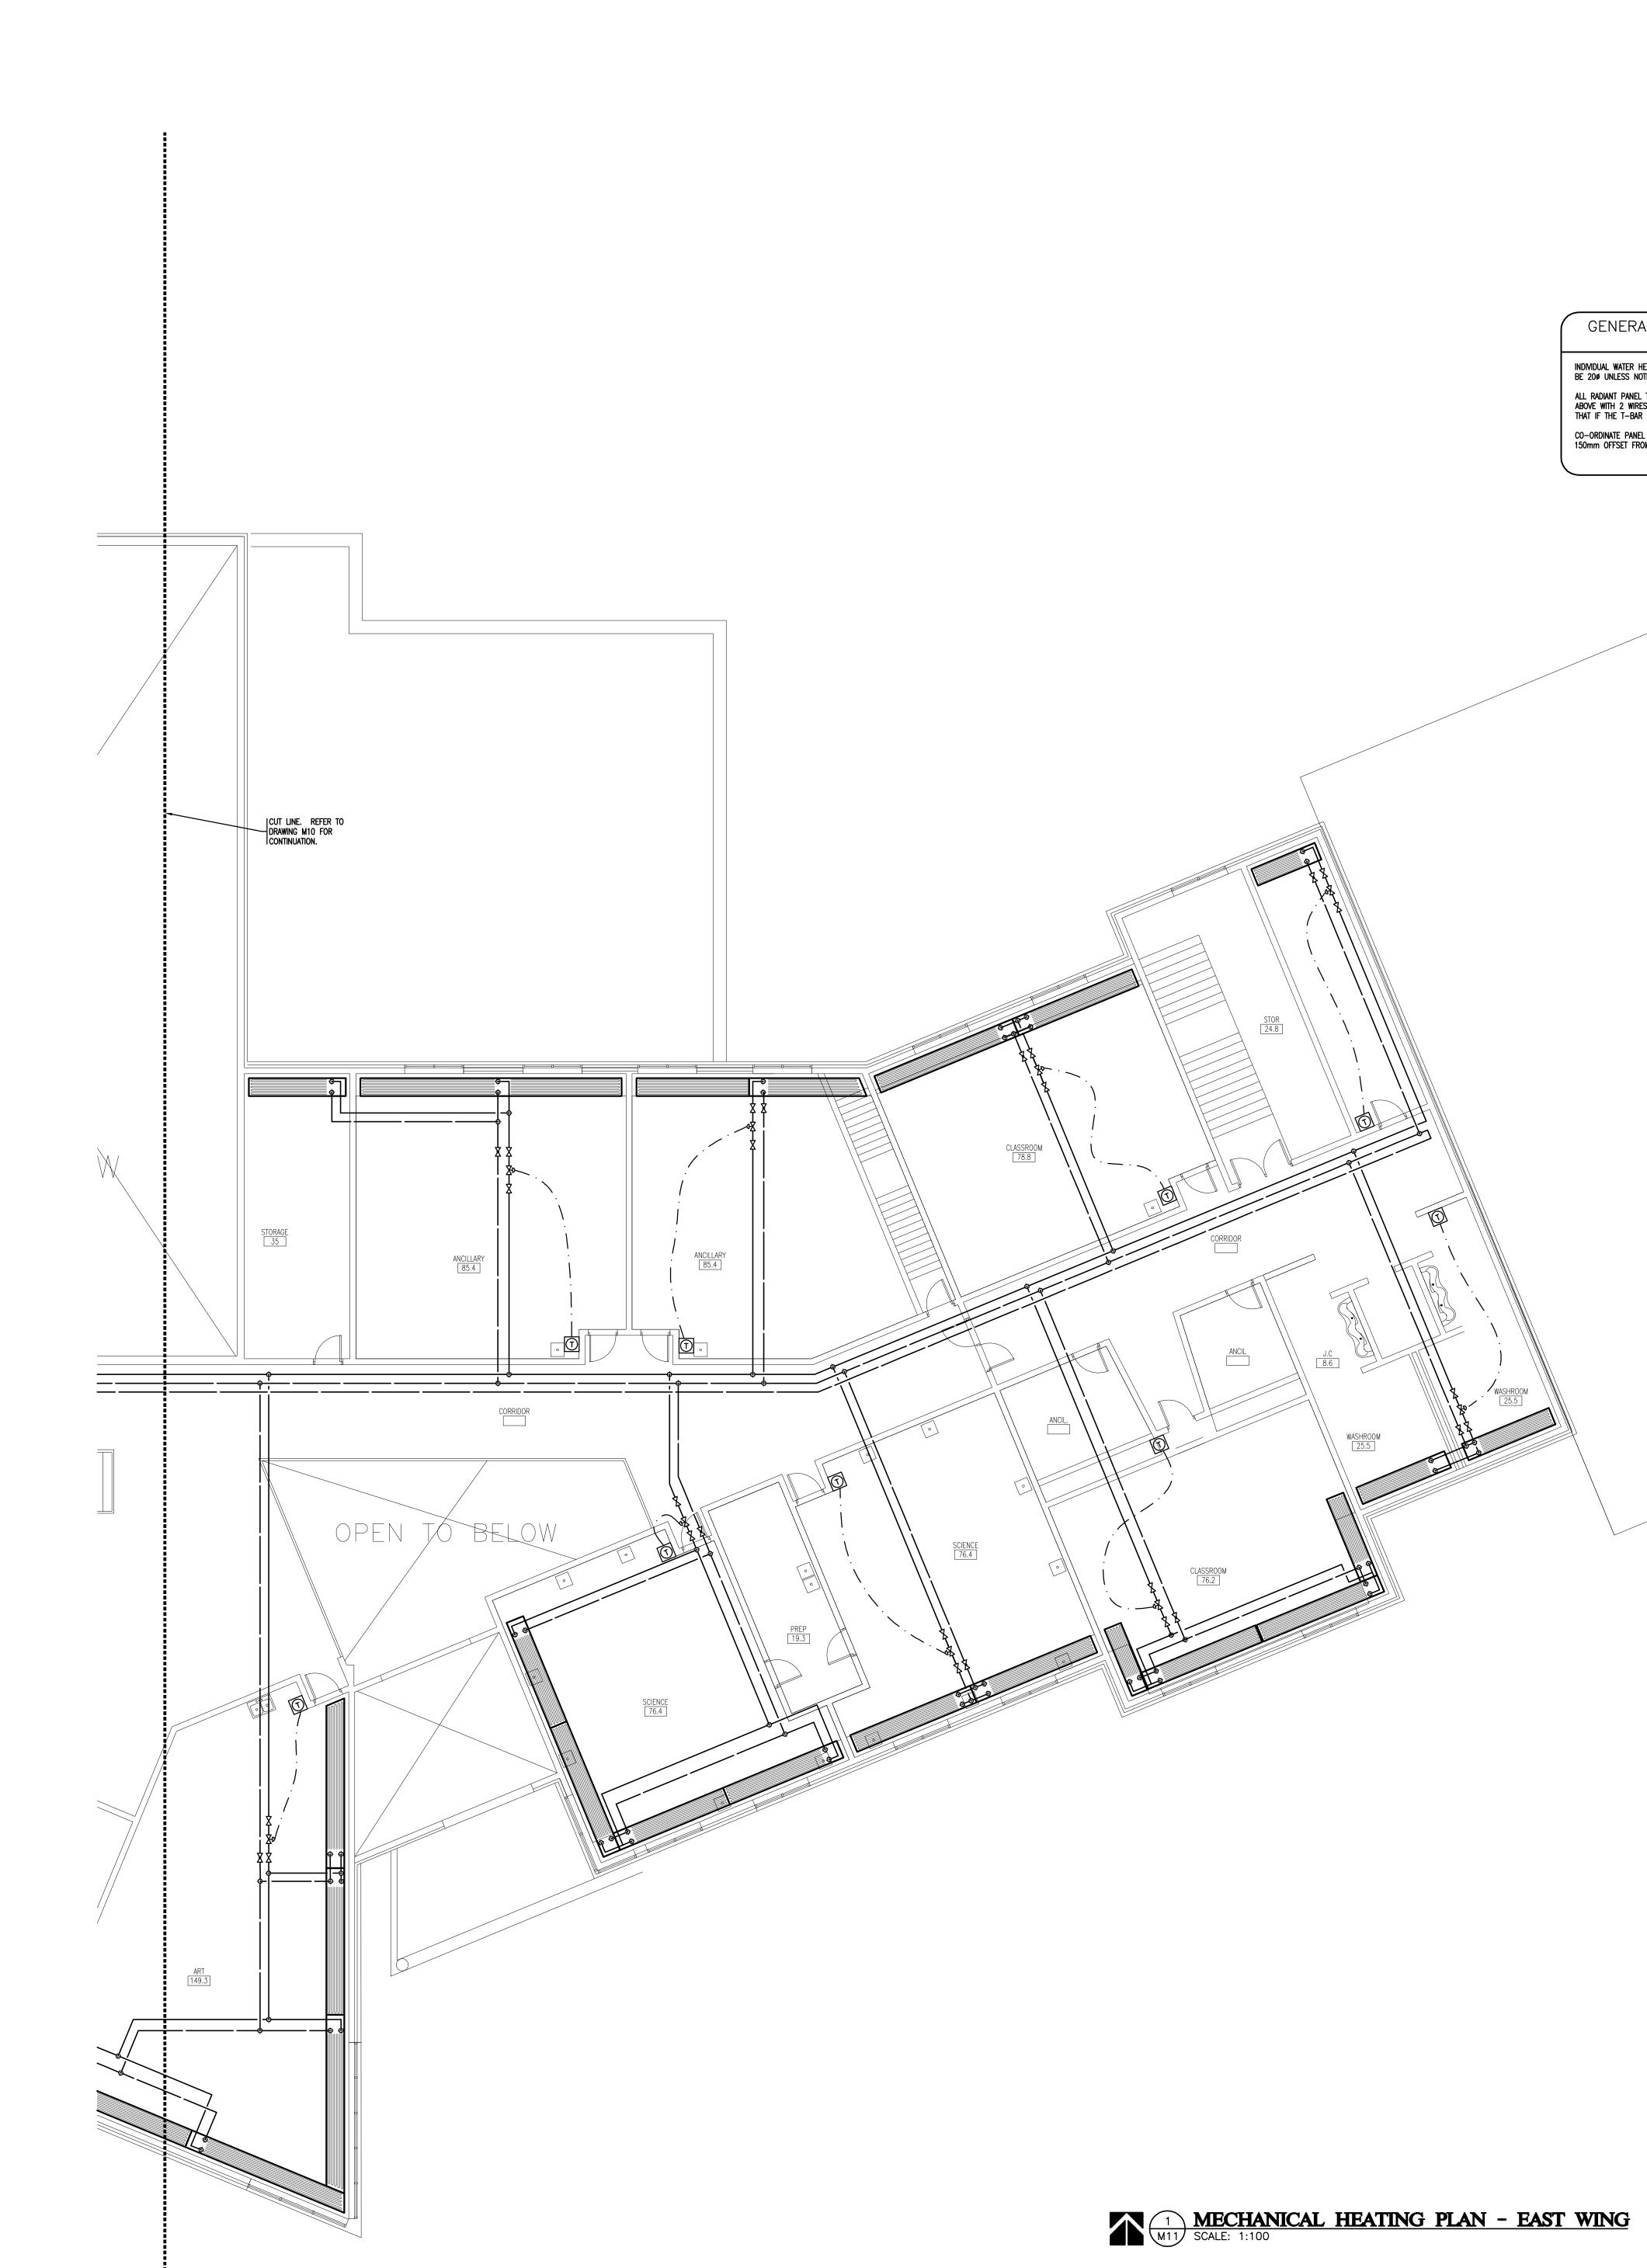
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| MECHANICAL SECOND FLOOR PLUMBING PLAN - EAST WING | |
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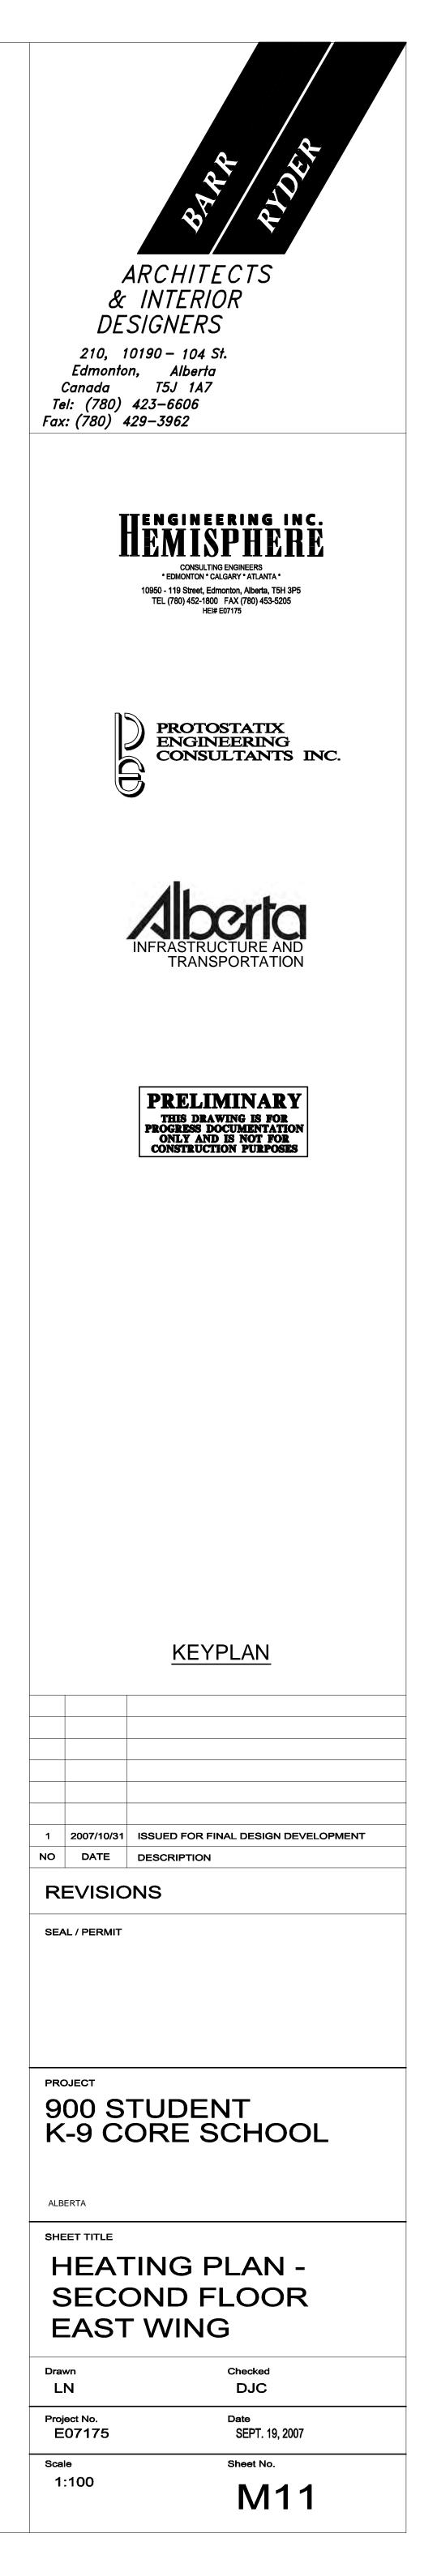







GENERAL NOTES:

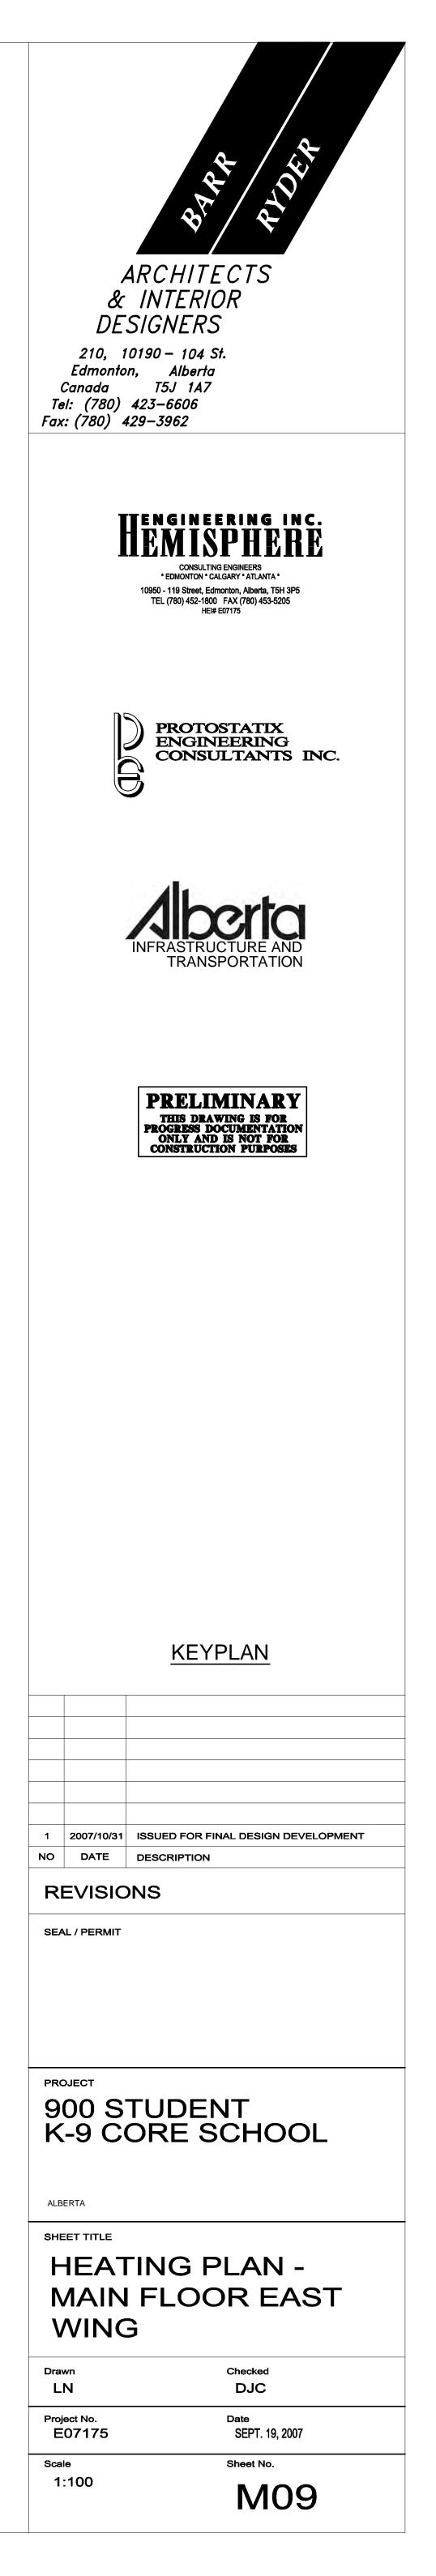INDIVIDUAL WATER HEATING PIPE SIZES TO RADIANT PANELS AND HEATING COILS TO BE 200 UNLESS NOTED OTHERWISE. ALL RADIANT PANEL TO BE SUPPORTED INDEPENDENTLY FROM THE ROOF SYSTEM ABOVE WITH 2 WIRES ON EACH CROSS BRACE APPROXIMATELY EVERY 900mm SUCH THAT IF THE T-BAR SYSTEM FAILS THE PANEL WILL REMAIN IN PLACE. CO-ORDINATE PANEL LOCATION WITH T-BAR LAYOUT. TYPICAL LOCATION WILL BE 150mm OFFSET FROM OUTSIDE WALL.

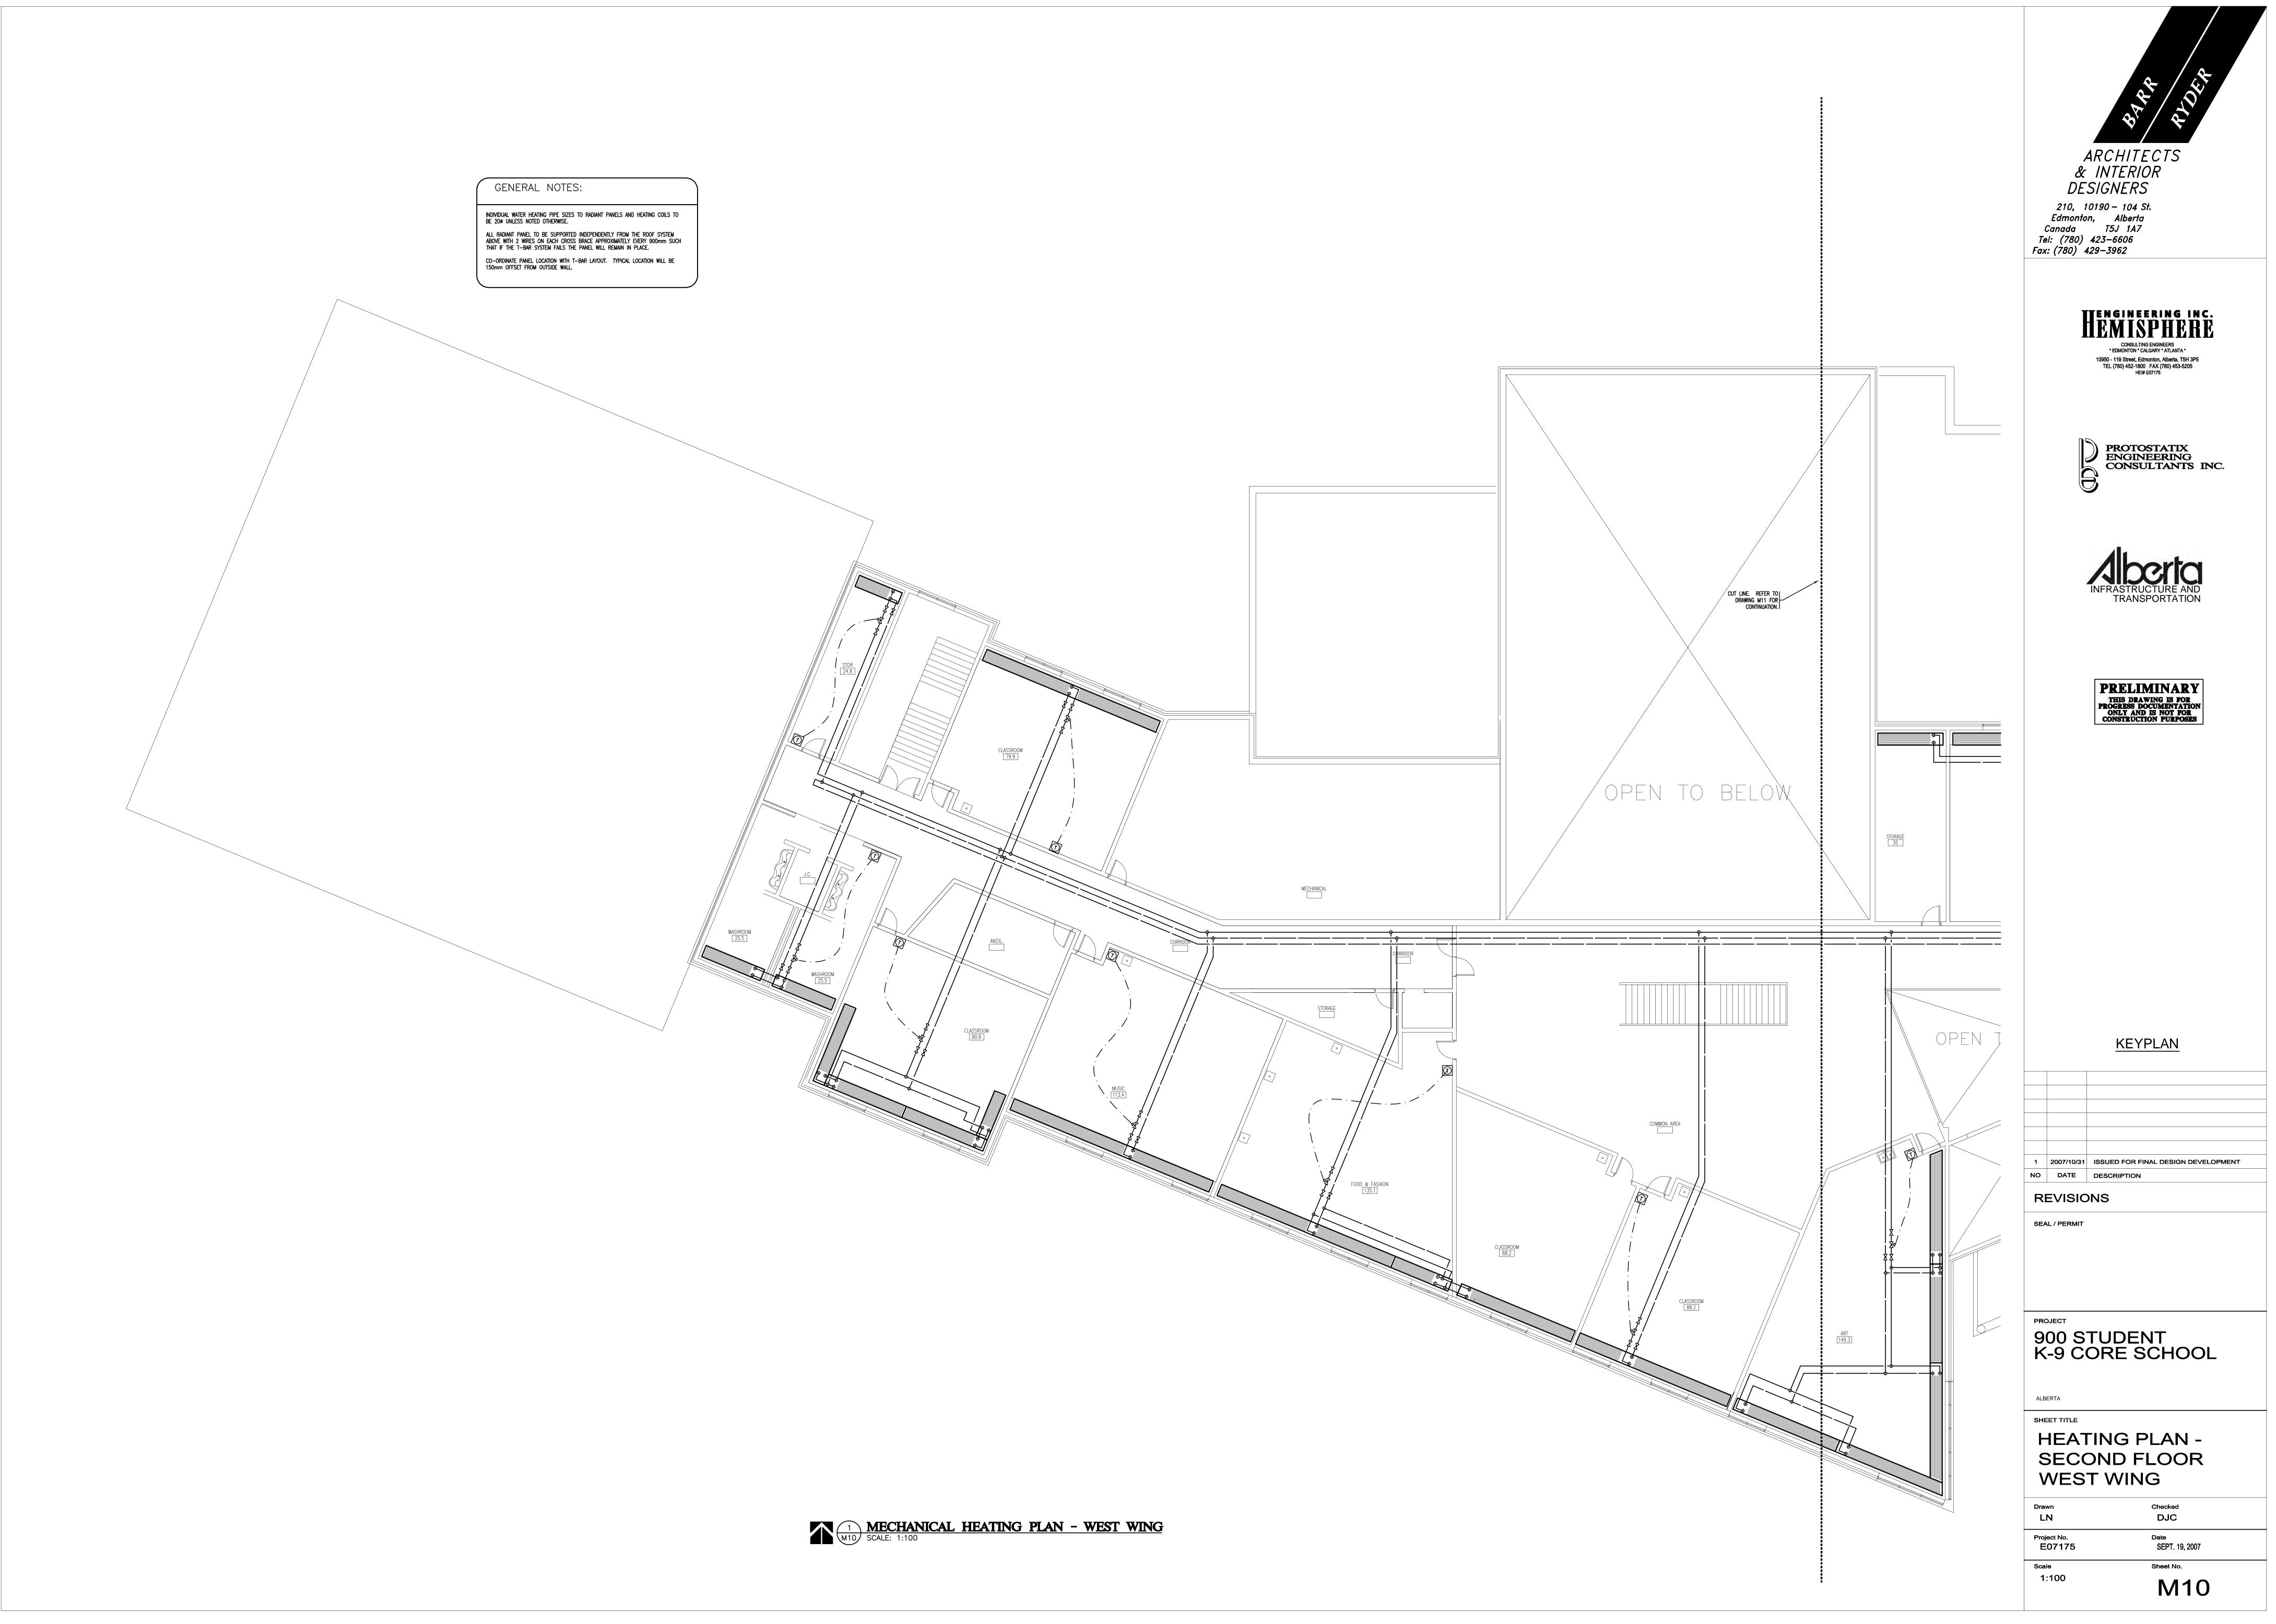





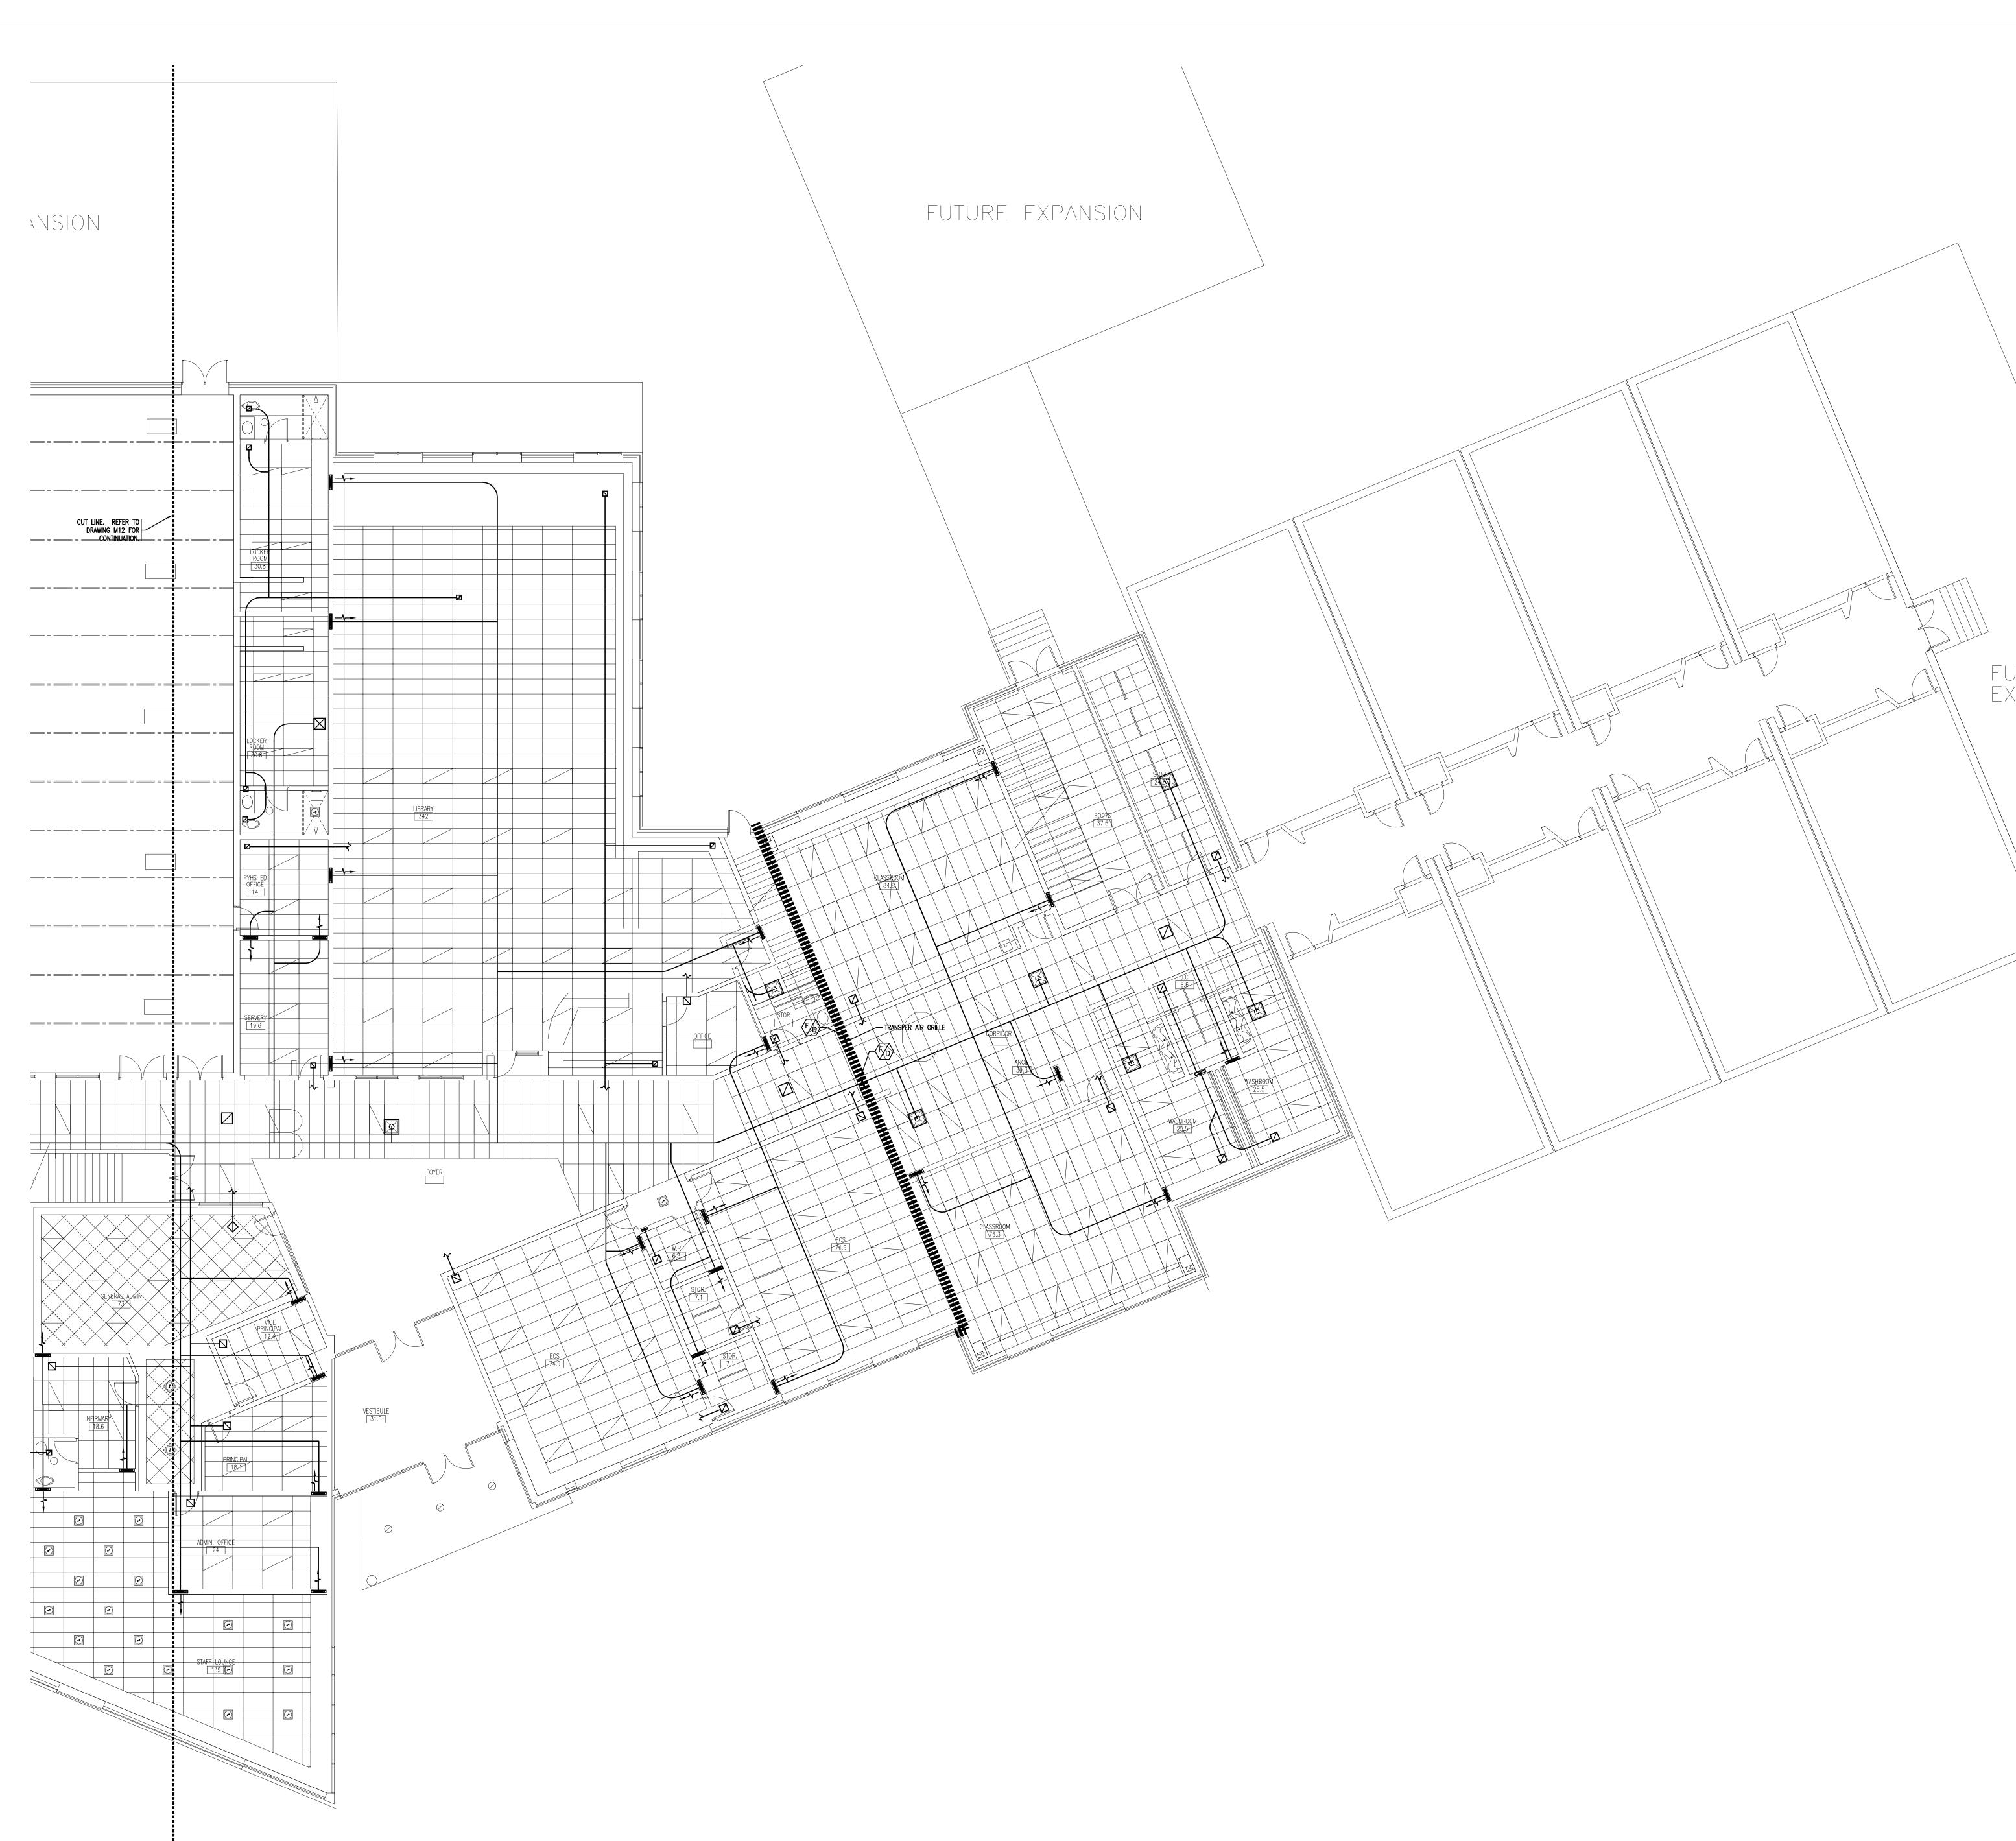

| | ARCHITECTS & INTERIOR DESIGNERS 210, 10190 – 104 St. Edmonton, Alberta Canada T5J 1A7 Tel: (780) 423–6606 Fax: (780) 429–3962 |
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| | EXAMPLE 1 Series Strain Stra |
| | PROTOSTATIX ENGINEERING CONSULTANTS INC. |
| PANSION | Aberte INFRASTRUCTURE AND TRANSPORTATION |
| | <section-header></section-header> |
| | KEYPLAN Image: |
| | PROJECT 900 STUDENT K-9 CORE SCHOOL ALBERTA SHEET TITLE VENTILATION PLAN MAIN FLOOR B.M.R. DJC Project No. E07175 Date SCHE Steet No. 1:100 Sheet No. M.13 |



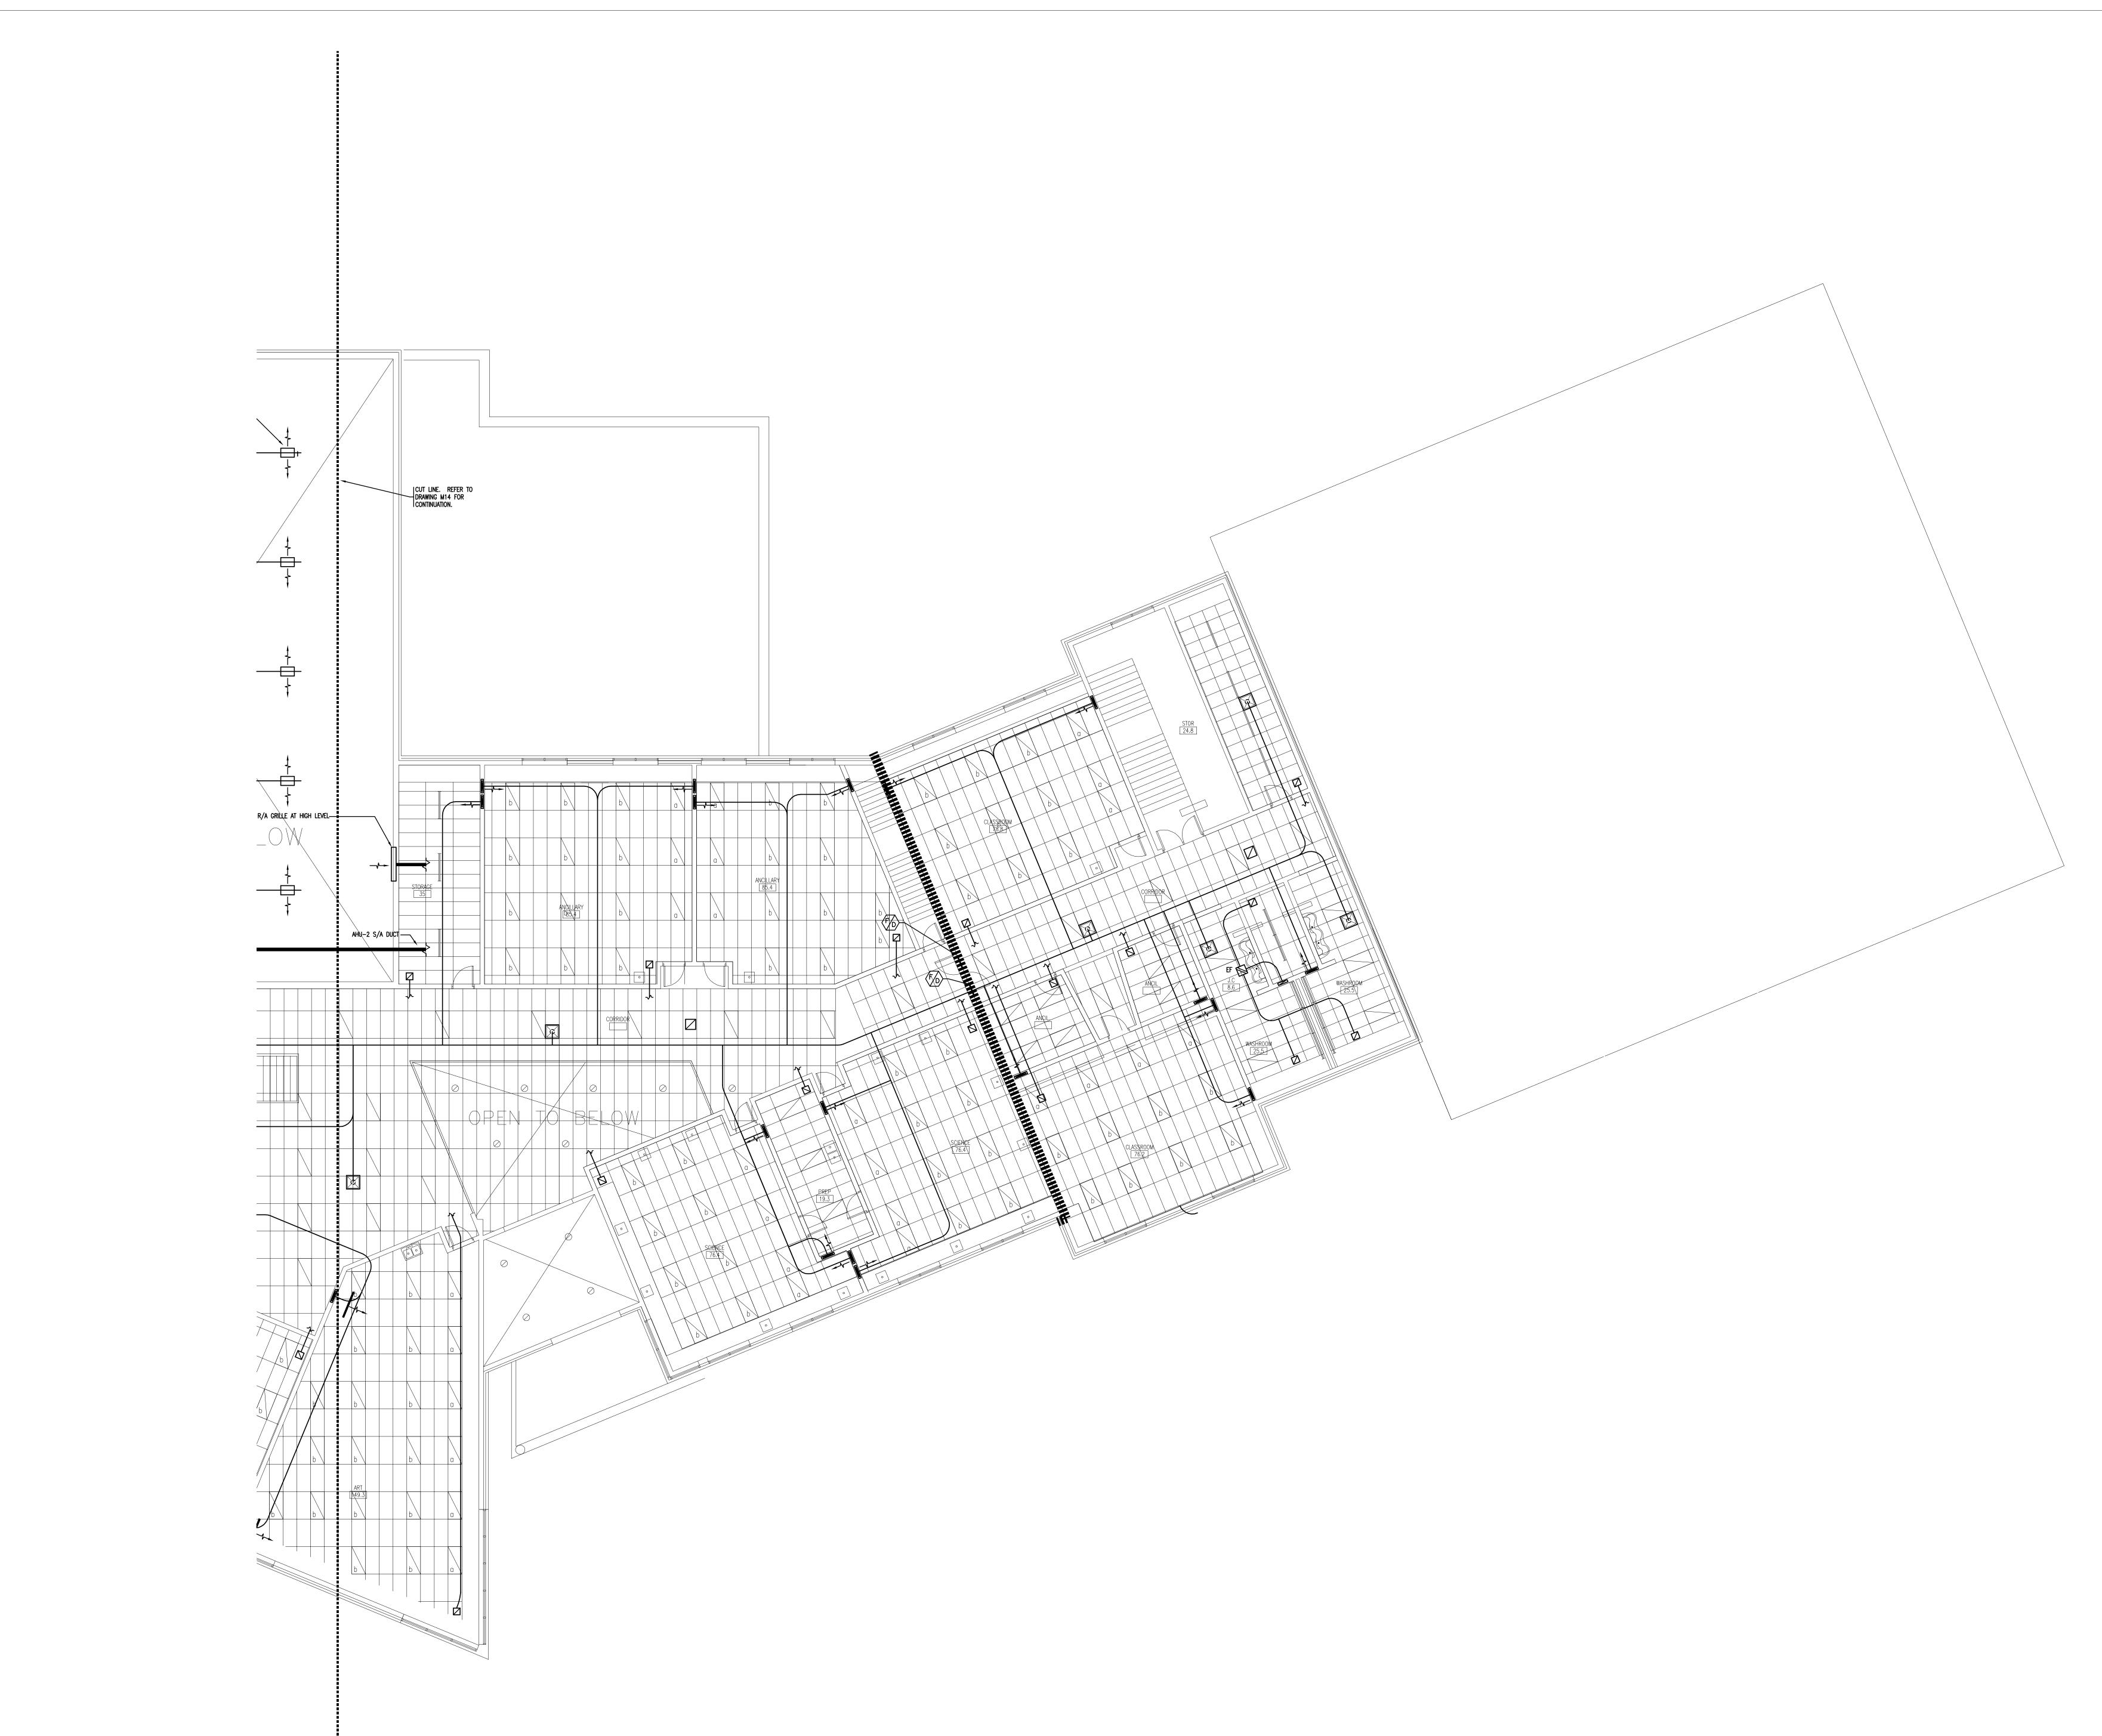

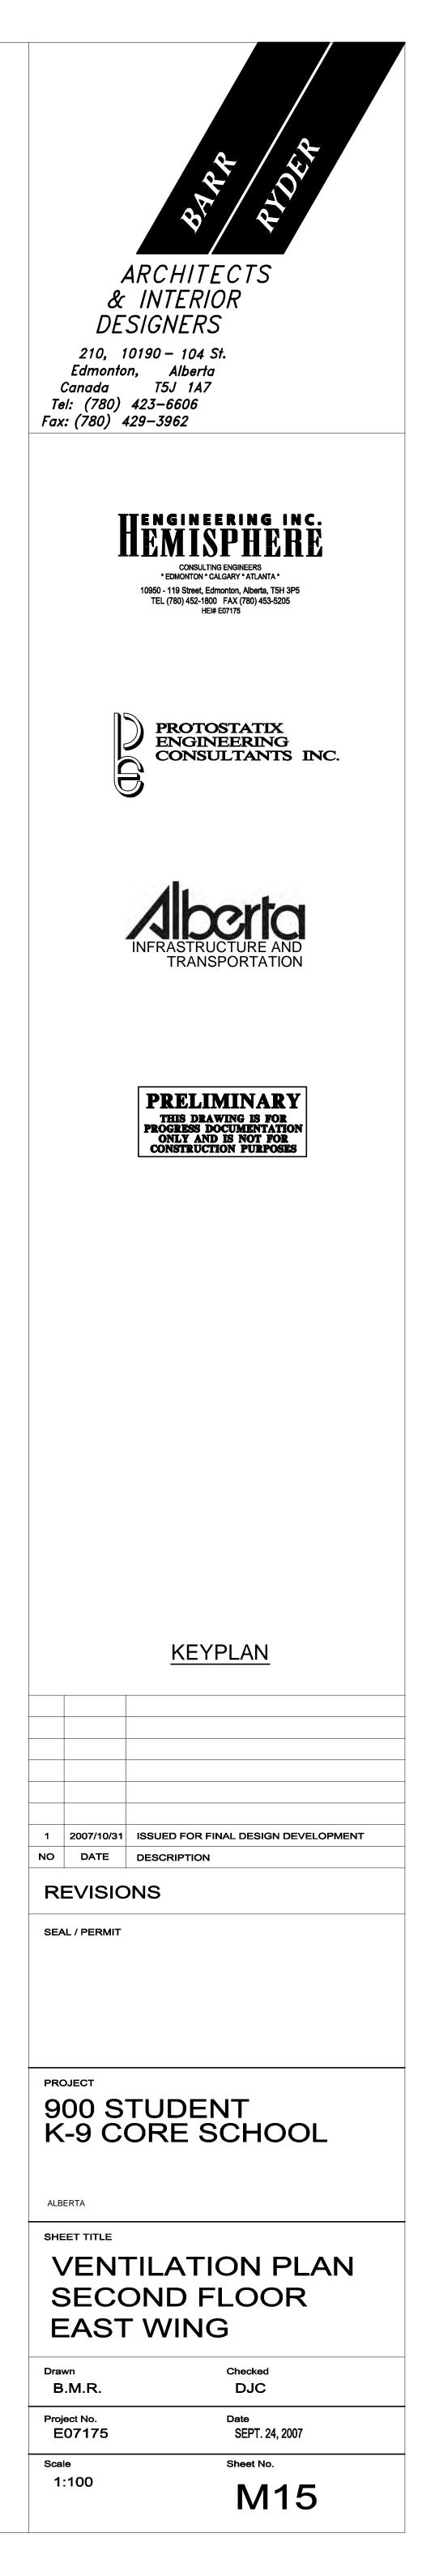







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| | EXAMPLE 1 Street, Edmonton, Alberta, T5H 3P5 TEL (780) 452-1800 FAX (780) 453-5205 HEI# E07175 |
| | PROTOSTATIX ENGINEERING CONSULTANTS INC. |
| JRE ANSION | Aberte INFRASTRUCTURE AND TRANSPORTATION |
| | PRELIMINARY THIS DRAWING IS FOR PROGRESS DOCUMENTATION ONLY AND IS NOT FOR CONSTRUCTION PURPOSES |
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| | |
| | 1 2007/10/31 ISSUED FOR FINAL DESIGN DEVELOPMENT NO DATE DESCRIPTION |
| | SEAL / PERMIT |
| | PROJECT 900 STUDENT K-9 CORE SCHOOL |
| | |
| | FIRE PROTECTION MAIN FLOOR EAST WING |
| | DrawnCheckedB.M.R.DJCProject No.DateE07175SEPT. 24, 2007 |
| | Scale Sheet No. 1:100 M17 |






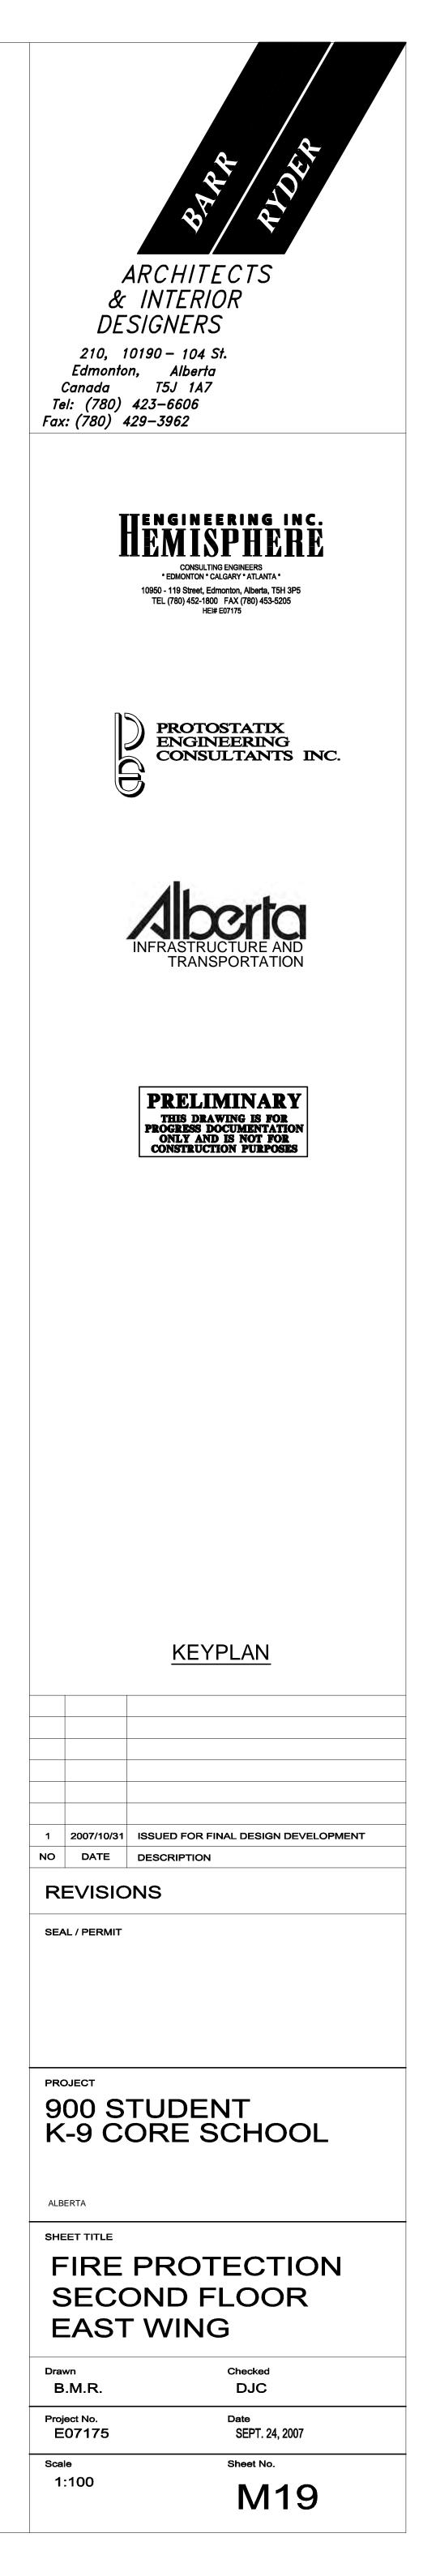


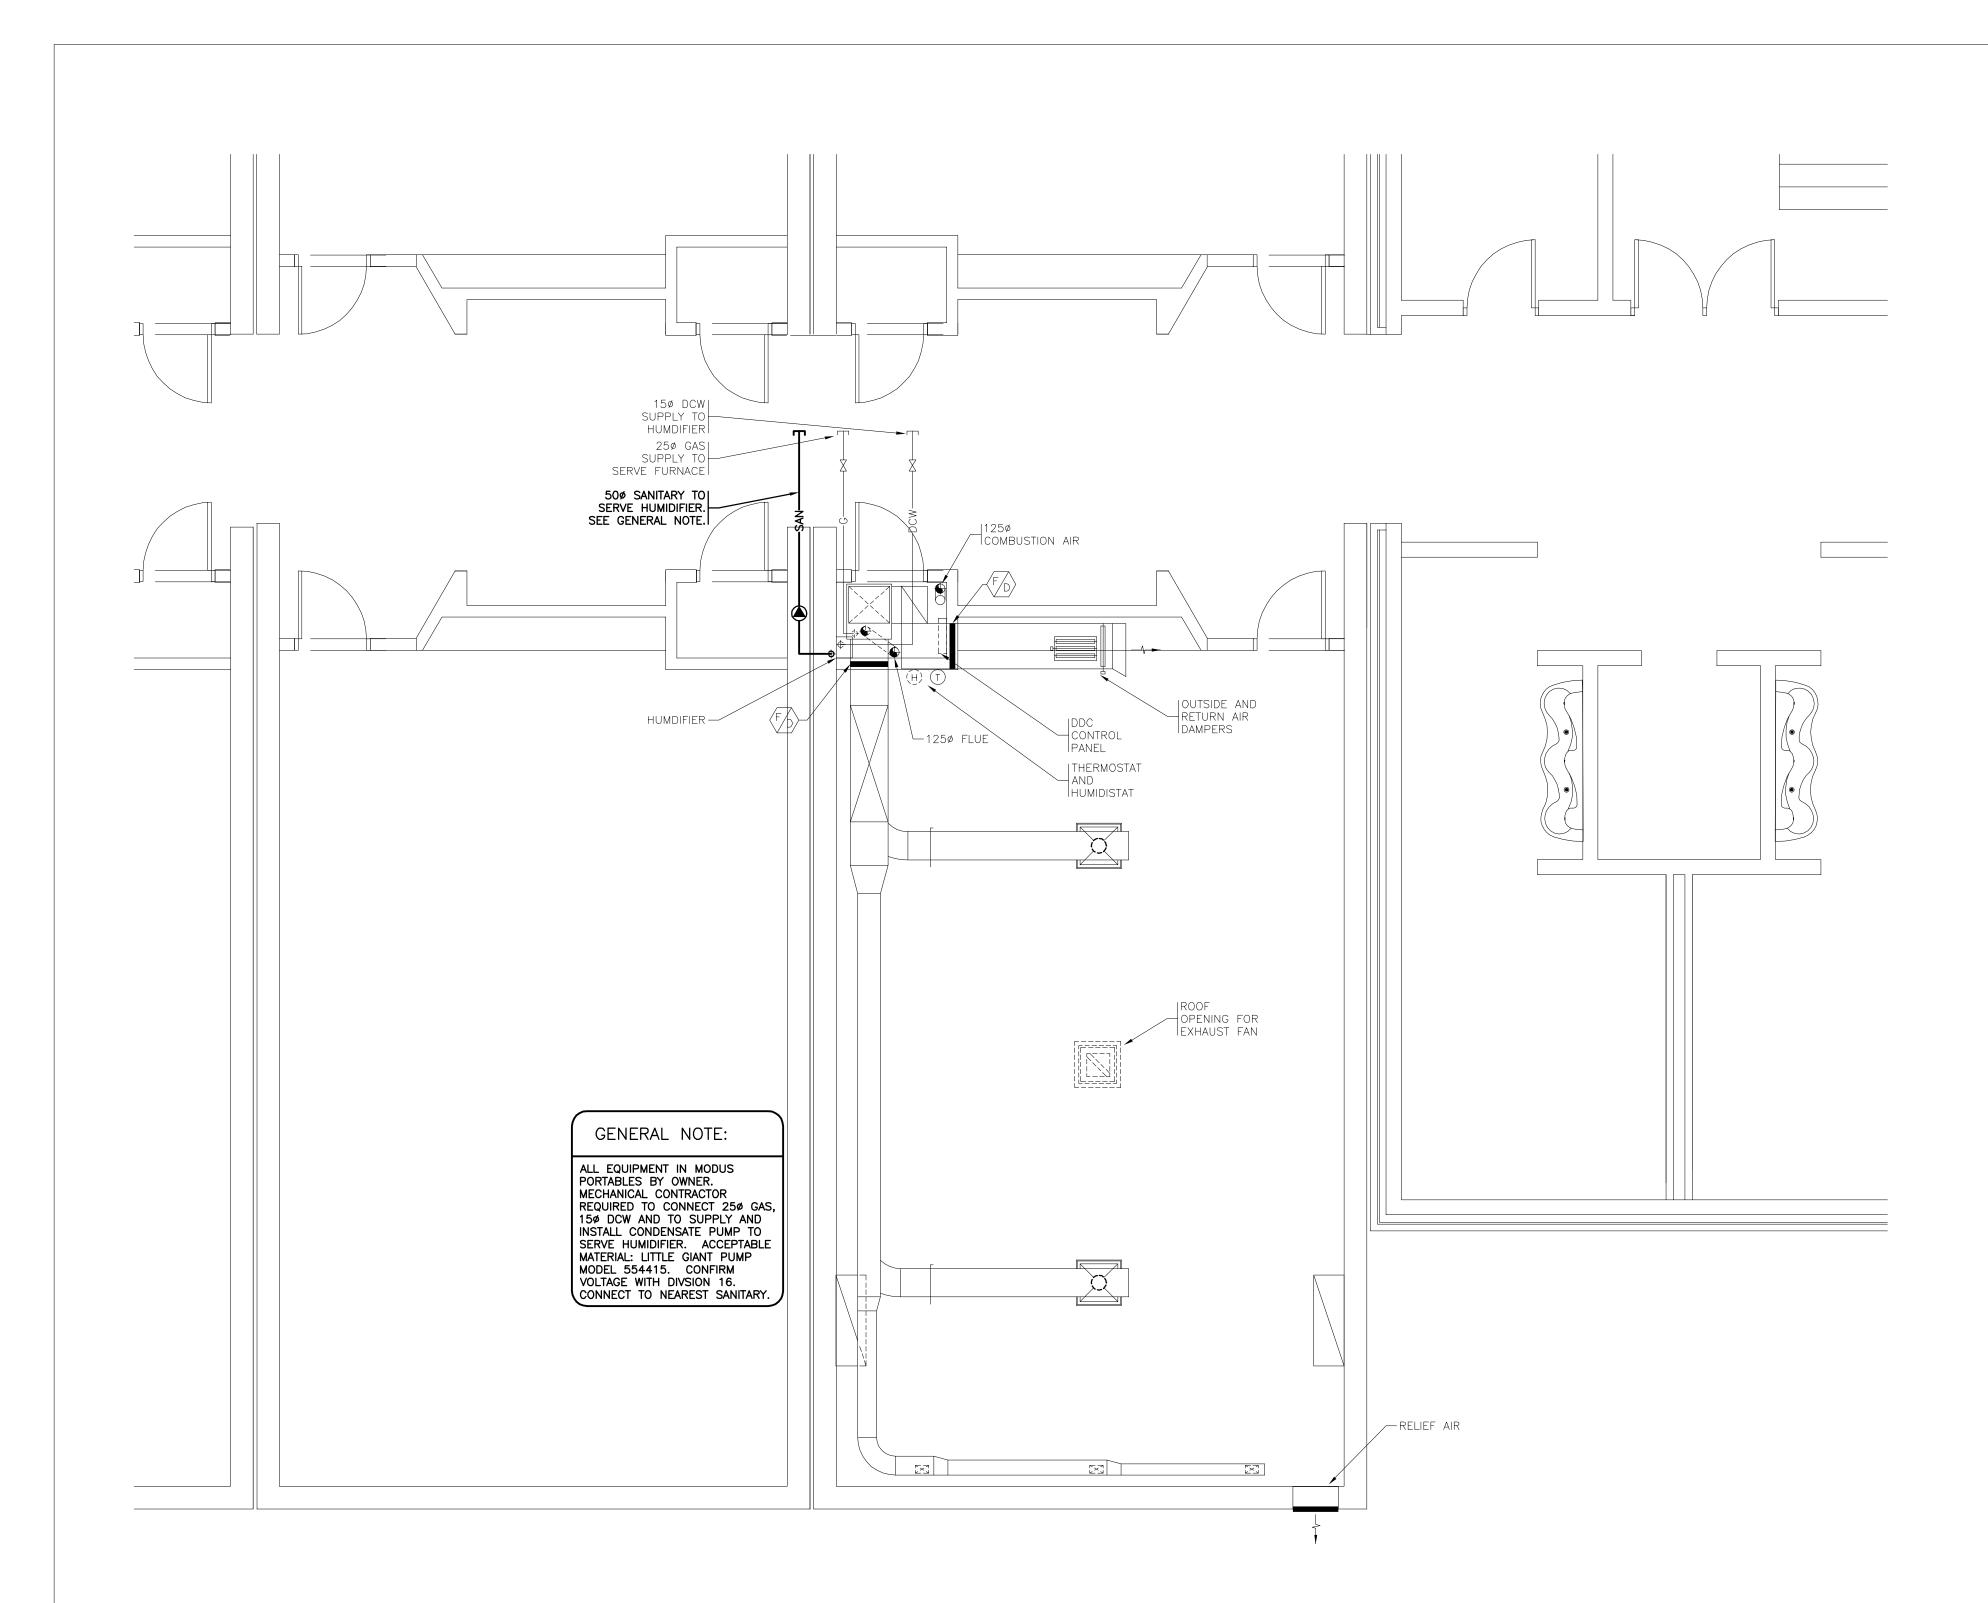


1 TYPICAL PORTABLE CLASSROOM PLAN (BY OTHERS) SCALE: 1:50


ARCHITECTS & INTERIOR DESIGNERS 210, 10190 – 104 St. Edmonton, Alberta Canada T5J 1A7 Tel: (780) 423–6606 Fax: (780) 429–3962 **EXAMPLE 1** CONSULTING ENGINEERS * CONSULTING * CALGARY * ATLANTA * PROTOSTATIX ENGINEERING CONSULTANTS INC. B RASTRUCTURE AND TRANSPORTATION PRELIMINARY THIS DRAWING IS FOR PROGRESS DOCUMENTATION ONLY AND IS NOT FOR CONSTRUCTION PURPOSES KEYPLAN 1 2007/10/31 ISSUED FOR FINAL DESIGN DEVELOPMENT NO DATE DESCRIPTION REVISIONS SEAL / PERMIT PROJECT 900 STUDENT K-9 CORE SCHOOL ALBERTA SHEET TITLE TYPICAL PORTABLE CLASSROOM PLAN Checked Drawn WMH Project No. E07175 Date September 18, 2007 Scale Sheet No. 1:50 M20

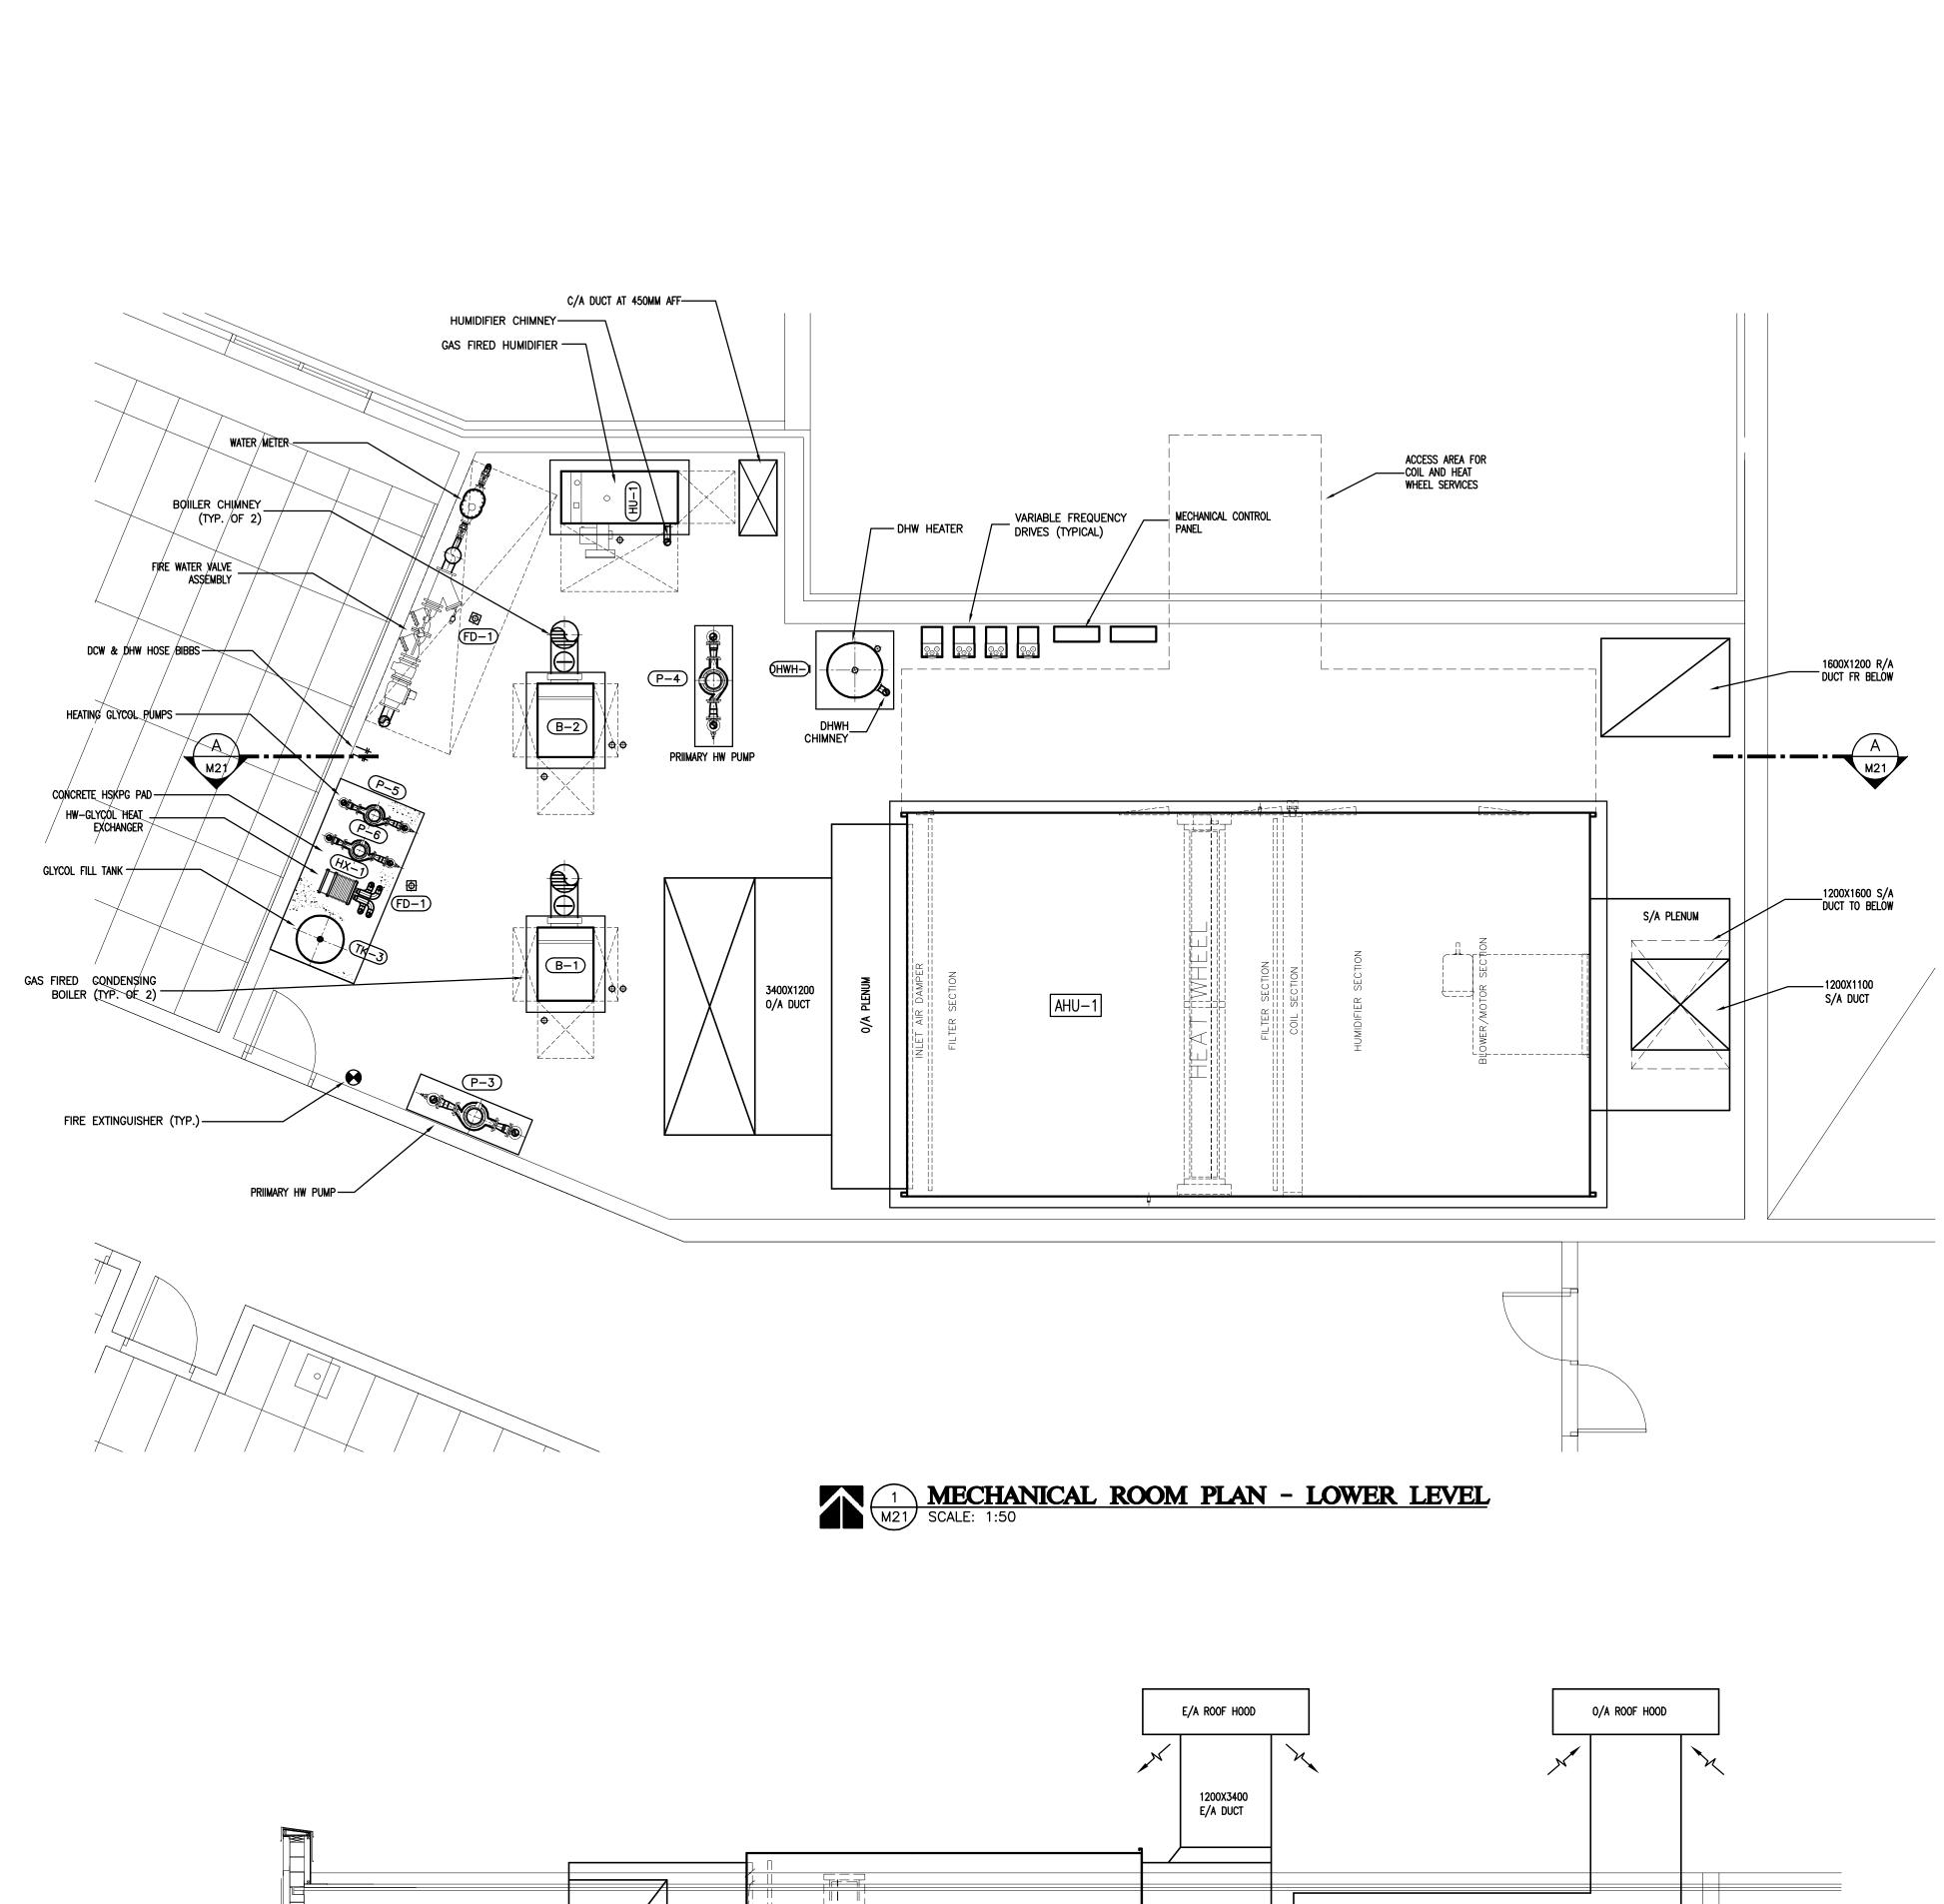

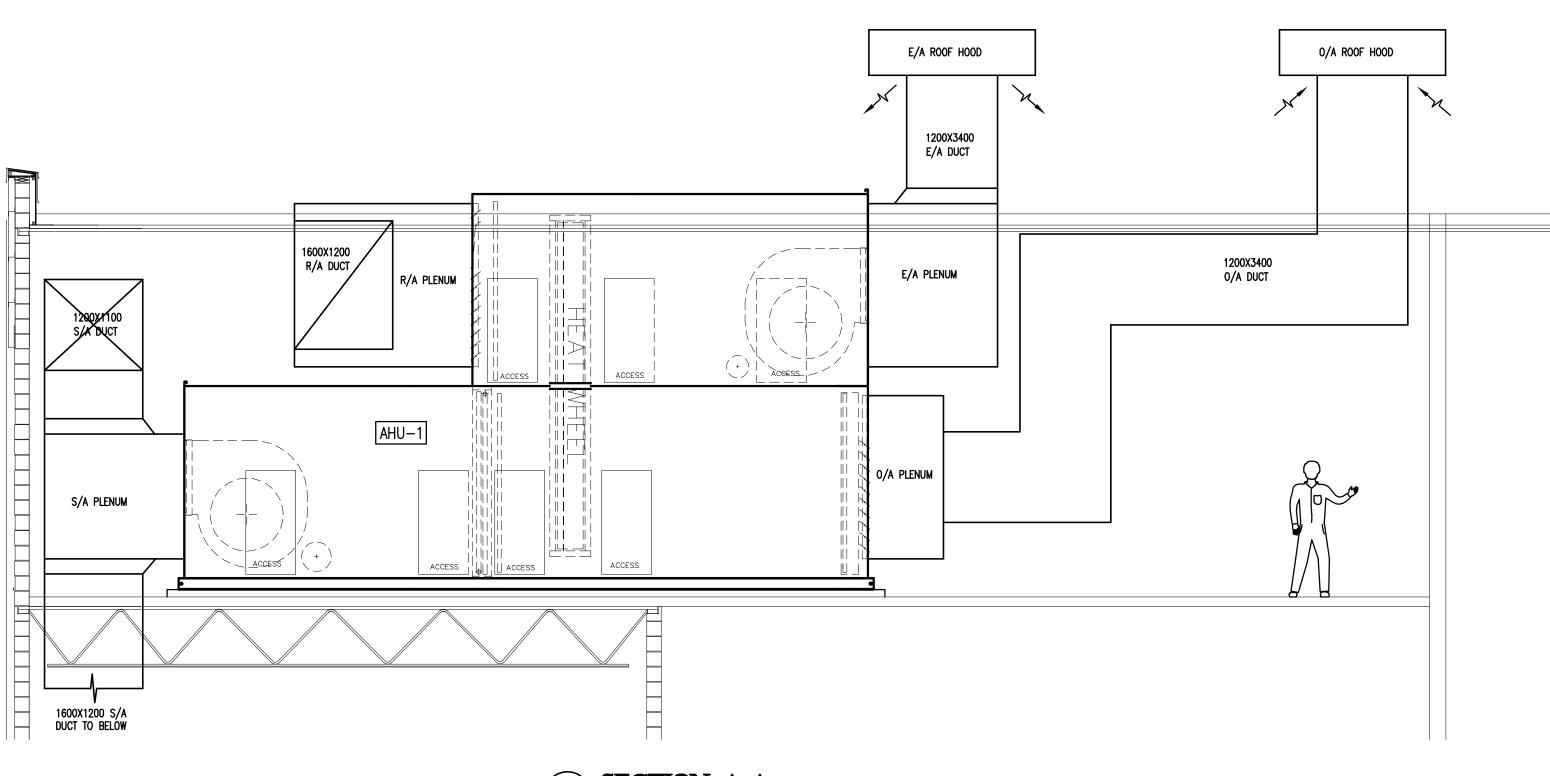



A SECTION A-A M21 SCALE: 1:50

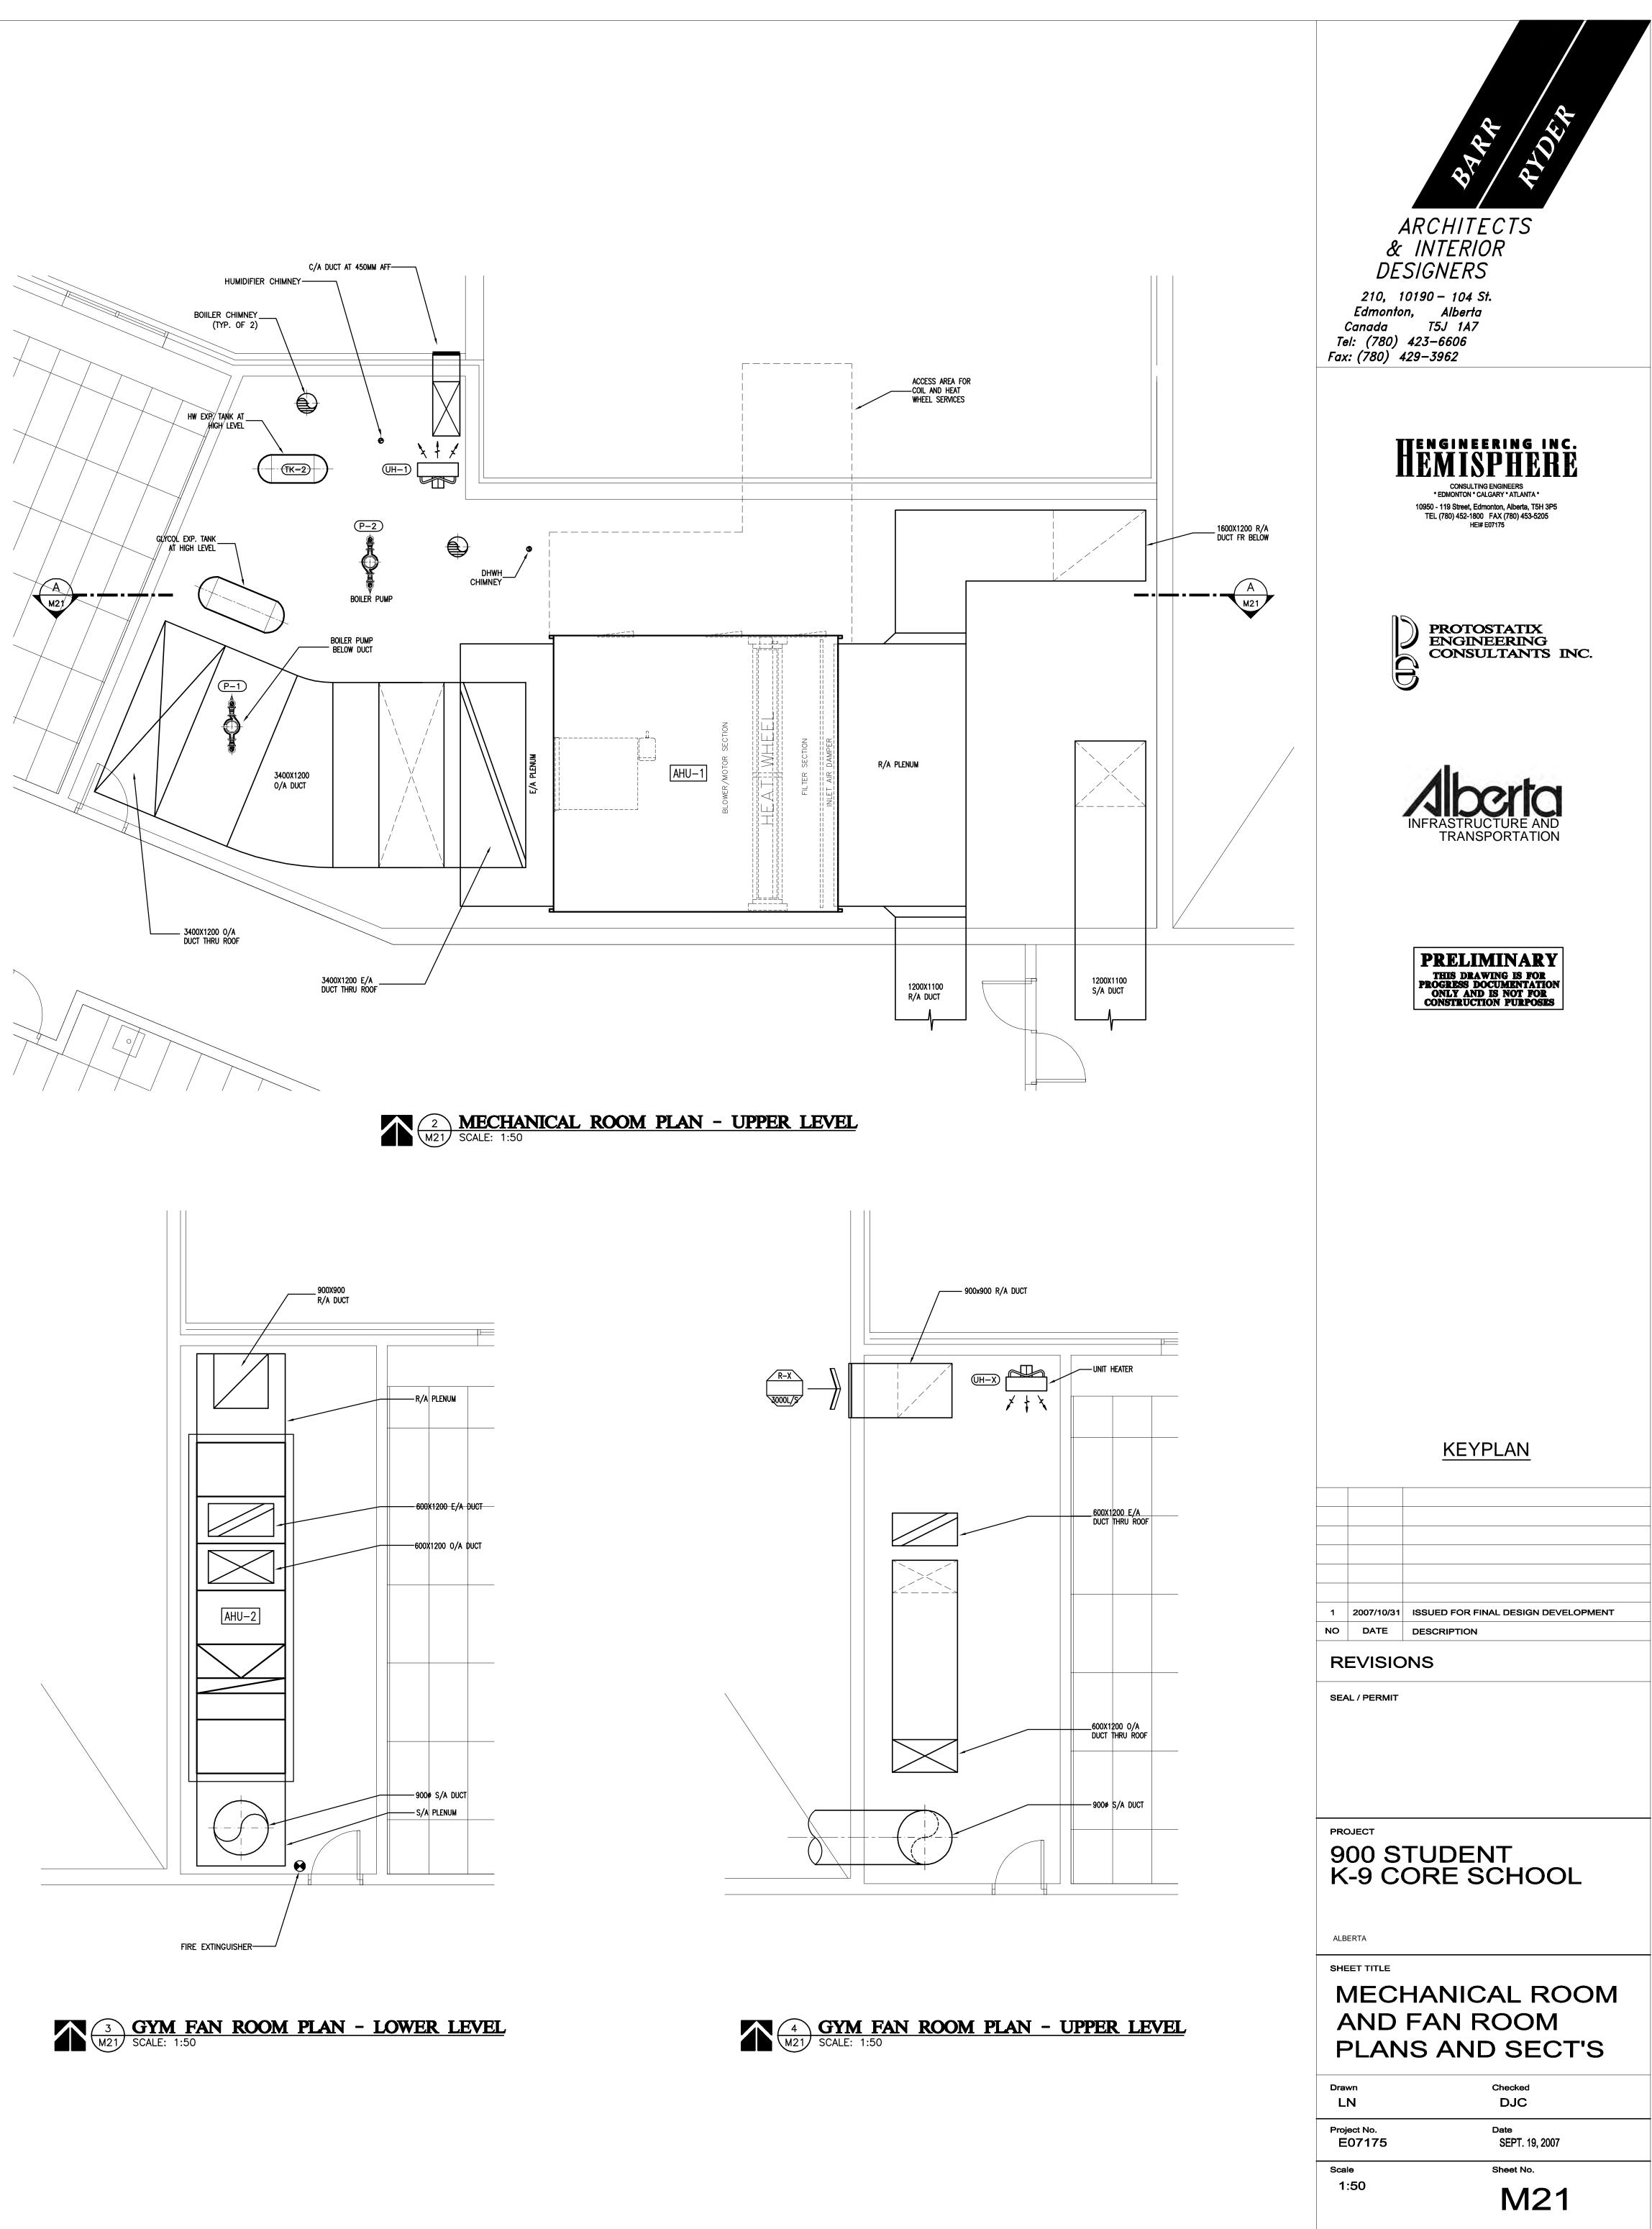

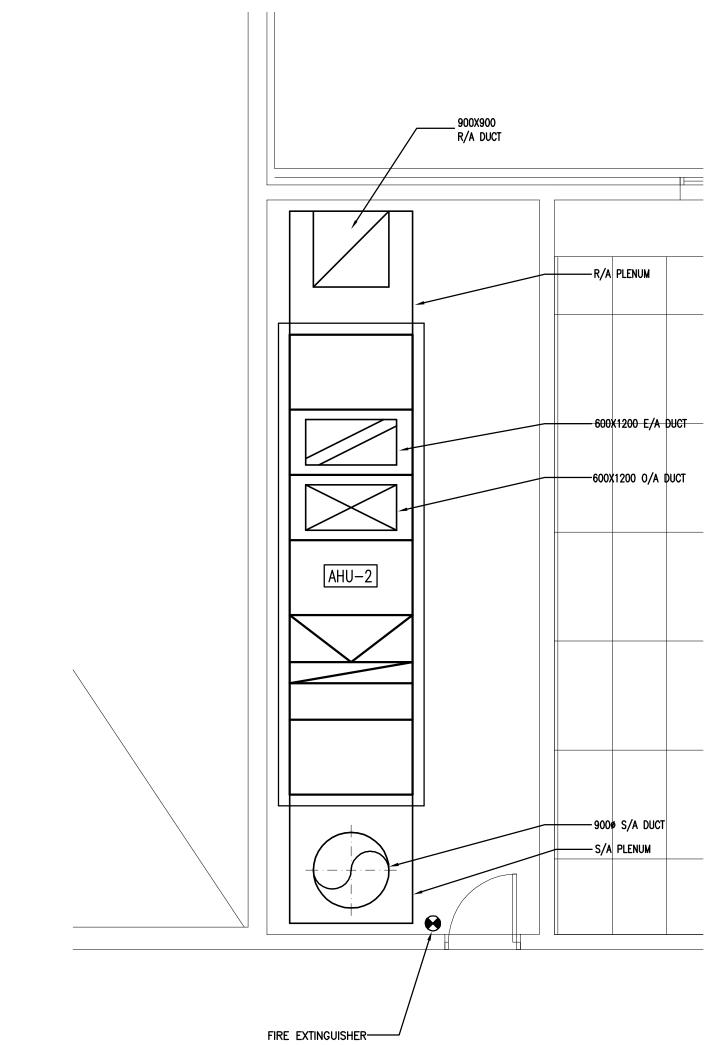




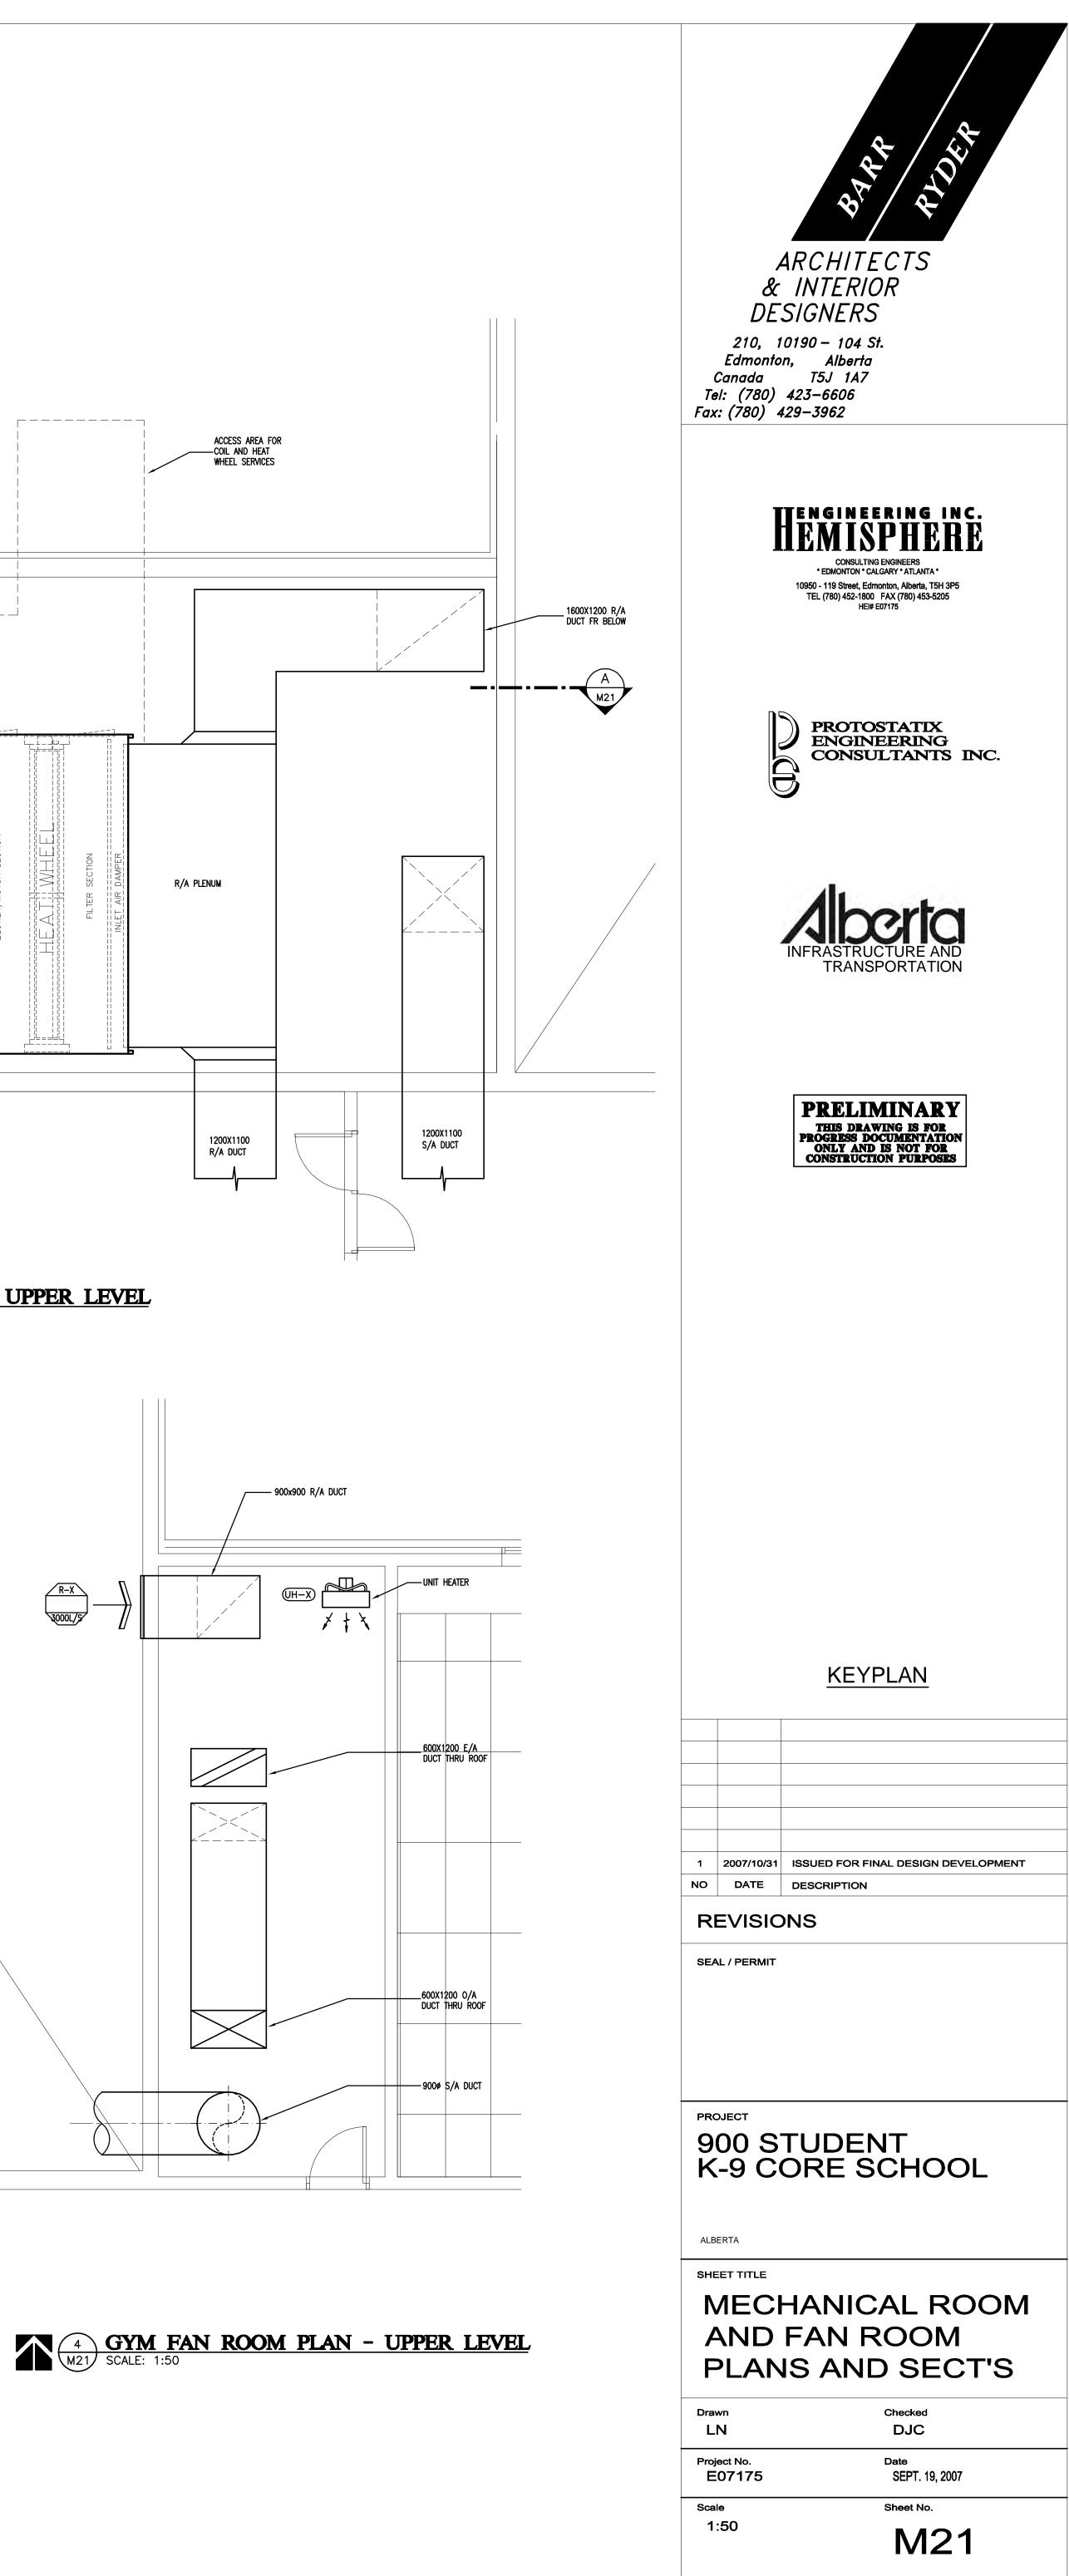

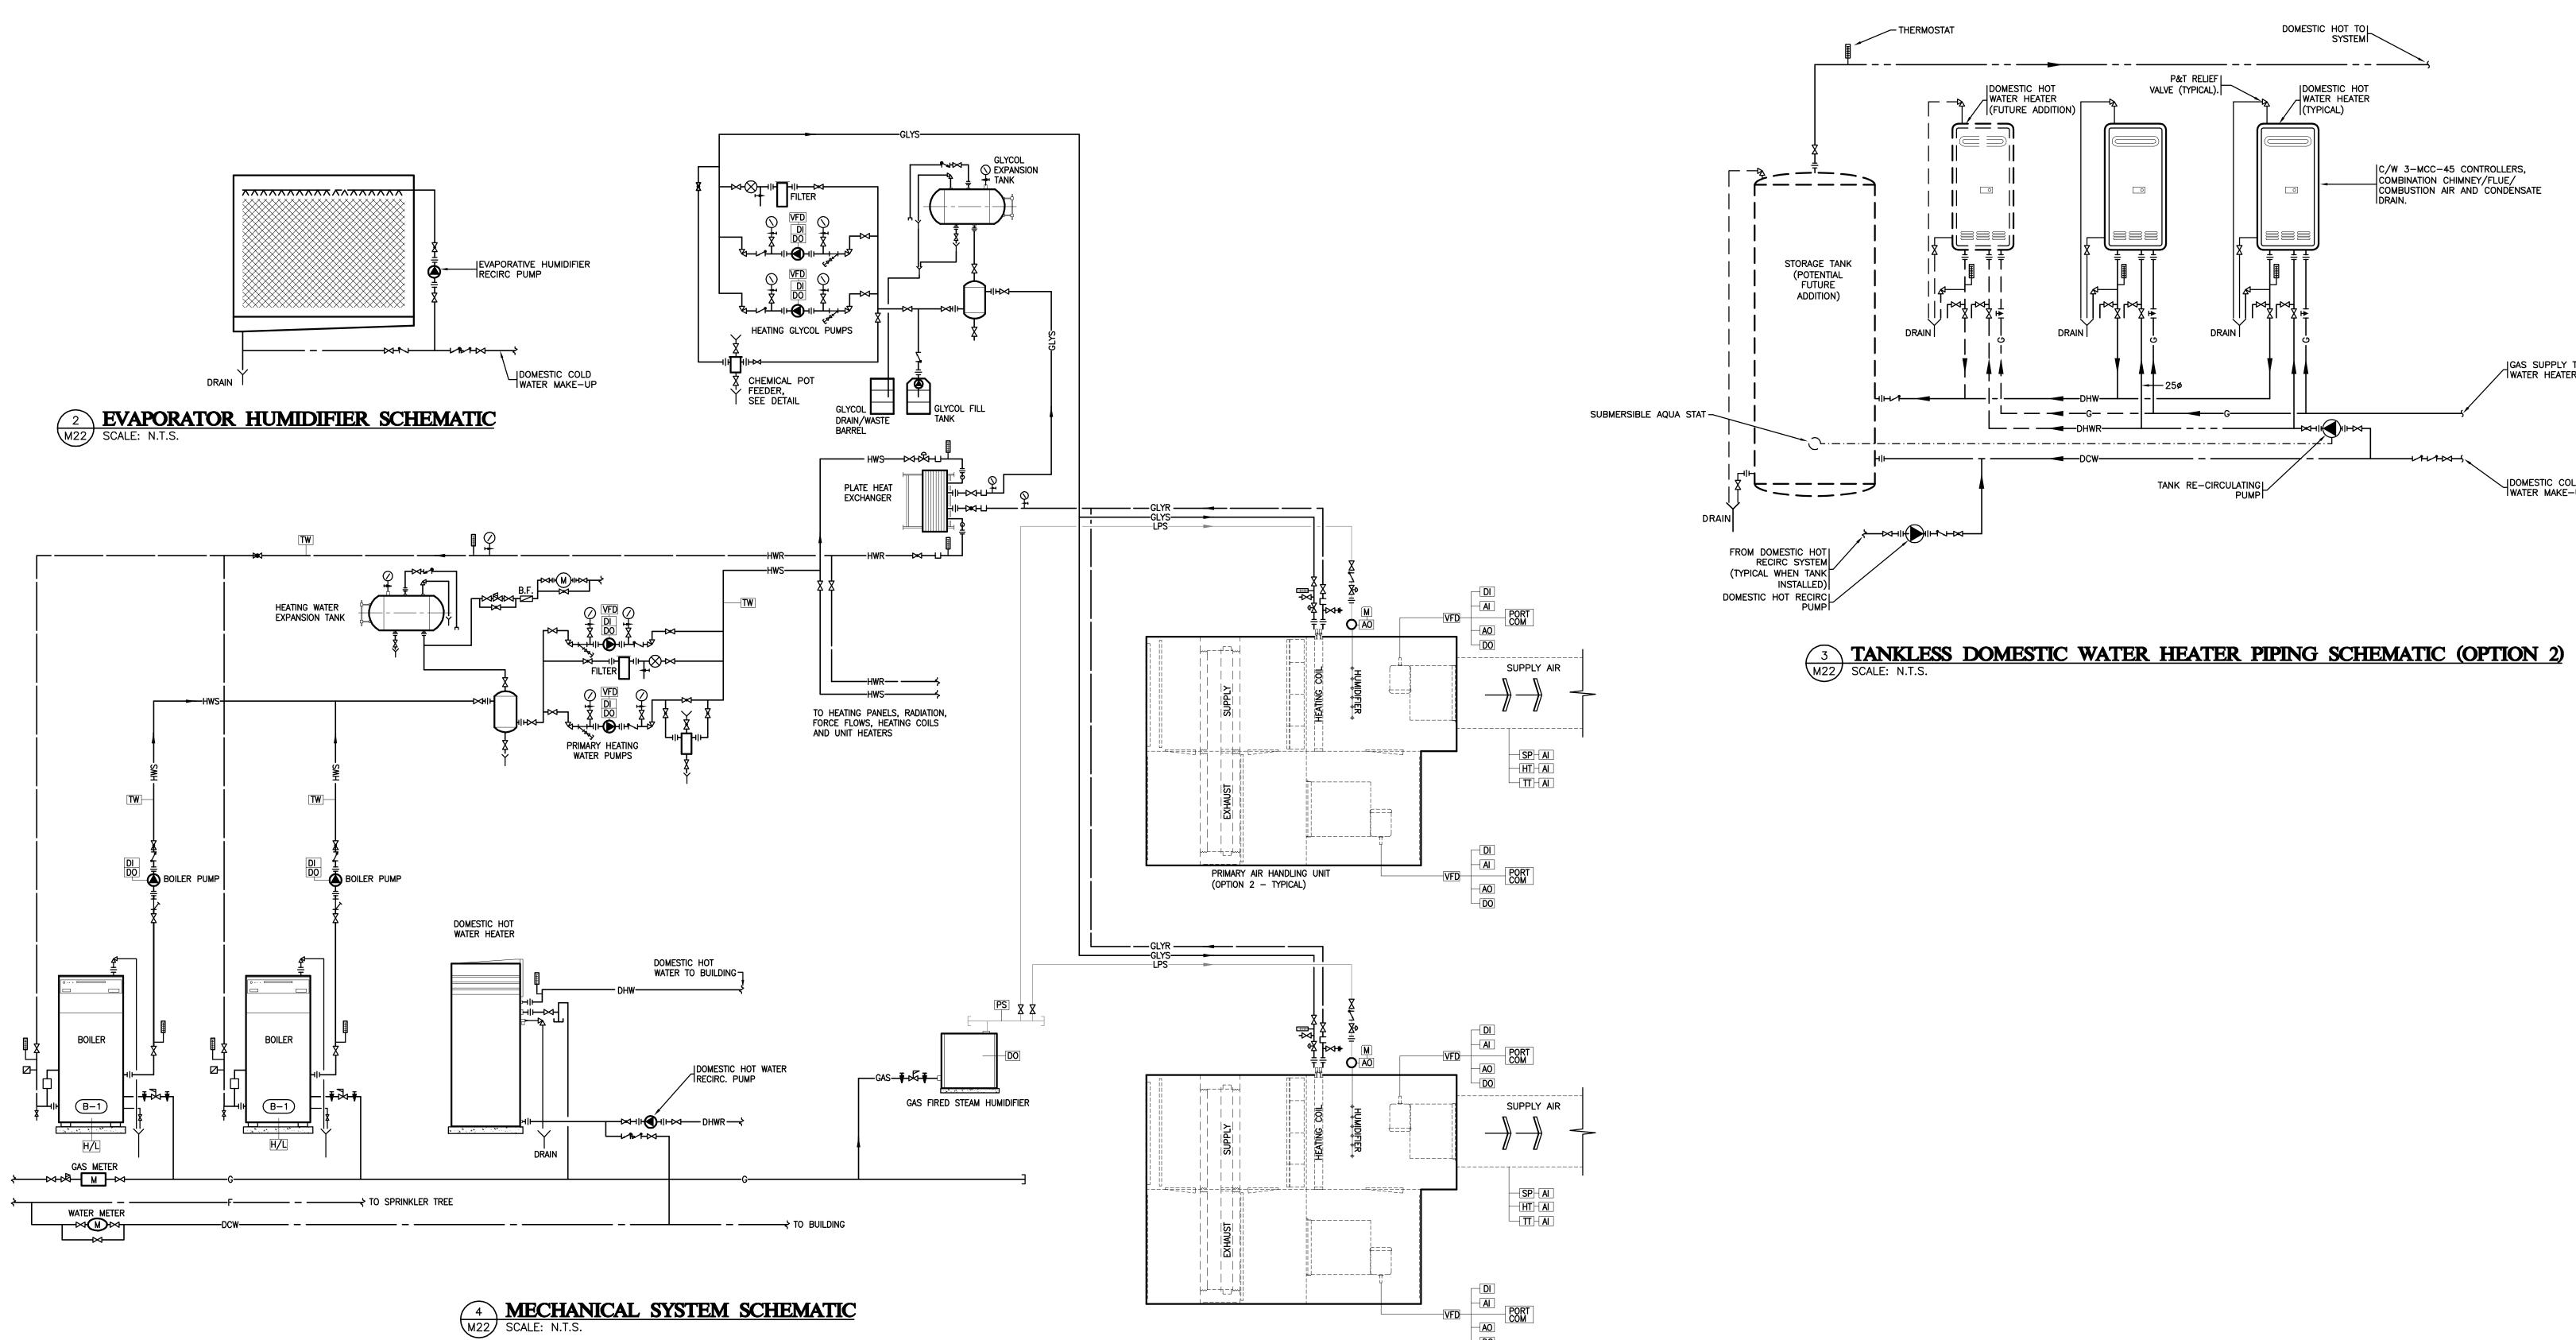


GYM AIR HANDLING UNIT (TYPICAL)




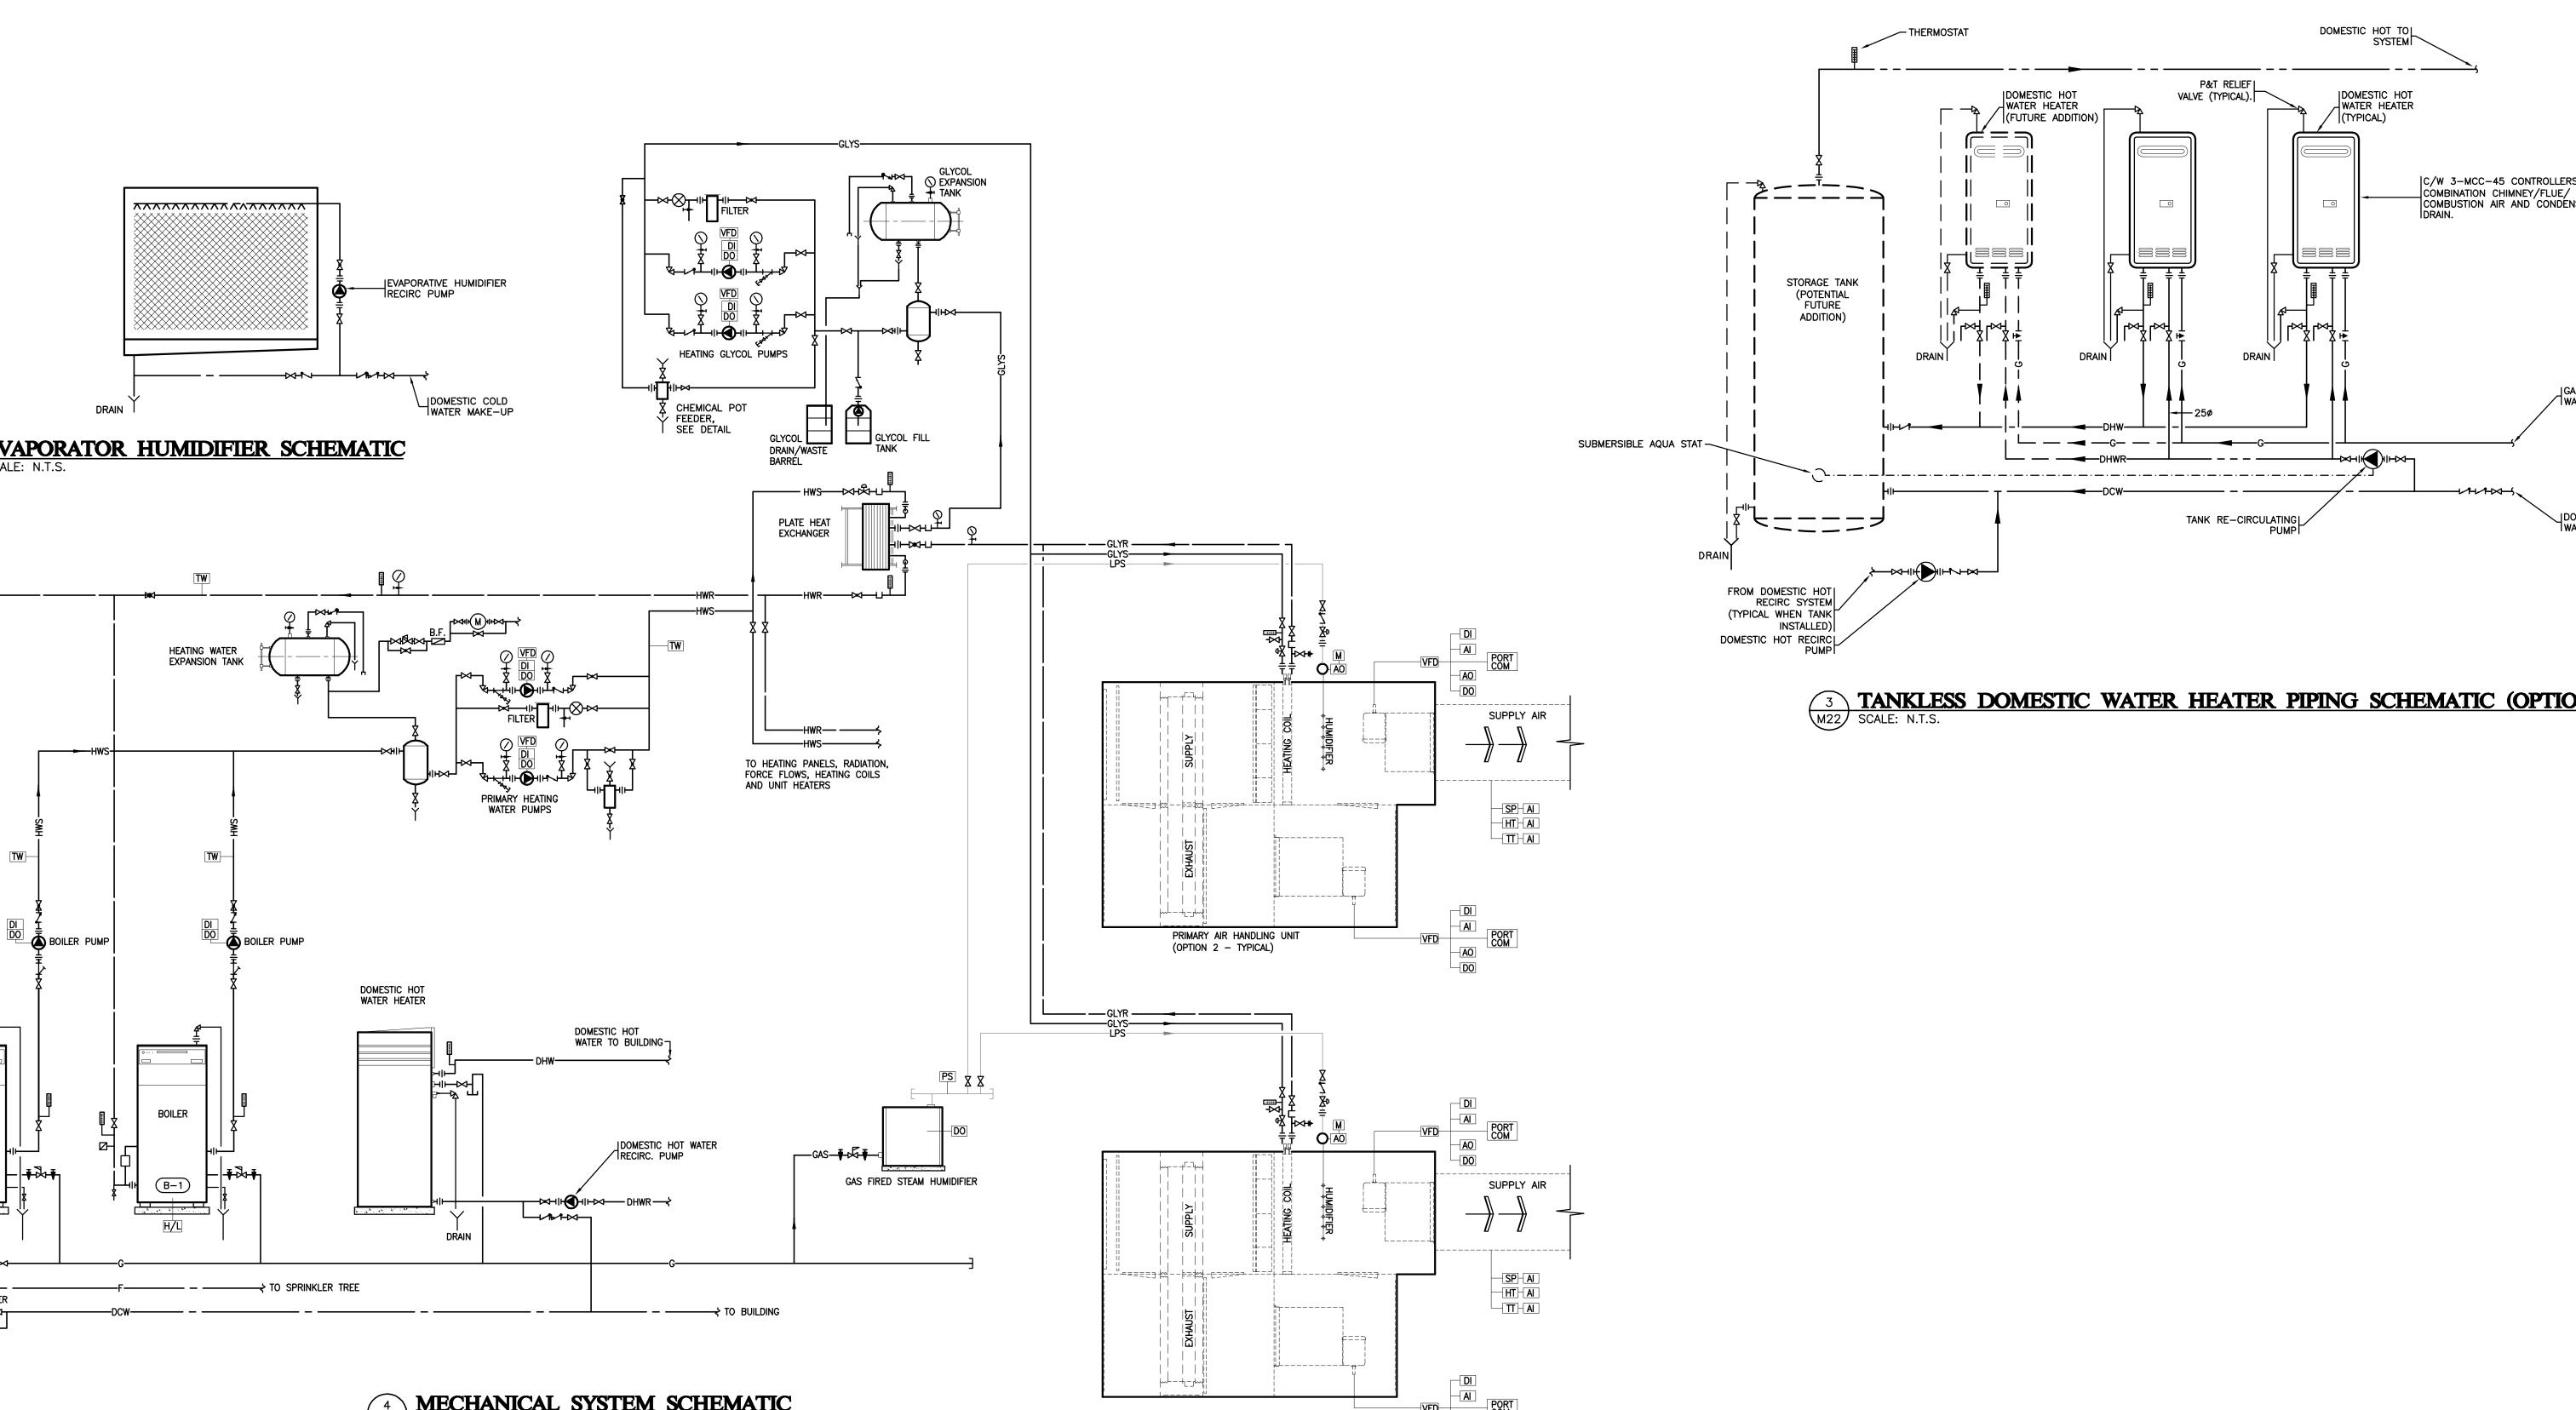


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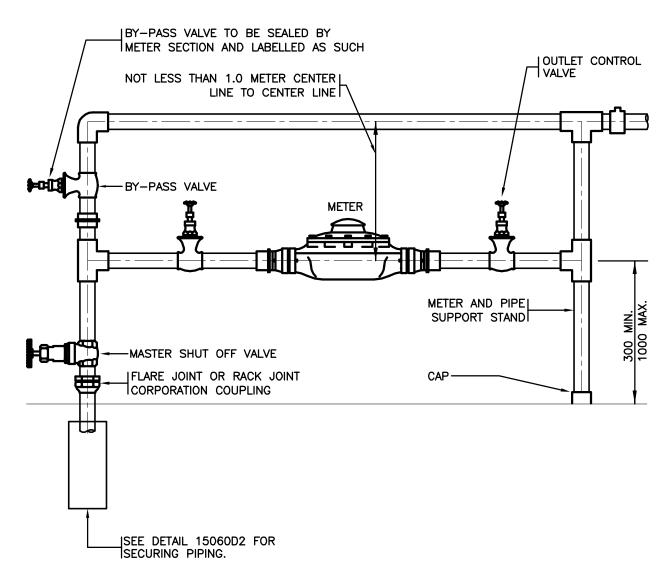


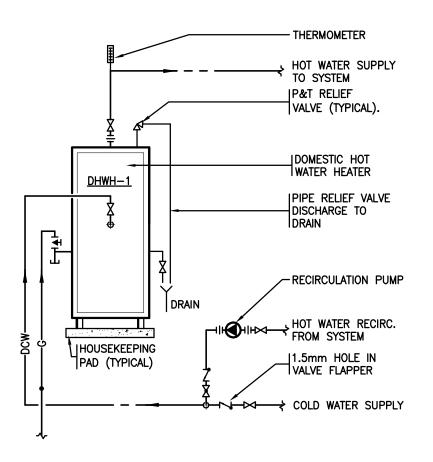1 DOMESTIC WATER HEATER PIPING SCHEMATIC (OPTION 1) M22 SCALE: N.T.S.



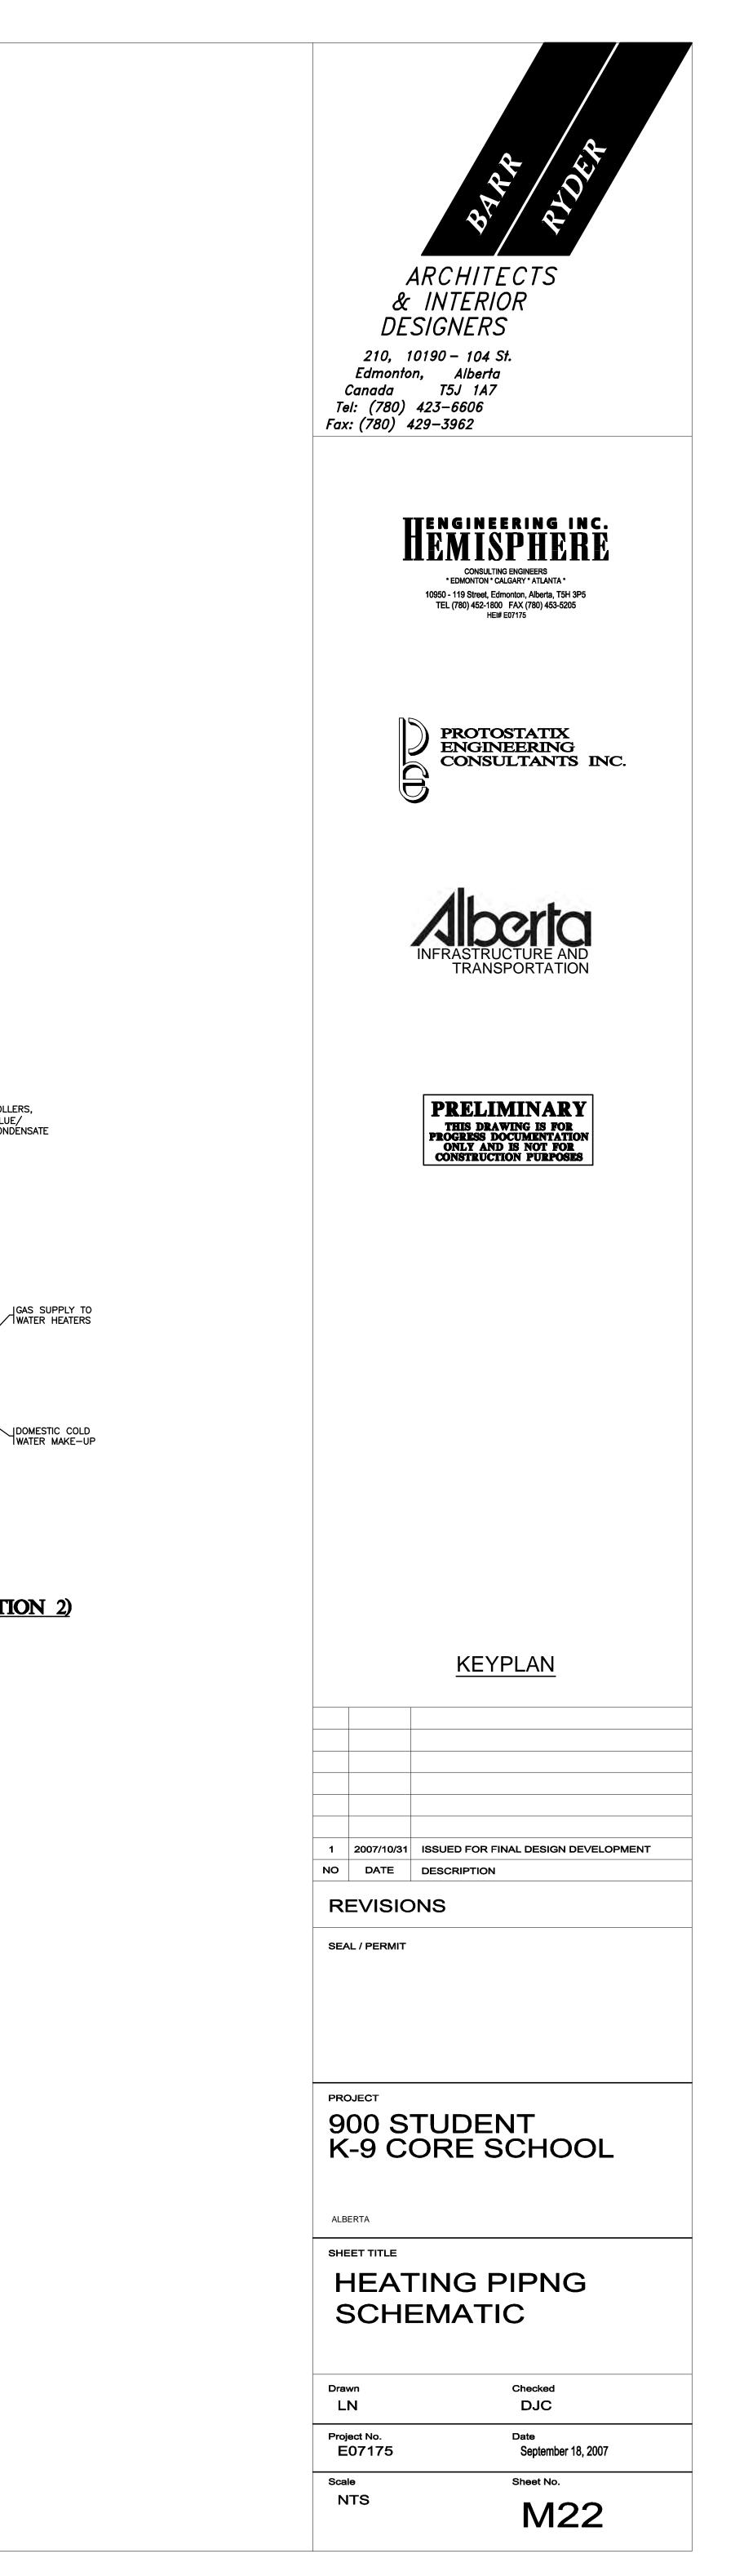
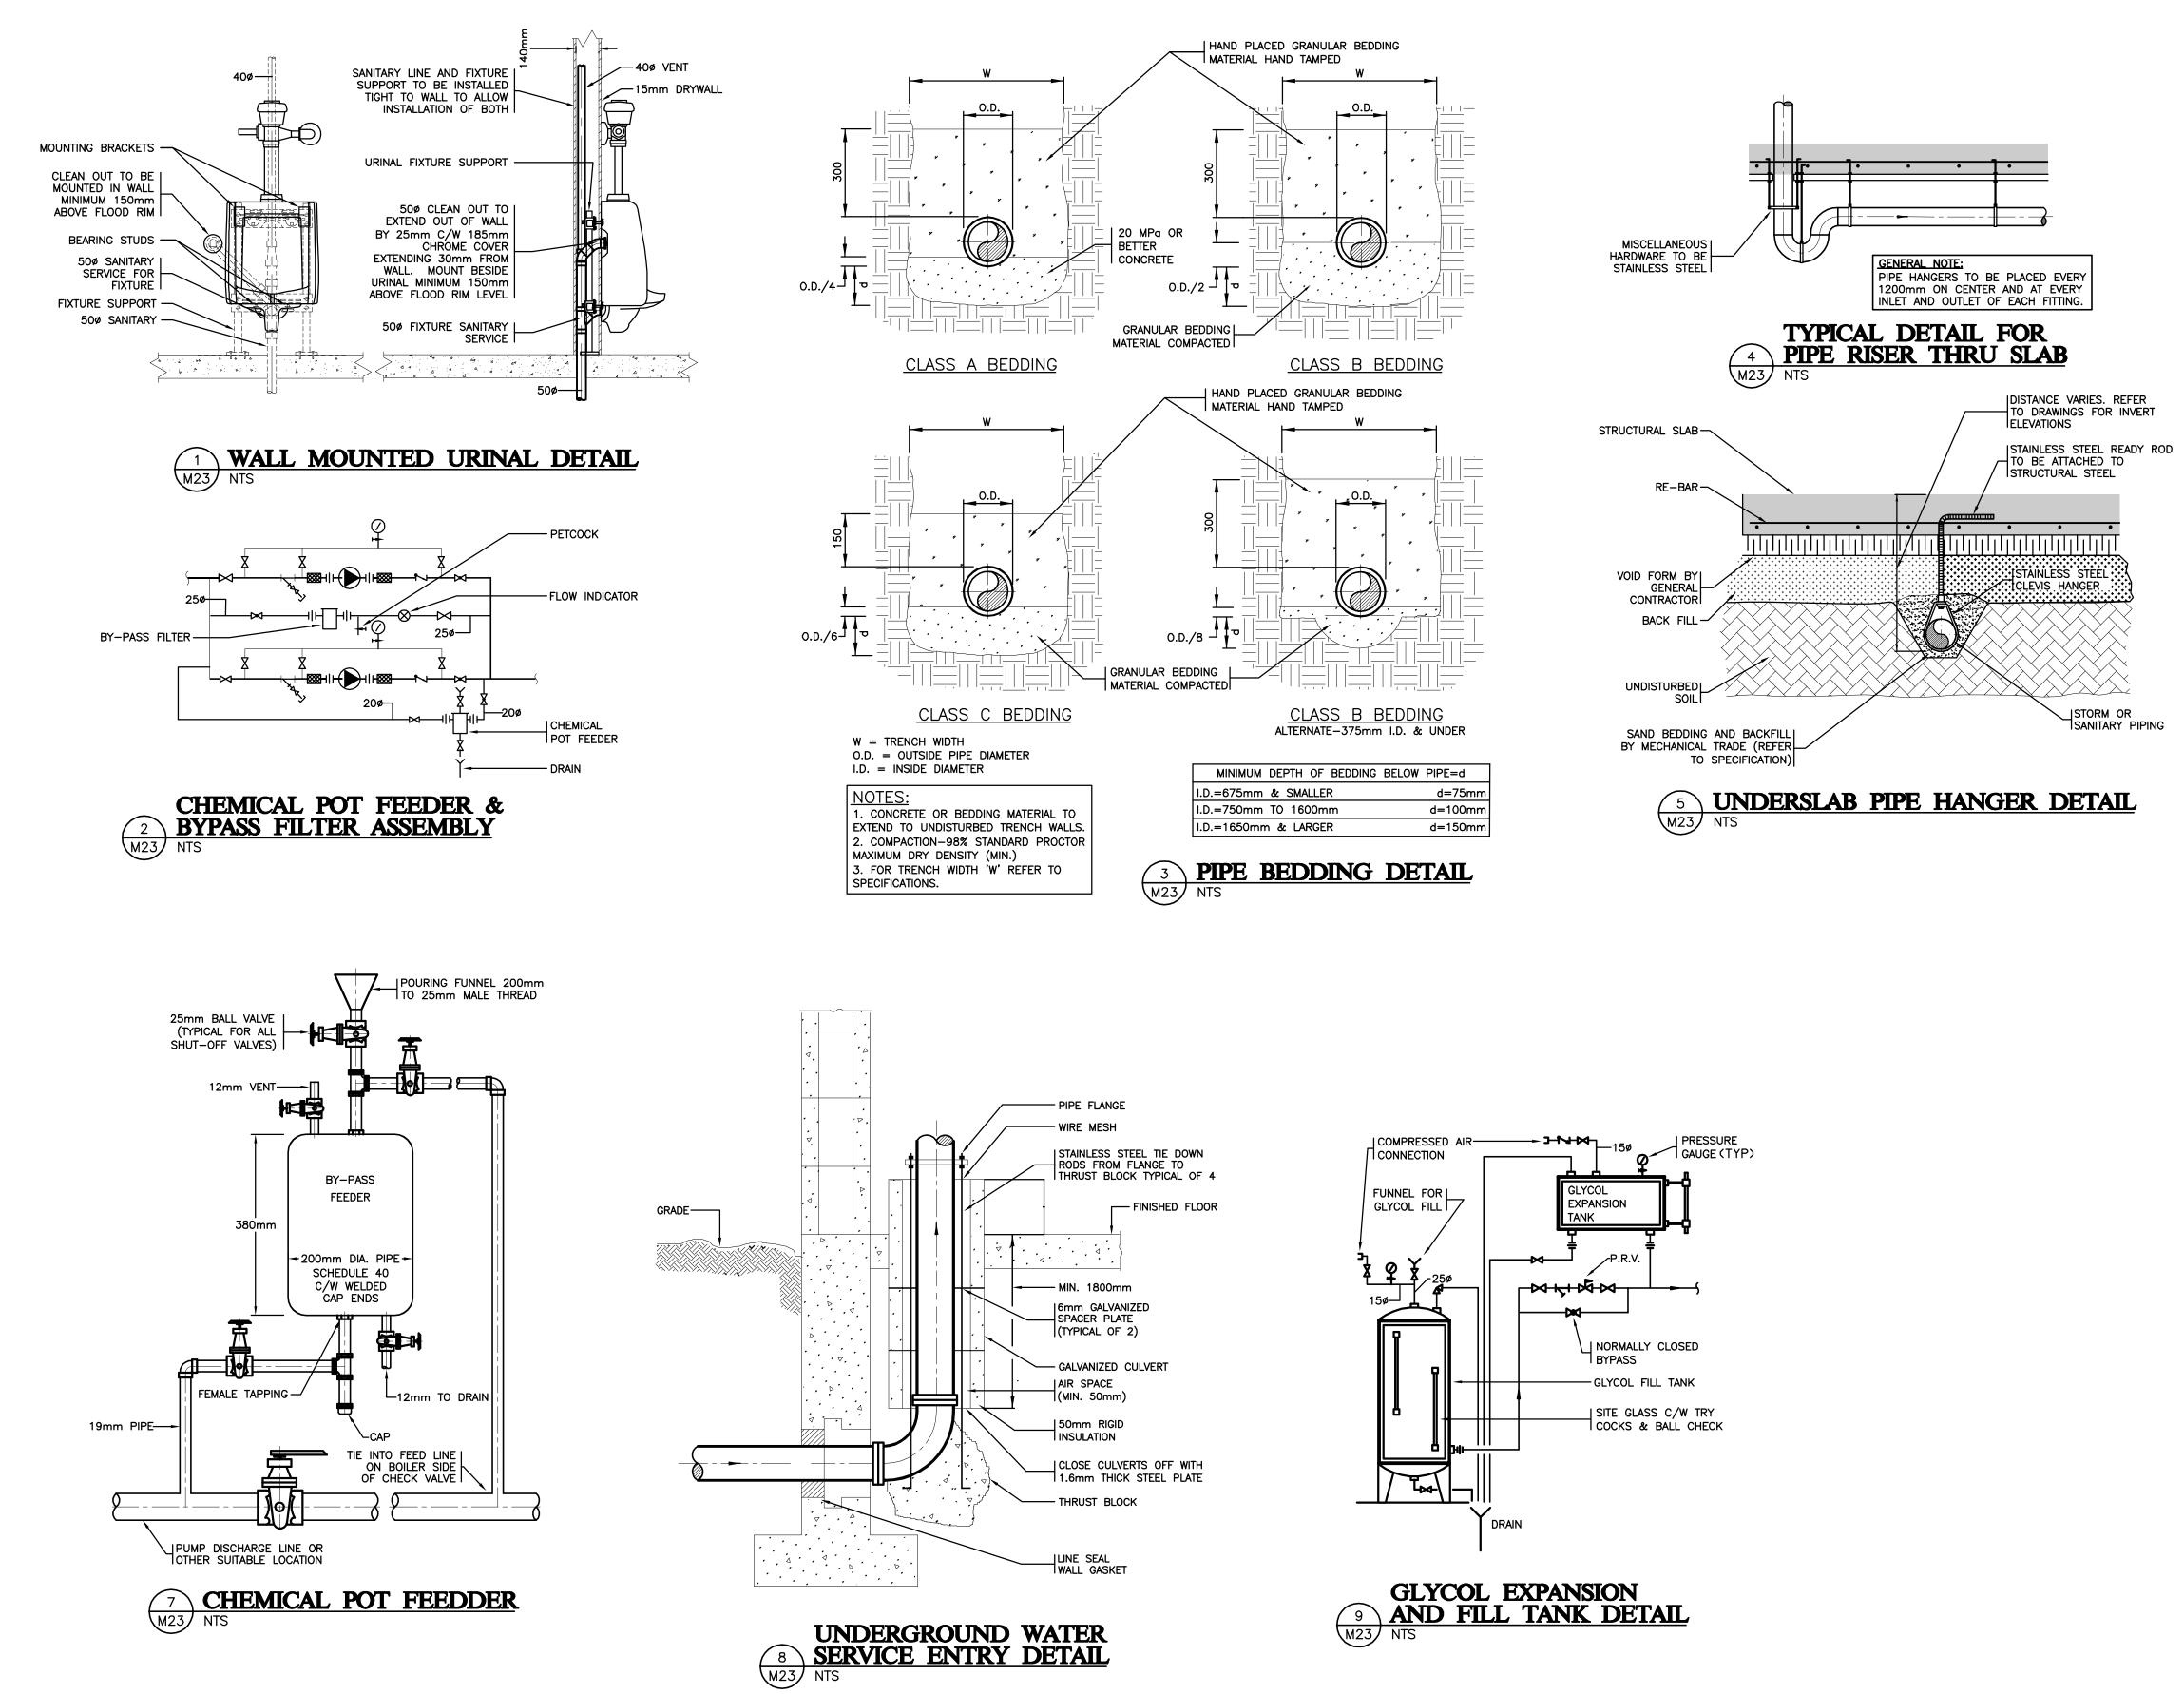
| PIPE SIZE | | MAXIMUM FLOOR AREA REQUIRED | | | | | | |
|-----------|-----|-----------------------------|-------|---------|--------|-------|-------|--|
| INCHES | mm | LENGTH | WIDTH | AREA | LENGTH | WIDTH | AREA | |
| | | ft. | ft. | sq. ft. | m | m | sq. m | |
| 2 | 50 | 5 | 4.5 | 22.5 | 1.5 | 1.4 | 2.1 | |
| 3 | 75 | 7 | 4.5 | 31.5 | 2.1 | 1.4 | 2.9 | |
| 4 | 100 | 7 | 4.5 | 31.5 | 2.1 | 1.4 | 2.9 | |
| 6 | 150 | 8 | 4.5 | 31.5 | 2.4 | 1.4 | 3.4 | |




6 WATER METER DETAIL M23 NTS


ARCHITECTS & INTERIOR DESIGNERS 210, 10190 – 104 St. Edmonton, Alberta Canada T5J 1A7 Tel: (780) 423–6606 Fax: (780) 429–3962 HEMISPHERE CONSULTING ENGINEERS * EDMONTON * CALGARY * ATLANTA * 10950 - 119 Street, Edmonton, Alberta, T5H 3P5 TEL (780) 452-1800 FAX (780) 453-5205 HE# E07175 PROTOSTATIX ENGINEERING CONSULTANTS INC. G TRANSPORTATION PRELIMINARY THIS DRAWING IS FOR PROGRESS DOCUMENTATION ONLY AND IS NOT FOR CONSTRUCTION PURPOSES KEYPLAN 1 2007/10/31 ISSUED FOR FINAL DESIGN DEVELOPMENT NO DATE DESCRIPTION REVISIONS SEAL / PERMIT PROJECT 900 STUDENT K-9 CORE SCHOOL ALBERTA SHEET TITLE DETAILS Checked DJC Drawn LN Project No. E07175 Date September 18, 2007 Scale Sheet No. NTS M23




| SYMBOL SCHEDULE | | | | |
|--|--|--|--|--|
| LIGHTING | | | | |
| RECESSED 1'x4' FLOURESCENT LUMINAIRE | | | | |
| RECESSED 2'x4' FLOURESCENT LUMINAIRE | | | | |
| RECESSED 2'x2' FLOURESCENT LUMINAIRE | | | | |
| SURFACE MOUNTED 2'x4' FLOURESCENT LUMINAIRE | | | | |
| SURFACE MOUNTED 1'x4' FLOURESCENT LUMINAIRE | | | | |
| SURFACE MOUNTED STRIP LIGHT | | | | |
| SURFACE MOUNTED INCANDESCENT LUMINAIRE | | | | |
| RECESSED INCANDESCENT DOWNLIGHT | | | | |
| RECESSED COMPACT FLUORESCENT DOWNLIGHT | | | | |
| WALL MOUNTED HID LUMINAIRE | | | | |
| WALL MOUNTED COMPACT FLUORESCENT | | | | |
| LINE VOLTAGE WALL SWITCH ('VC' = VOLUME CONTROL) | | | | |
| INDICATES LUMINAIRE TYPE 'XX' | | | | |
| OCCUPANCY SENSOR SWITCH | | | | |
| POWER | | | | |
| CEILING MOUNTED JUNCTION BOX | | | | |
| SURFACE MOUNTED PANELBOARD | | | | |
| WALL MOUNTED DUPLEX RECEPTACLE ('WP' = WEATHERPROOF) | | | | |
| WALL MOUNTED FOURPLEX RECEPTACLE | | | | |
| WALL MOUNTED G.F.I. DUPLEX RECEPTACLE | | | | |
| ELECTRIC MOTOR | | | | |
| ELECTRICAL DISCONNECT SWITCH | | | | |
| WALL MOUNTED PUSH BUTTON | | | | |
| FIRE ALARM | | | | |
| FIRE ALARM CONTROL PANEL | | | | |
| WALL MOUNTED EXIT LIGHT | | | | |
| EMERGENCY LIGHT BATTERY PACK WITH DUAL HEAD | | | | |
| EMERGENCY LIGHT DOUBLE REMOTE HEAD | | | | |
| FIRE ALARM PULL STATION | | | | |
| FIRE ALARM HORN/STROBE | | | | |
| FIRE ALARM SMOKE DETECTOR | | | | |
| SYSTEMS | | | | |
| CEILING MOUNTED SPEAKER | | | | |
| RECESSED CEILING MOUNTED SPEAKER | | | | |
| WALL MOUNTED MICROPHONE OUTLET | | | | |
| WALL MOUNTED SPEAKER HORN | | | | |
| COMPUTER OUTLET | | | | |
| TELEPHONE OUTLET | | | | |
| DATA/VOICE OUTLET (1 DATA, 1 VOICE) | | | | |
| SECURITY | | | | |
| SECURITY DOOR CONTACT | | | | |
| SECURITY KEYPAD | | | | |
| | | | | |
| | | | | |

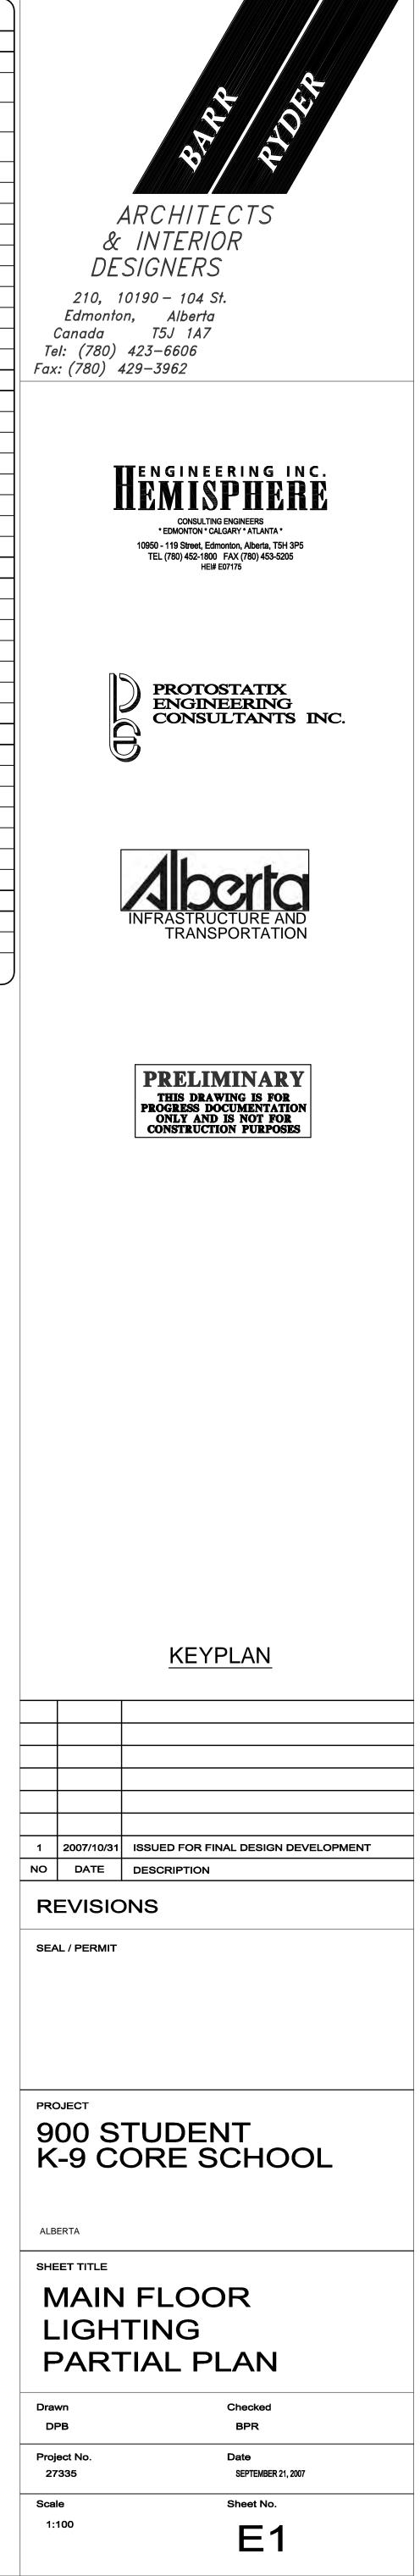





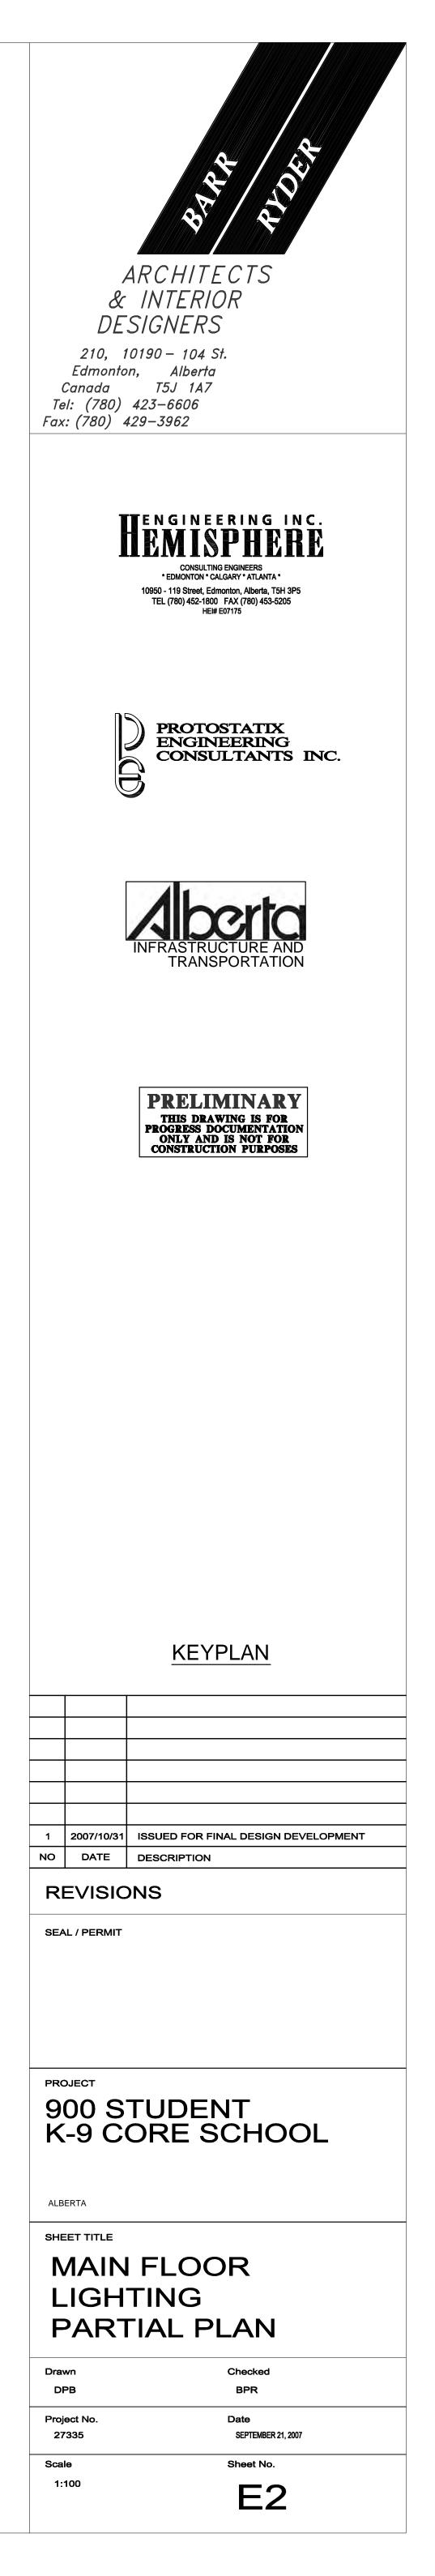



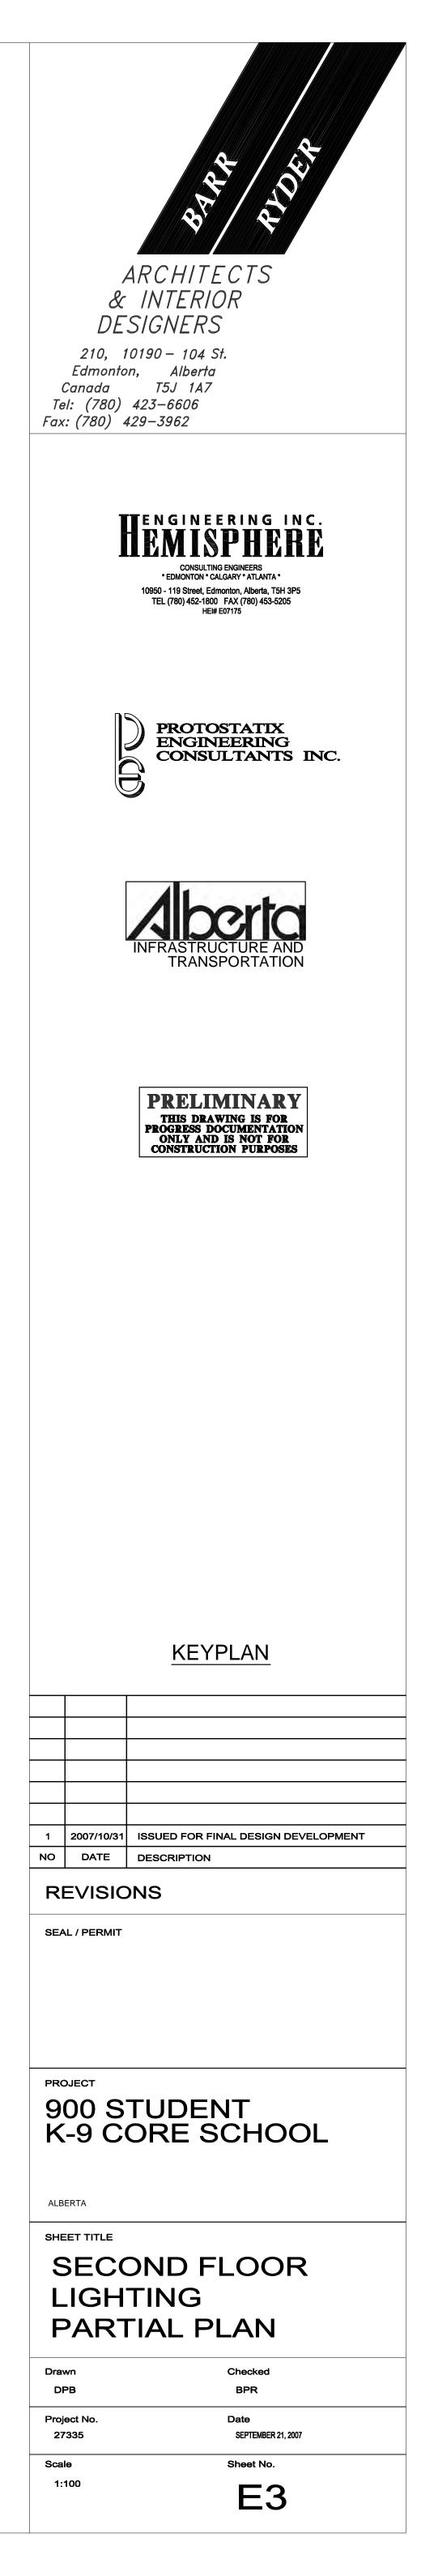

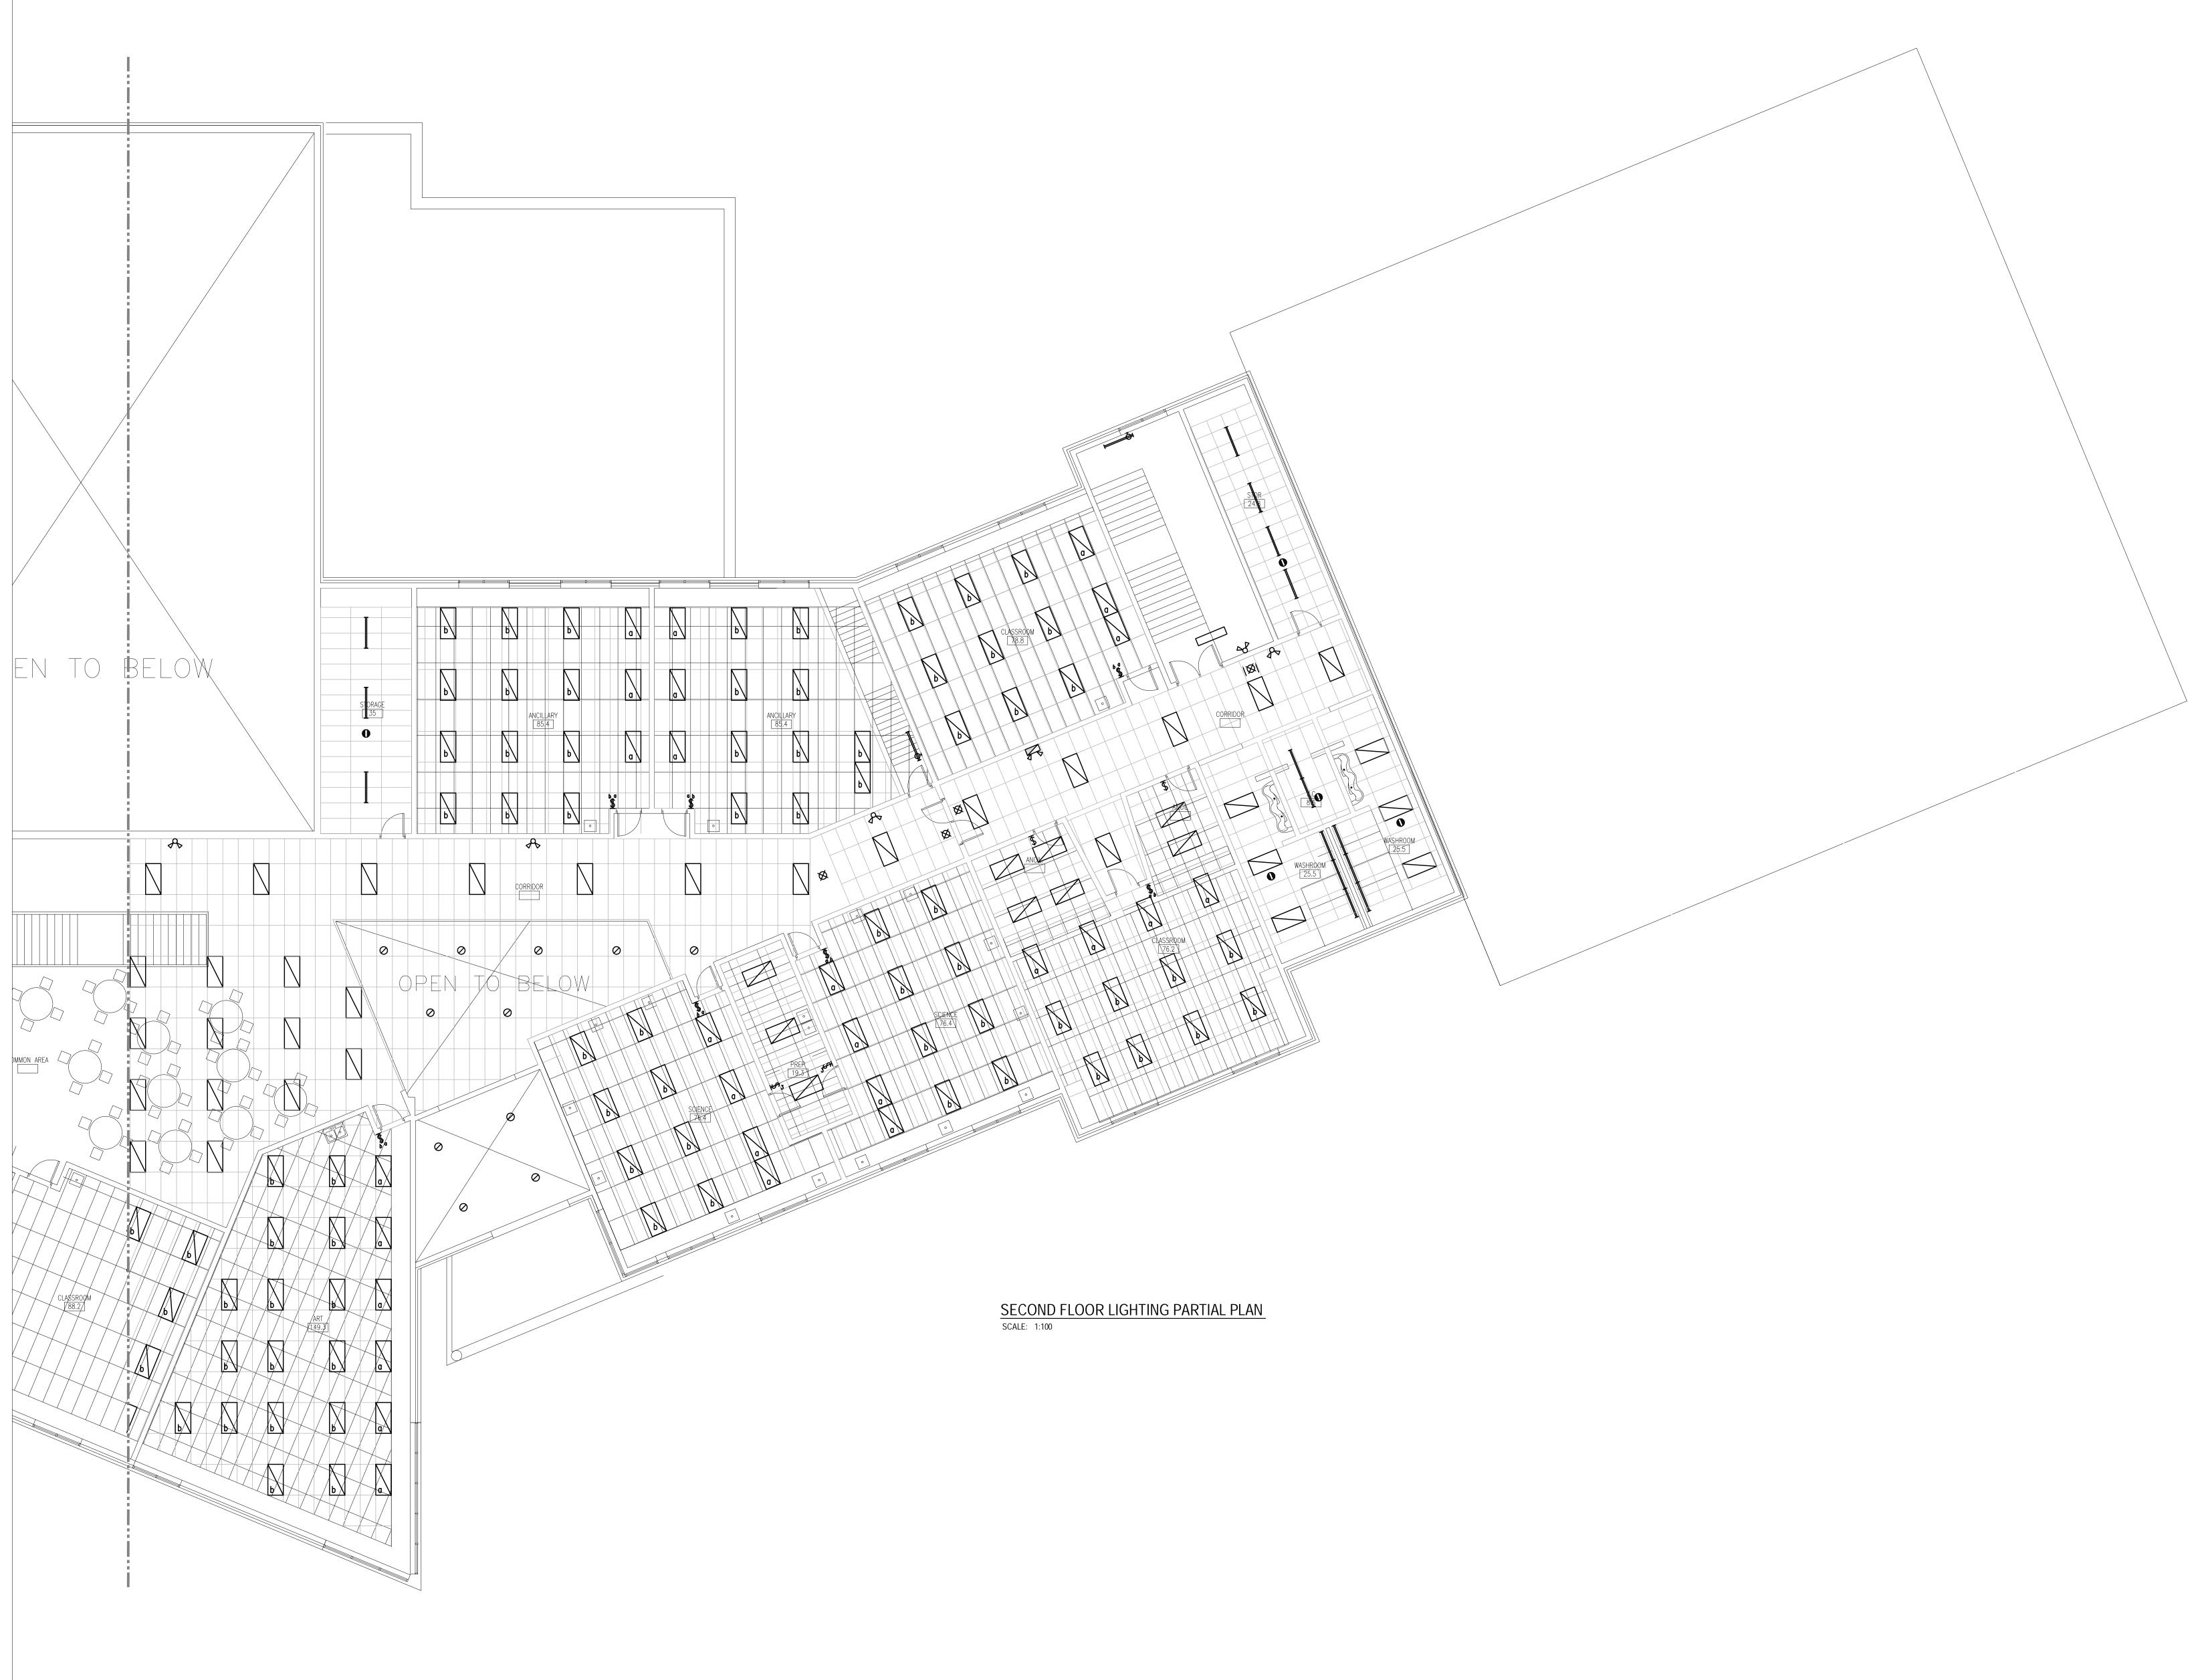

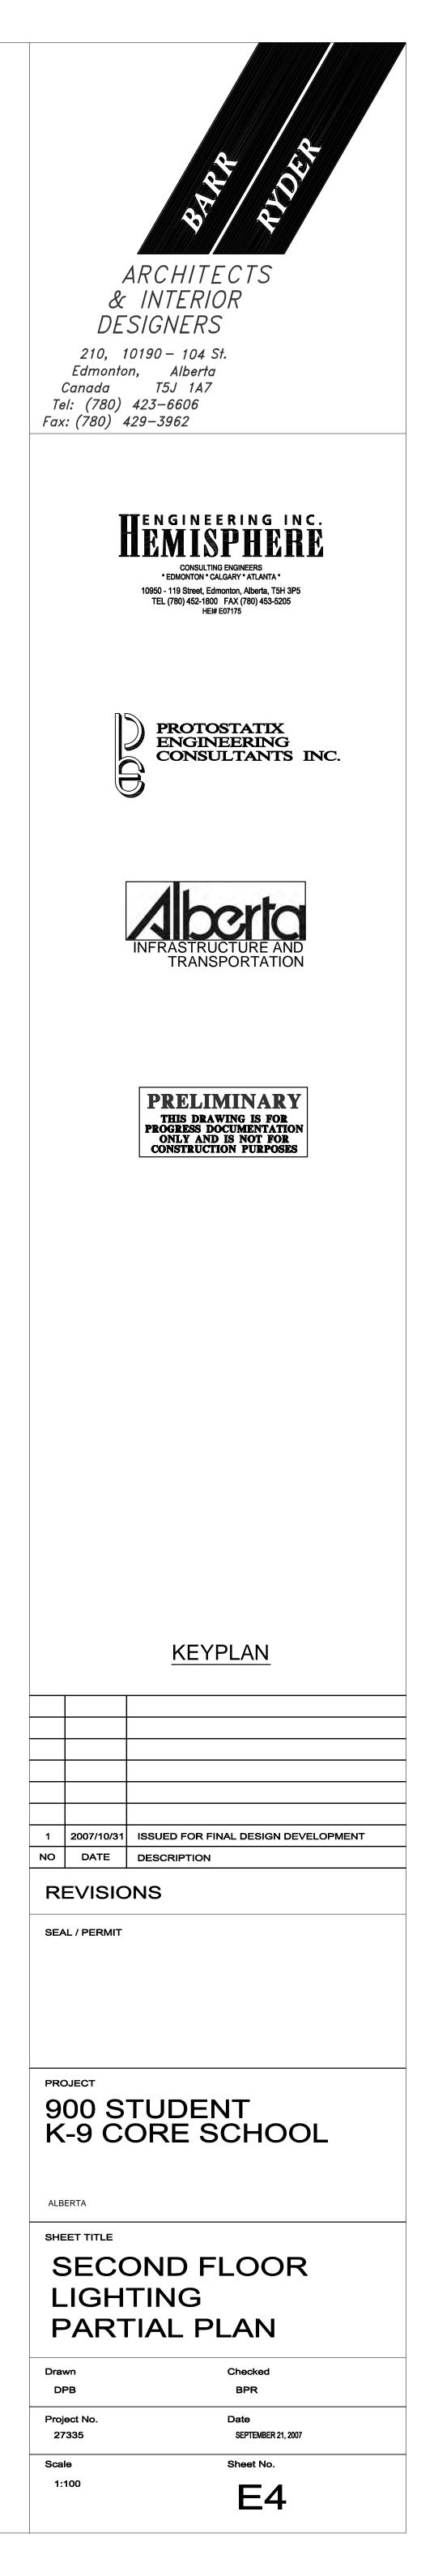





| OVERHEAD PROJECTOR DATA AND POWER CONNECTION. COORDINATE AND CONFIRM EXACT LOCATION OF PROJECTOR WITH GENERAL CONTRACTOR PRIOR TO ROUGH-IN. LADDER TYPE CABLE TRAY ACCESSIBLE FROM CEILING SPACE. JUNCTION BOX FOR POWER CONNECTION TO MODULAR CLASSROOMS. MOTORIZED BACKBOARDS. CONTROLLERS: UP, DOWN AND STOP FOR MOTORIZED BACKBOARDS. CONTROLLERS: UP, DOWN AND STOP FOR MOTORIZED BACKBOARDS. JUNCTION BOX FOR CONTROL OF SCOREBOARD. JUNCTION BOX FOR CONTROL OF SHOT CLOCK MOUNTED AT 2400mm AFF. JUNCTION BOX FOR POWER TO SHOT CLOCK. JUNCTION BOX FOR POWER TO SHOT CLOCK. JUNCTION BOX FOR POWER TO SCOREBOARD MOUNTED AT 3300mm AFF. JUNCTION BOX FOR POWER TO SCOREBOARD MOUNTED AT 3300mm AFF. JUNCTION BOX FOR POWER TO SCOREBOARD MOUNTED AT 3300mm AFF. JUNCTION BOX FOR POWER TO SCOREBOARD MOUNTED AT 3300mm AFF. JUNCTION BOX FOR POWER TO SCOREBOARD MOUNTED AT 3300mm AFF. JUNCTION BOX FOR POWER TO SCOREBOARD MOUNTED AT 3300mm AFF. JUNCTION BOX FOR POWER TO SCOREBOARD MOUNTED AT 3300mm AFF. RUN 21mmC TO AMPLIFIER IN PHYS-ED OFFICE. TWISTLOCK RECEPTACLES FOR FORESTAGE LIGHTING - REFER TO DETAIL. RUN TO SUB DISTRIBUTION PANEL 'A'. | ARCHITECTS & INTERIOR DESIGNERS 210, 10190 - 104 St. Edmonton, Alberta Canada T5J 1A7 Tel: (780) 423-6606 Fax: (780) 429-3962 |
|--|---|
| (14) RUN TO SUB DISTRIBUTION PANEL 'B'. (15) BRANCH CIRCUIT PANEL. (16) MAIN DISTRIBUTION CENTRE. (17) JUNCTION BOX FOR DOOR SENTRONICS. TIE INTO FIRE ALARM SYSTEM. | THE NGINEERING INC. CONSULTING ENGINEERS * EDMONTON * CALGARY * ATLANTA * 10950 - 119 Street, Edmonton, Alberta, T5H 3P5 THE STREET, Edmonton, Alberta, T5H 3P5 THE STREET, Edmonton, Alberta, T5H 3P5 |
| | TEL (780) 452-1800 FAX (780) 453-5205 HEI# E07175 PROTOSTATIX ENGINEERING CONSULTANTS INC. |
| | INFRASTRUCTURE AND TRANSPORTATION |
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| | <u>KEYPLAN</u> |
| | 1 2007/10/31 ISSUED FOR FINAL DESIGN DEVELOPMENT |
| | 1 2007/10/31 ISSUED FOR FINAL DESIGN DEVELOPMENT NO DATE DESCRIPTION REVISIONS SEAL / PERMIT |
| | PROJECT 900 STUDENT K-9 CORE SCHOOL |
| | ALBERTA SHEET TITLE MAIN FLOOR POWER & SYSTEMS PARTIAL PLAN |
| - | Drawn Checked DPB BPR |
| | Project No. Date 27335 SEPTEMBER 21, 2007 Scale Sheet No. 1:1000 E5 |




| KEY NOTES: (1) OVERHEAD PROJECTOR DATA AND POWER CONNECTION. COORDINATE AND CONFIRM EXACT LOCATION OF PROJECTOR WITH GENERAL CONTRACTOR PRIOR TO ROUGH-IN. (2) LADDER TYPE CABLE TRAY ACCESSIBLE FROM CEILING SPACE. (3) JUNCTION BOX FOR POWER CONNECTION TO MODULAR CLASSROOMS. (4) MOTORIZED BACKBOARDS. (5) CONTROLLERS: UP, DOWN AND STOP FOR MOTORIZED BACKBOARDS. (6) JUNCTION BOX FOR CONTROL OF SCOREBOARD. (7) JUNCTION BOX FOR CONTROL OF SHOT CLOCK MOUNTED AT 2400mm AFF. (8) JUNCTION BOX FOR CONTROL OF SHOT CLOCK. (9) JUNCTION BOX FOR POWER TO SHOT CLOCK. (9) JUNCTION BOX FOR POWER TO SCOREBOARD MOUNTED AT 3300mm AFF. (10) JUNCTION BOX FOR POWER TO SCOREBOARD MOUNTED AT 3300mm AFF. (11) RUN 21mmC TO AMPLIFIER IN PHYS-ED OFFICE. (12) TWISTLOCK RECEPTACLES FOR FORESTAGE LIGHTING - REFER TO DETAIL. (13) RUN TO SUB DISTRIBUTION PANEL 'A'. (14) RUN TO SUB DISTRIBUTION PANEL 'A'. (15) BRANCH CIRCUIT PANEL. (16) MAIN DISTRIBUTION CENTRE. (17) JUNCTION BOX FOR DOOR SENTRONICS. TIE INTO FIRE ALARM SYSTEM. | ARCHITECTS ARCHITECTS BARCHITECTS BARCHITECTS BARCHITECTS BARCHITECTS BARCHITECTS ARCHIT |
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| | PROTOSTATIX ENGINEERING CONSULTANTS INC. |
| | Aberto INFRASTRUCTURE AND TRANSPORTATION |
| | PRELIMINARY THIS DRAWING IS FOR PROGRESS DOCUMENTATION ONLY AND IS NOT FOR CONSTRUCTION PURPOSES |
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| | <u>KEYPLAN</u> |
| | |
| | 1 2007/10/31 ISSUED FOR FINAL DESIGN DEVELOPMENT NO DATE DESCRIPTION |
| | REVISIONS SEAL / PERMIT |
| | PROJECT 900 STUDENT K-9 CORE SCHOOL |
| | ALBERTA SHEET TITLE MAIN FLOOR POWER & SYSTEMS PARTIAL PLAN |
| | Drawn Checked DPB BPR Project No. Date 27335 SEPTEMBER 21, 2007 |
| | 27335 SEPTEMBER 21, 2007 Scale Sheet No. 1:1000 E6 |



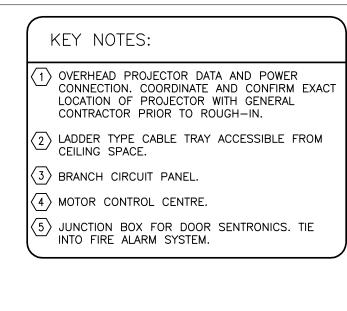

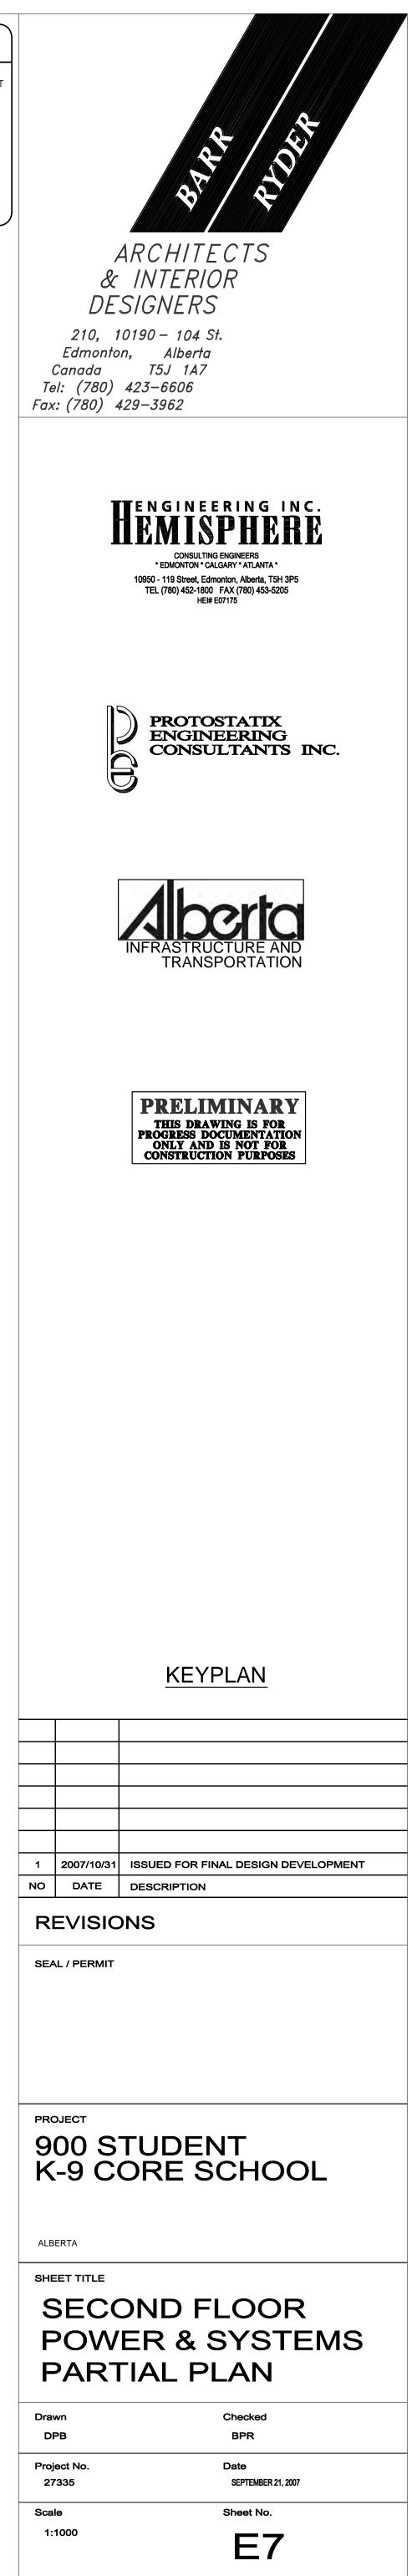

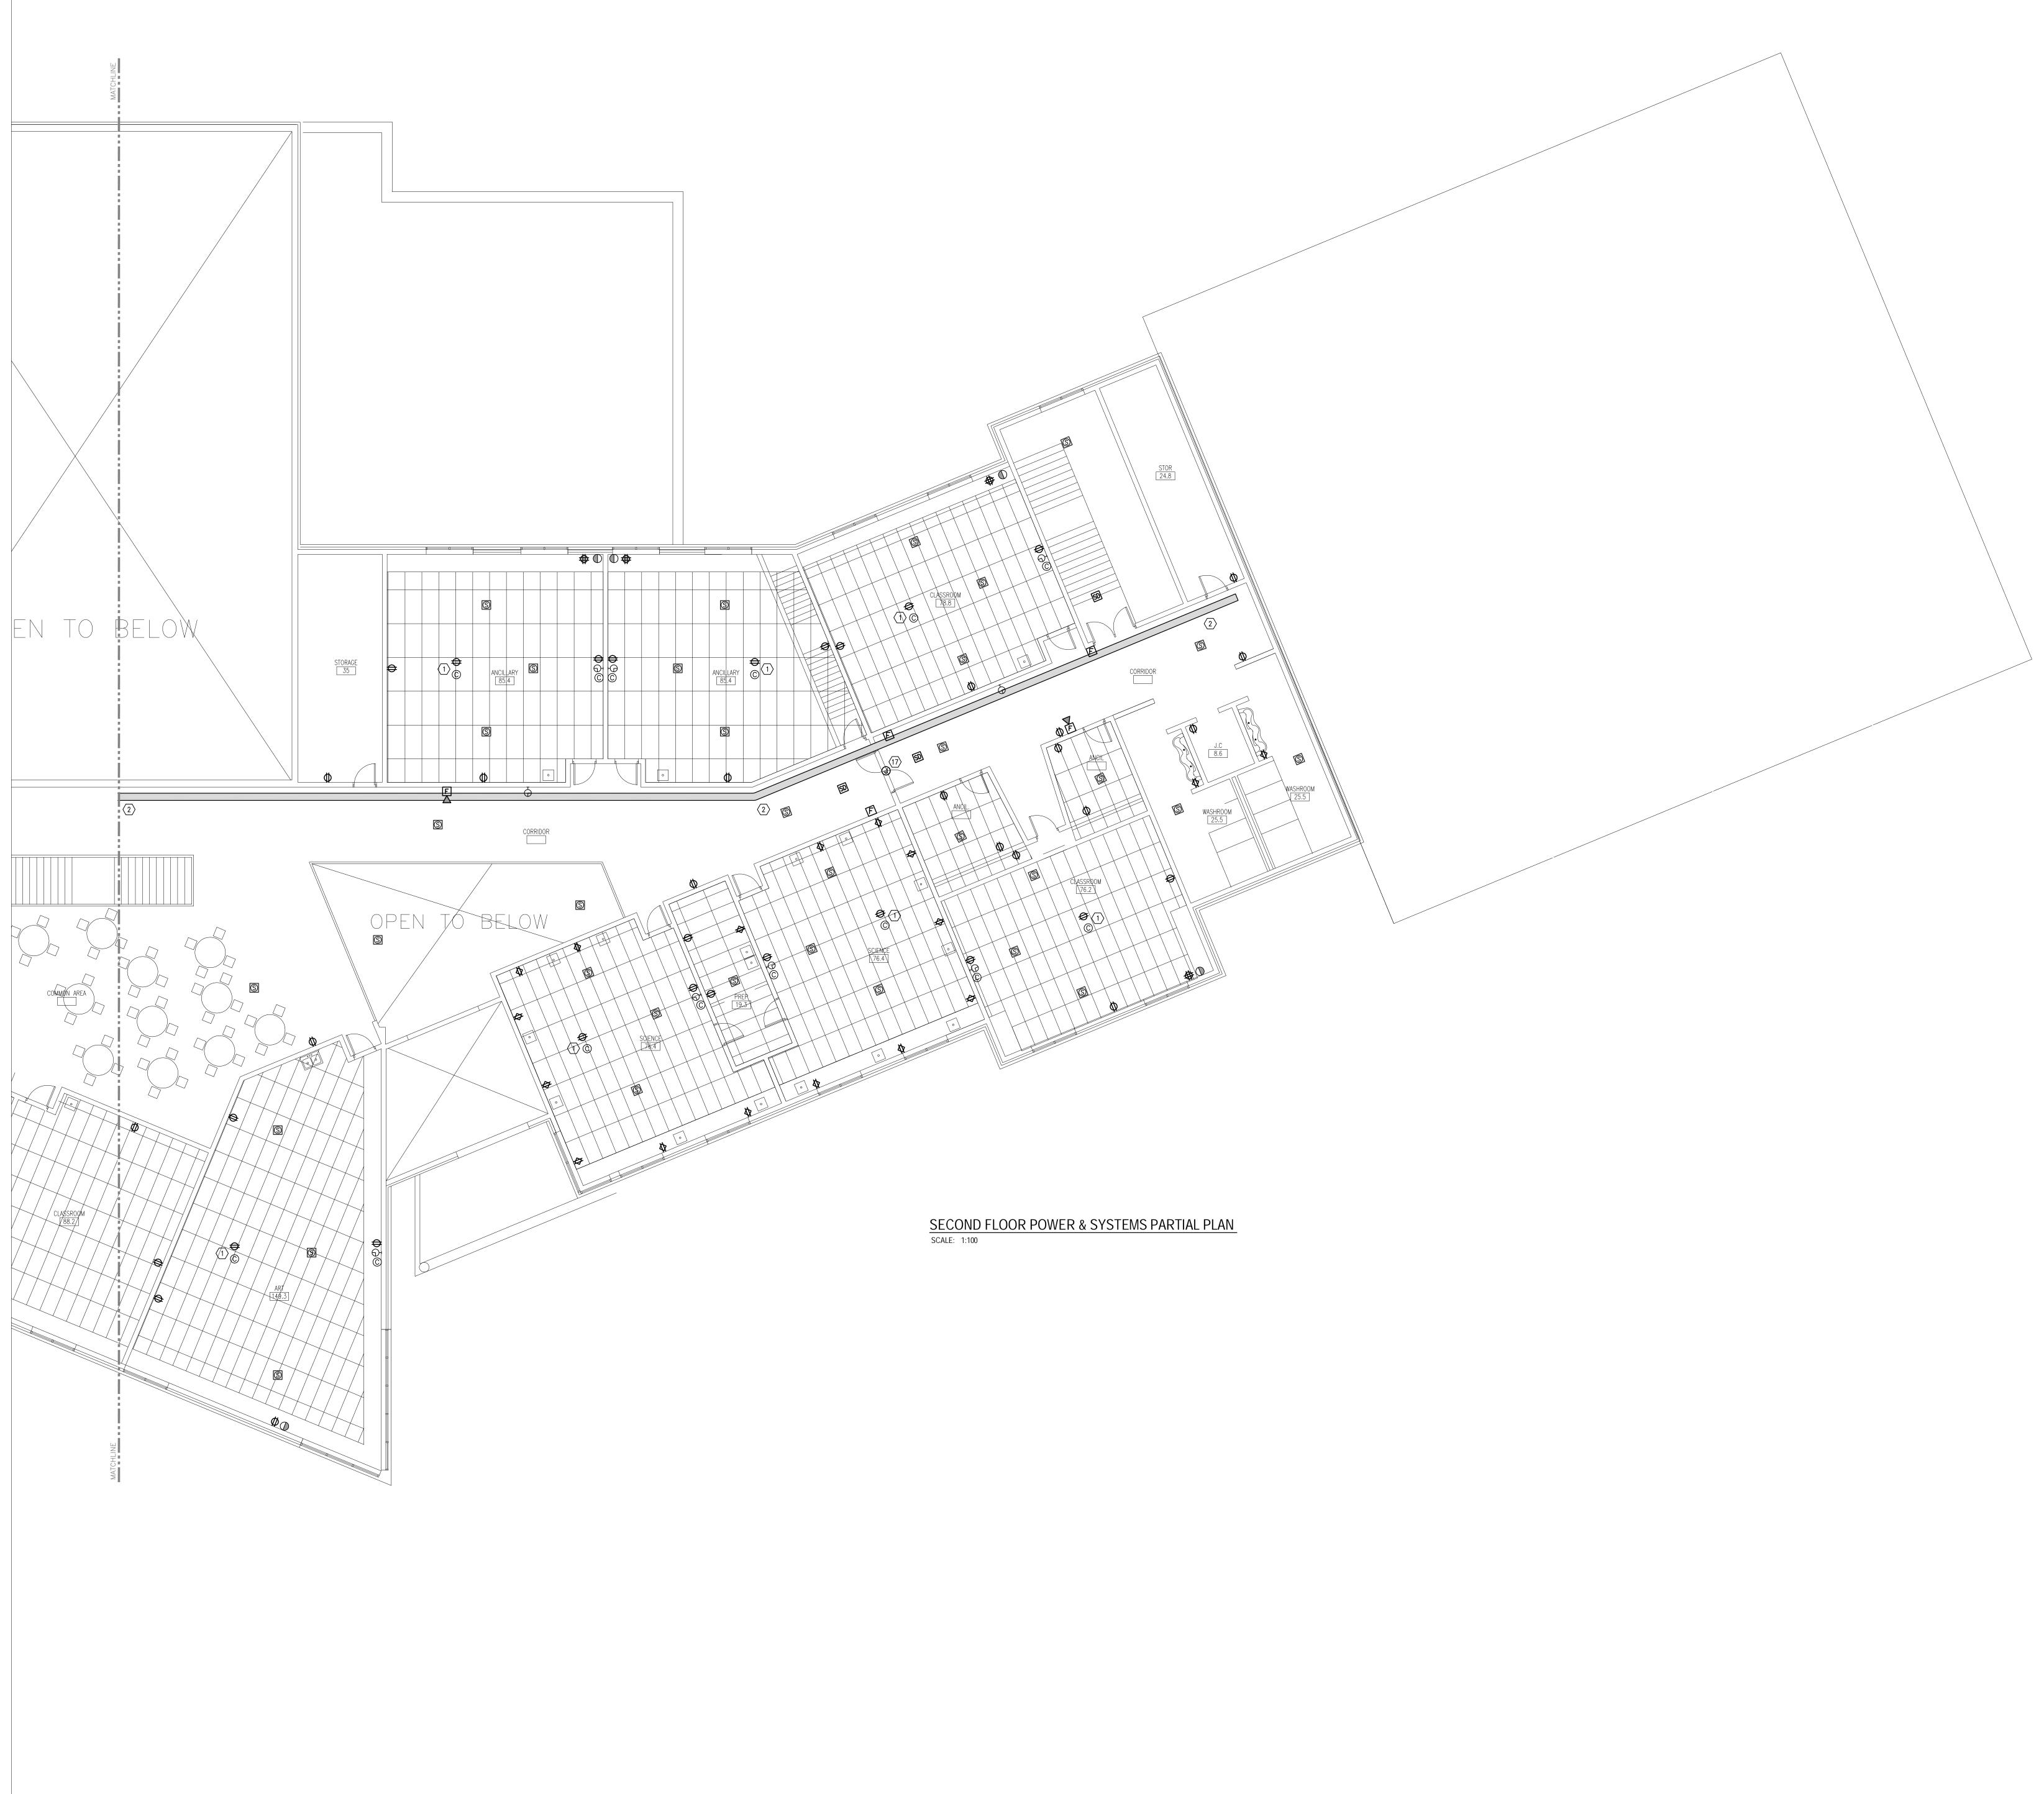

| KEY NOTES: |
|--|
| (1) OVERHEAD PROJECTOR DATA AND POWER CONNECTION. COORDINATE AND CONFIRM EXACT LOCATION OF PROJECTOR WITH GENERAL CONTRACTOR PRIOR TO ROUGH-IN. |
| 2 LADDER TYPE CABLE TRAY ACCESSIBLE FROM CEILING SPACE. |
| 3 BRANCH CIRCUIT PANEL. |
| 4 MOTOR CONTROL CENTRE. |
| 5 JUNCTION BOX FOR DOOR SENTRONICS. TIE INTO FIRE ALARM SYSTEM. |
| |

